
CITY OF THORNTON BID DOCUMENTS THORNTON JUSTICE CENTER EXPANSIVE SUBGRADE MITIGATION PROJECT

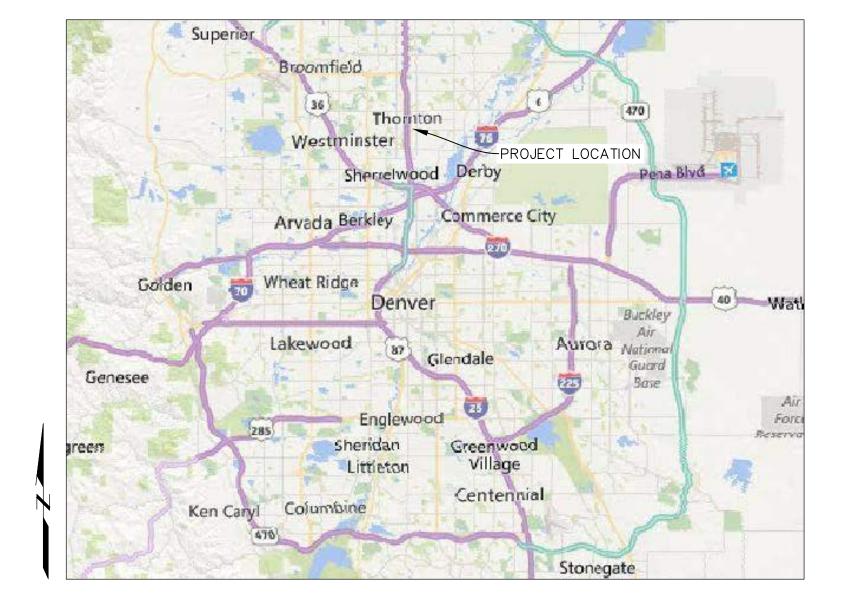

VICINITY MAP

0 5 10 SCALE IN MILES

GENERAL PROJECT INFORMATION

CITY OF THORNTON, COLORADO OWNER

CONTRACTOR

RJH CONSULTANTS, INC., ENGLEWOOD, COLORADO ENGINEER

CITY OF THORNTON APPROVALS

DocuSigned by:		
Pete Brezall	1/18	/2024
PROJECT MANAGER – PETE BREZALL DocuSigned by:		DATE
Daniel Schiltz	1/18	/2024
INFRASING MANAGER - DANIEL SCHILTZ	, P.E.	DATE

PHASE III CONTRACT DRAWINGS THORNTON CIP 22-076 THORNTON, COLORADO



LOCATION MAP 0 500 1000 SCALE IN FEET







RJH CONSULTANTS, INC. ENGLEWOOD • COLORADO

www.rjh-consultants.com



I HEREBY CERTIFY THAT THESE PLANS FOR THE THRONTON JUSTICE CENTER EXPANSIVE SUBGRADE – PHASE II MITIGATION PROJECT WERE PREPARED BY ME (OR UNDER MY SUPERVISION) FOR THE OWNERS THEREOF.

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SHEET NO.

REGISTERED ENGINEER RJH CONSULTANTS, INC.

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ROBERT J. HUZJAK, P.E. COLORADO P.E. NO.25734

DWG. NO. A-01

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-	1	2
		LEGEND
DETAIL	A-03	DETAIL TITLE. THE LETTER "A" REFERS TO THE DETAIL DESIGNATION. THE NUMBER "A-03" REFERS TO THE DRAWING NUMBER WHERE THE DETAIL IS CALLED OUT.
SECTION	1 A-03	SECTION TITLE. THE NUMBER "1" REFERS TO THE SECTION DESIGNATION. THE NUMBER "A -03 " REFERS TO THE DRAWING NUMBER WHERE THE SECTION IS CALLED OUT.
	1 A-03	SECTION LOCATION. THE NUMBER "1" REFERS TO THE SECTION DESIGNATION. THE NUMBER "A -03 " REFERS TO THE DRAWING NUMBER WHERE THE SECTION IS SHOWN.
A-03	\sum	DETAIL LOCATION. THE LETTER "A" REFERS TO THE DETAIL DESIGNATION. THE NUMBER "A-03" REFERS TO THE DRAWING NUMBER WHERE THE DETAIL IS SHOWN.
	uuuu	APPROXIMATE TREE AND SHRUB LIMITS
	\bigcirc	INDIVIDUAL SHRUB OR TREE
		EXISTING INDEX TOPOGRAPHIC CONTOUR WITH ELEVATION IN FEET
		EXISTING INTERMEDIATE TOPOGRAPHIC CONTOUR
		SURVEY CONTROL POINT
	-	SURVEY MONUMENT
	*	EXISTING TREE
	\rightarrow	REMOVE SIGN
	\bigotimes	REMOVE BOLLARD
	$\sim\sim\sim\sim$	REMOVE STORM SEWER
	·	LIMIT OF SITE DISTURBANCE (PROJECT LIMITS)
	?	CENTERLINE APPROXIMATE GEOLOGIC CONTACT
	<u>₹</u>	APPROXIMATE WATER LEVEL
	— OHE ———	EXISTING OVERHEAD ELECTRIC
—— E	——————————————————————————————————————	EXISTING UNDERGROUND ELECTRIC
		UNDERGROUND BRANCH ELECTRIC
		UNDERGROUND CONDUIT
		EXISTING WATER LINE
		EXISTING COMMUNICATIONS EXISTING TELEPHONE
	STORM	EXISTING STORM SEWER
	×	
	· · · · ·	FLOW LINE
B-	101(P) 🔶	RJH BORING COMPLETED AS A MONITORING WELL
	B-201 -	
UP-201 I		RJH UTILITY POTHOLE LOCATION
		RJH POTHOLE LOCATION
Г	(IP) —	INLET PROTECTION

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ABBREVIATIONS

CONCRETE MASONRY UNI CONC = CONCRETE CONT = CONTINUOUS CP = CONTROL POINT DEG = DECREE OR DEGREES DIA = DIAMETER DWG, DWGS = DRAWING OR DRAWINGS E = EAST OR EASTING EA = EACH EPS = EXPANDED POLYSTRENE EL, ELEV = ELEVATION EXST = EXISTING FL = FLOWLINE FT = FEET OR FOOT H = HORIZONTAL HDPE = HIGH DENSITY POLYETHYI INV = INVERT CONCRETE MASON FILTER SAND CONCRETE PAVING CONCRETE PA				
CONT = CONTINUE FOR THE PROJECT SUB- CONTINUE FOR DECRETES DECOMPANIES SUBJECT OF DECOMPOSITION FOR THE PROJECT OF DECOMPOSITION OF DEFAMINGS OF DE	RIPRAP, RIVER ROCK, OR AGGREGATE BASE COU	IRSE	CJ CL, Q CLR CMP CMU	 = CONSTRUCTION JOINT = CENTERLINE = CLEAR = CORRUGATED METAL PIPE = CONCRETE MASONRY UNI
ROCK EPS = EXPANDED POLYSTRENE ROCK EL, ELEV = ELEVATION STRUCTURAL EN = FAUSTING CONGRETE HOPE = HIGH DENSITY POLYETHY STRUCTURAL INV = HORZONTAL CONGRETE IF = UNEAR FOOT MAX MAXM MAXMMM MSW = MICHANICALLY STABILIZE MIN = MINMUM MAX MAX MAXMMM MAXMMM MAYD NORTH AMERICAN VERTOR NORD FILTER SAND NORTH AMERICAN VERTOR NORD GONCRETE PAVING STATICESS = SUBSURFACE UTUTY CHORIDE CONCRETE PAVING SS = STAINLESS STELL GEOMEMBRANE LINER 1. THE HORIZONTAL COORDINATES SYSTEM FOR THE PROJECT GEOMEMBRANE LINER	EARTH		CONT CP DEG DIA DWG, DWGS E	 CONTINUOUS CONTROL POINT DEGREE OR DEGREES DIAMETER DRAWING OR DRAWINGS EAST OR EASTING
STRUCTURAL HDPE = HIGH DENSITY POLYETHYD CONCRETE INV = INVERT LF = LINEAR FOOT MAX = MAXIMUM NAD = NORTH AMERICAN VERTIC NDD = NORTH AMERICAN VERTIC NGS = NORTH AMERICAN VERTIC NGYD = NORTH AMERICAN VERTICA NGYD = NORTH AMERICAN VERTICA OC = OUALITY LEVEL (AS IT PI R REINF = REINFORCEMENT ST ST = STATION ST = STATION ST ST = STATION	ROCK		EPS EL, ELEV EW EXST FL FT	 = EXPANDED POLYSTRENE = ELEVATION = EACH WAY = EXISTING = FLOWLINE = FEET OR FOOT
FILTER SAND NAVD = NORTH AMERICAN VERTION NG NGS = NATIONAL GEODETIC SUR NGVD = NATIONAL GEODETIC SUR NGVD = NATIONAL GEODETIC VERTION OC = ON CENTER PVC = POLYVINYL CHLORIDE QL = QUALITY LEVEL (AS IT PIRTICAL R = RADIUS CONCRETE PAVING REINF REINF = REINFORCEMENT SS = STAINLESS STEEL STA = STATION STL = STEEL SUE = SUBSURFACE UTILITY ENCITAB TABB TOP & BOTTOM TYP TYPICAL V = VERTICAL GEOMEMBRANE LINER 1. THE HORIZONTAL COORDINATES SYSTEM FOR THE PROJECT 0.999721940. THE VERTICAL DATUM IS NAVD88. SURVEY W 2. UTILITIES ARE DEPICTED IN GENERAL ACCORDANCE WITH THOF CIVIL ENGINEER'S DOCUMENT ASCE 38 "STANDARD GUID TYPE 1 BROOM FINISHED CONCRETE DATA" AND SHOWN ON DRAWING A-03. CONTRACTOR SREMOVAL OR REPLACEMENT.			HDPE INV LF MAX MSEW MIN	 HIGH DENSITY POLYETHYL INVERT LINEAR FOOT MAXIMUM MECHANICALLY STABILIZE MINIMUM
QL = QUALITY LEVEL (AS IT PERPENDING REINF = RADIUS REINF = REINFORCEMENT SS = STAINLESS STEEL STA = STAINLESS STEEL STA = STAINLESS STEEL STA = SUBSURFACE UTILITY END TWP = TOP & BOTTOM TYP = TYPICAL V = VERTICAL GEOMEMBRANE LINER 1. THE HORIZONTAL COORDINATES SYSTEM FOR THE PROJECT 0.999721940. THE VERTICAL DATUM IS NAVD88. SURVEY W 2. UTILITIES ARE DEPICTED IN GENERAL ACCORDANCE WITH TH OF CIVIL ENGINEER'S DOCUMENT ASCE 38 "STANDARD GUID UTILITY DATA" AND SHOWN ON DRAWING A-03. CONTRACTOR DRAWINGS OR NOT, PRIOR TO EXCAVATION. CONTRACTOR S TYPE 1 BROOM FINISHED CONCRETE REMOVAL OR REPLACEMENT.	FILTER SAND		NAVD N NGS NGVD OC	 NORTH AMERICAN VERTIC NORTH OR NORTHING NATIONAL GEODETIC SURY NATIONAL GEODETIC VERTICAL ON CENTER
ASPHALT PAVING TYP = TYPICAL V = VERTICAL GEOMEMBRANE LINER GEOMEMBRANE LINER 1. THE HORIZONTAL COORDINATES SYSTEM FOR THE PROJECT 0.999721940. THE VERTICAL DATUM IS NAVD88. SURVEY W 2. UTILITIES ARE DEPICTED IN GENERAL ACCORDANCE WITH THOF CIVIL ENGINEER'S DOCUMENT ASCE 38 "STANDARD GUID UTILITY DATA" AND SHOWN ON DRAWING A-03. CONTRACTOR SREMOVAL OR REPLACEMENT.	CONCRETE PAVING		QL R REINF SS STA STL SUE	 QUALITY LEVEL (AS IT PE RADIUS REINFORCEMENT STAINLESS STEEL STATION STEEL SUBSURFACE UTILITY ENCOMPOSITION
GEOMEMBRANE LINER 1. THE HORIZONTAL COORDINATES SYSTEM FOR THE PROJECT 0.999721940. THE VERTICAL DATUM IS NAVD88. SURVEY W 2. UTILITIES ARE DEPICTED IN GENERAL ACCORDANCE WITH TH OF CIVIL ENGINEER'S DOCUMENT ASCE 38 "STANDARD GUID UTILITY DATA" AND SHOWN ON DRAWING A-03. CONTRACTOR TYPE 1 BROOM FINISHED CONCRETE TYPE 1 BROOM	ASPHALT PAVING		TYP	= TYPICAL
GEOMEMBRANE LINER0.999721940. THE VERTICAL DATUM IS NAVD88. SURVEY W2. UTILITIES ARE DEPICTED IN GENERAL ACCORDANCE WITH THOF CIVIL ENGINEER'S DOCUMENT ASCE 38 "STANDARD GUID UTILITY DATA" AND SHOWN ON DRAWING A-03. CONTRACTOR DRAWINGS OR NOT, PRIOR TO EXCAVATION. CONTRACTOR S REMOVAL OR REPLACEMENT.		GENERAL NO	TES	
OF CIVIL ENGINEER'S DOCUMENT ASCE 38 "STANDARD GUID UTILTIY DATA" AND SHOWN ON DRAWING A-03. CONTRACTO DRAWINGS OR NOT, PRIOR TO EXCAVATION. CONTRACTOR S FINISHED CONCRETE REMOVAL OR REPLACEMENT.	GEOMEMBRANE LINER			
	FINISHED CONCRETE	OF CIVIL ENGINEER UTILTIY DATA" ANI DRAWINGS OR NOT	'S DOCUMENT) SHOWN ON ; PRIOR TO E	- ASCE 38 "STANDARD GUID DRAWING A-03. CONTRACTO

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TYPE 2 DECORATIVE SANDSCAPE CONCRETE

> TYPE 3 EXPOSED AGGREGATE CONCRETE WITH LIGHT GRAY COLOR

> WITH SANDSTONE COLOR

TYPE 6 BROOM FINISHED

graphite color

CONCRETE WITH DESERT TAN COLOR

TYPE 5 CONCRETE SEATWALL WITH SANDSCAPE FINISH WITH





UGATED METAL PIPE RETE MASONRY UNIT

DENSITY POLYETHYLENE

ANICALLY STABILIZED EARTH RETAINING WALL

AMERICAN DATUM AMERICAN VERTICAL DATUM

NAL GEODETIC SURVEY NAL GEODETIC VERTICAL DATUM

ITY LEVEL (AS IT PERTAINS TO ASCE 38-02)

JRFACE UTILITY ENGINEERING

FOR THE PROJECT IS MODIFIED COLORADO STATE PLANE NAD83. CONVERSION FACTOR IS NAVD88. SURVEY WAS COMPLETED BY GEOSURV, INC IN 2014.

CORDANCE WITH THEIR ACHIEVED QUALITY LEVELS AS DEFINED IN THE AMERICAN SOCIETY 38 "STANDARD GUIDELINE FOR THE COLLECTION AND DEPICTION OF EXISTING SUBSURFACE IG A-03. CONTRACTOR SHALL FIELD LOCATE ALL UTILITIES, WHETHER SHOWN ON THE TION. CONTRACTOR SHALL PROTECT ALL UTILITIES IN PLACE UNLESS DESIGNATED FOR

> THORNTON JUSTICE CENTER PHASE III

LEGEND ABBREVIATIONS AND GENERAL NOTES

SHEET NO. 2 of 46

DWG. NO.

A-02

STRUCTURAL NOTES

1) REINFORCEMENT SYMBOLS

BARS SH	HOWN THUS → #8 @ 1'-0" OR # 8	@ 1'-0"
INDICATE	A GROUP OF IDENTICAL $\#8$ bars spaced at 1'-0'	"(12") CENTERS.
0	AN OPEN CIRCLE AT THE END OF A BAR INDICATES BEND WITH THE BAR TURNED AWAY FROM THE OBSE	A RVER.
•	A CLOSED CIRCLE AT THE END OF A BAR INDICATES BEND WITH THE BAR TURNED TOWARDS THE OBSERV	

INDICATES A DOWEL

A BEND IN THE BAR.

2) DIMENSIONS

0

DIMENSIONS ARE TO THE CENTERLINES OF THE BARS UNLESS OTHERWISE SHOWN. CLEAR COVER DIMENSIONS ARE MARKED "CLR." ALL DIMENSIONS TO A JOINT ARE TO THE CENTERLINE OF THE JOINT. BEAMS, COLUMNS, AND WALLS ARE CENTERED ON REFERENCED LINES. THICKNESS SHOWN FOR WALLS AND SLABS ADJACENT TO UNDISTURBED SOIL OR ROCK ARE MINIMUM DIMENSIONS.

3) COVER

UNLESS OTHERWISE INDICATED ON THE DRAWING, PLACE THE REINFORCEMENT SO THAT THE CLEAR DISTANCE BETWEEN THE FACE OF CONCRETE AND NEAREST REINFORCEMENT IS 3 INCHES FOR #5 BARS OR LARGER. FOR CONCRETE PLACED DIRECTLY AGAINST EARTH OR ROCK. MINIMUM CLEAR CONCRETE COVER OVER REINFORCEMENT SHALL BE 3 INCHES.

4) REINFORCEMENT DOWELS

DOWELS INDICATED ON THE DRAWING SUCH AS #8(D), SHALL HAVE A MINIMUM STRAIGHT EMBEDMENT AND PROJECTION EQUAL TO THAT REQUIRED FOR LAP SPLICING A BAR OF THE SAME DIAMETER.

5) PLAIN DOWELS

PLAIN DOWELS, INDICATED ON THE DRAWINGS SUCH AS 3/4" (PD), ACROSS CONTRACTION JOINTS SHALL BE PLAIN REINFORCING BARS OF THE BAR DIAMETER INDICATED. PLAIN DOWELS SHALL BE A MINIMUM OF 36 INCHES LONG, WITH EQUAL LENGTH EXTENDING ON EITHER SIDE OF THE CONTRACTION JOINT. IMMEDIATELY BEFORE THE SECOND CONCRETE PLACEMENT, THE PROJECTING HALF LENGTH OF DOWEL SHALL BE GREASED TO PREVENT BOND TO THE CONCRETE.

6) STANDARD HOOKS AND BENDS

HOOKS AND BENDS SHALL CONFORM TO ACI 318, SECTION 25.3.

7) PLACING REINFORCEMENT

PLACE REINFORCEMENT IN ACCORDANCE WITH APPROVED REINFORCEMENT SHOP DRAWINGS. IN THE EVENT OF A CONFLICT BETWEEN THESE DRAWINGS AND THE APPROVED SHOP DRAWINGS, THE APPROVED SHOP DRAWINGS SHALL GOVERN.

SEE ACI 318, SECTION 25.2 AND ACI 301, SECTION 5.3 FOR PLACING TOLERANCES.

REINFORCEMENT MAY BE ADJUSTED IN THE FIELD TO CLEAR FORM TIES AND ANCHOR BARS. IN SUCH CASES, RELOCATION OF THE EMBEDDED MATERIALS MUST BE CONSIDERED. IN NO CASE SHALL BARS BE BENT IN THE FIELD.

REINFORCEMENT SHALL BE PLACED TO MAINTAIN A CLEAR DISTANCE OF AT LEAST 1 INCH BETWEEN OTHER REINFORCEMENT, ANCHOR BOLTS, FORM TIES, OR OTHER EMBEDDED METALWORK.

REINFORCEMENT PARALLEL TO ANCHOR BOLTS OR OTHER EMBEDDED METALWORK SHALL BE PLACED TO MAINTAIN A CLEAR DISTANCE OF AT LEAST 1-1/3 TIMES THE MAXIMUM SIZE AGGREGATE TO BE USED.

8) SPACING

THE FIRST AND LAST BARS IN SLABS AND WALLS, STIRRUPS IN BEAMS, AND TIES IN COLUMNS ARE TO START AND END AT A MAXIMUM OF ONE HALF OF THE ADJACENT BAR SPACING. ALL REINFORCING TO BE EQUALLY SPACED UNLESS OTHERWISE SHOWN ON THE DRAWINGS.

9) ACCESSORIES

BAR SUPPORTS, SPACERS, AND OTHER ACCESSORIES ARE NOT SHOWN ON THE DRAWINGS. THE RECOMMENDATIONS OF ACI 315 (DETAILING MANUAL) SHALL BE USED IN SELECTING ACCESSORIES.

10) DETAILING

UNLESS OTHERWISE SHOWN, FOLLOW THE RECOMMENDATIONS OF ACI 315. NO CHANGES SHALL BE MADE WITHOUT PRIOR APPROVAL.

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11) CONCRETE PLACEMENT

BEFORE PLACING CONCRETE, CHECK ALL APPLICABLE DRAWINGS RELEASED AS SUITABLE FOR CONSTRUCTION INCLUDING MANUFACTURER'S DRAWINGS TO VERIFY THE PRESENCE OF ALL EMBEDDED MATERIAL REQUIRED IN THE PLACEMENT.

12) EMBEDMENT AND LAP SPLICE LENGTH REQUIREMENTS

EMBEDMENT LENGTHS AND LAP SPLICE LENGTHS ARE SHOWN IN THE TABLES BELOW.

BASIC EMBEDMENT LENGTHS ARE BASED ON ACI 318, SECTION 25.4 AND THE REQUIRED fc'.

ALL LAP SPLICE LENGTHS SHOWN ARE CLASS B SPLICES BASED ON ACI 318, SECTION 25.5.

UNLESS OTHERWISE SHOWN ON THE DRAWINGS, THE MINIMUM LENGTHS FOR EMBEDMENT AND LAP SPLICES FOR PARALLEL BARS SHALL BE AS GIVEN IN THE TABLE BELOW.

THE LENGTH OF THE LAP SHALL BE GOVERNED BY THE SMALLER DIAMETER BAR.

SPLICES ARE TO BE MADE SO THAT THE GIVEN CLEAR DISTANCES TO THE FACE OF CONCRETE WILL BE MAINTAINED.

13) EMBEDDED ITEMS AND OPENINGS

BEFORE PLACING CONCRETE, CARE SHALL BE TAKEN THAT ALL EMBEDDED ITEMS ARE IN POSITION AND SECURELY FASTENED IN PLACE. ADD ADDITIONAL REINFORCING AROUND OPENINGS AS SHOWN ON DRAWINGS.

14) FINISHING SYMBOLS AND CONCRETE TOLERANCES

FINISH SURFACES FOR ALL CONSTRUCTION AND CONTRACTION JOINTS SHALL BE PROVIDED IN ACCORDANCE WITH THE SPECIFICATIONS.

15) CHAMFER

UNLESS OTHERWISE INDICATED, CHAMFER EDGES OF ALL PERMANENTLY EXPOSED CONCRETE SURFACES WITH A 45 DEGREE BEVEL, 3/4 INCH X 3/4 INCH. CHAMFER STRIP MAY NOT BE SHOWN ON THE DESIGN DRAWINGS.

16) JOINTS

ALL CONSTRUCTION JOINTS, CONTRACTION JOINTS AND EXPANSION JOINTS SHALL BE PROVIDED WHERE SHOWN ON THE APPROVED SHOP DRAWINGS. NO OTHER JOINTS SHALL BE INTRODUCED UNLESS APPROVED BY THE ENGINEER.

17) STRUCTURAL STEEL

17a) GENERAL

FABRICATION AND ERECTION OF STRUCTURAL STEEL SHALL CONFORM TO CURRENT AISC STEEL CONSTRUCTION MANUAL. ALL REINFORCEMENT SHALL BE GRADE 60.

17b) BOLTED CONNECTIONS

ANCHOR AND NON-STRUCTURAL BOLTS AND NUTS SHALL BE ASTM A 307, STRUCTURAL BOLTS AND NUTS SHALL BE ASTM A 325. ALL BOLTED STRUCTURAL CONNECTIONS SHALL CONFORM TO THE AISC SPECIFICATION FOR STRUCTURAL JOINTS USING ASTM A 325 OR A 490 BOLTS. ALL BOLTS, NUTS AND WASHERS SHALL BE HOT-DIP GALVANIZED. ALL STRUCTURAL BOLTED CONNECTIONS SHALL BE BEARING-TYPE CONNECTIONS. ALL BOLTS EXPOSED TO WATER OR SUBMERGED SHALL BE SS TYPE 316.

17c) WELDING

CONFORM TO AWS D1.1. WELDING ELECTRODES FOR PLAIN STRUCTURAL STEEL SHALL BE AWS SERIES E-70. WELDING ELECTRODES FOR GALVANIZED STEEL SHALL BE AWS SERIES E6010 OR E6011.

17) BUILDING CODE

STRUCTURAL DESIGN IS SUBJECT TO INTERNATIONAL BUILDING CODE (IBC) 2021 AND CITY OF THORNTON STANDARDS AND SPECIFICATIONS.

TABLE OF BASIC EMBEDMENT AND LAP SPLICE LENGTHS ACCORDING TO ACI 318 fc' = 4000 PSI

BAR SIZE	EMBEDMENT (INCHES)		LAP SPLICE (INCHES)		
NO.	ALL BARS EXCEPT TOP BARS	TOP BARS*	ALL BARS EXCEPT TOP BARS	TOP BARS [*]	
3	1'-3"	1'-7"	1'-7"	2'-1"	
4	1'-7"	2'-1"	2'-1"	2'-9"	
5	2'-0"	2'-7"	2'-7"	3'-4"	
6	2'-5"	3'-1"	3'-1"	4'-0"	
7	3'-6"	4'-6"	4'-6"	5'-10"	
8	4'-0"	5'-2"	5'-2"	6'-9"	
9	4'-6"	5'-10"	5'-10"	7'-7"	
10	5'-1"	6'-7"	6'-7"	8'-7"	

TOP BARS ARE HORIZONTAL BARS IN BEAMS AND SLABS PLACED SO THAT MORE THAN 12 INCHES OF CONCRETE IS CAST IN THE MEMBER BELOW THE BAR.

WHEN REINFORCING BARS OF DIFFERENT SIZE ARE TO BE SPLICED,

				L
				33
				3
NSA	NSA	MSK	RJH	8
DES	DRN	СНК	APP	








THORNTON JUSTICE CENTER PHASE III


STRUCTURAL NOTES

A-03 SHEET NO.

DWG. NO.


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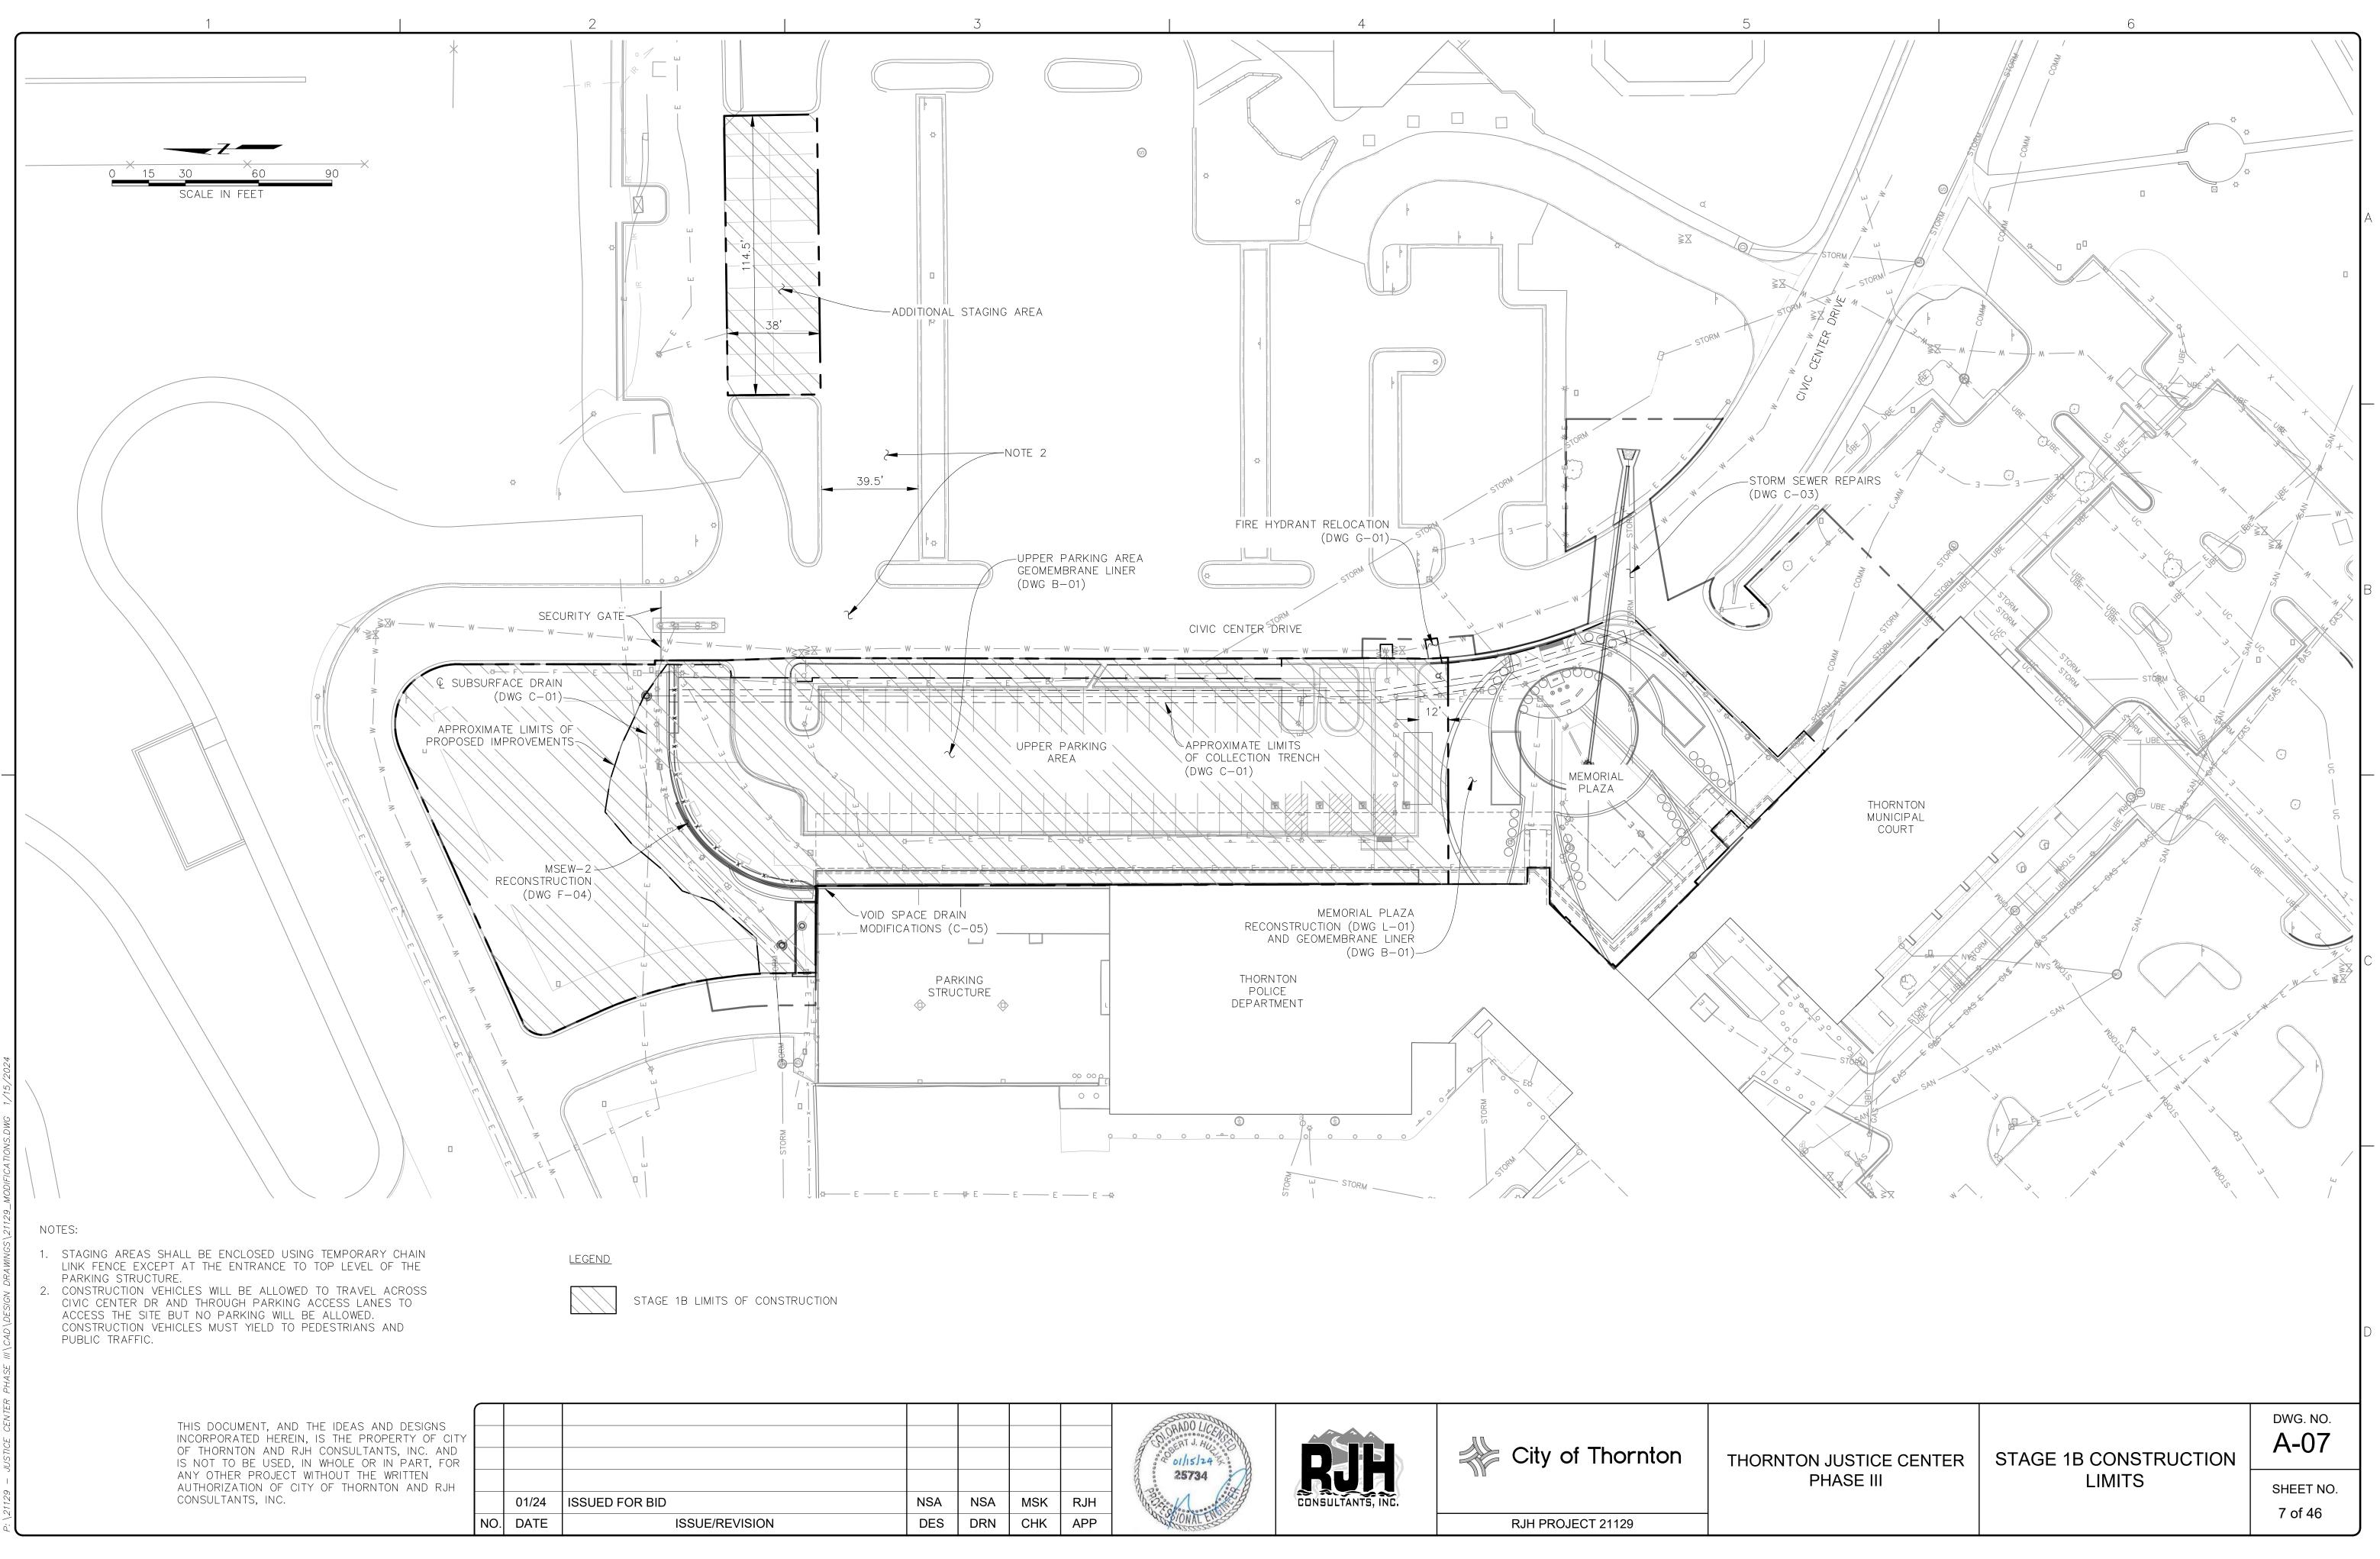


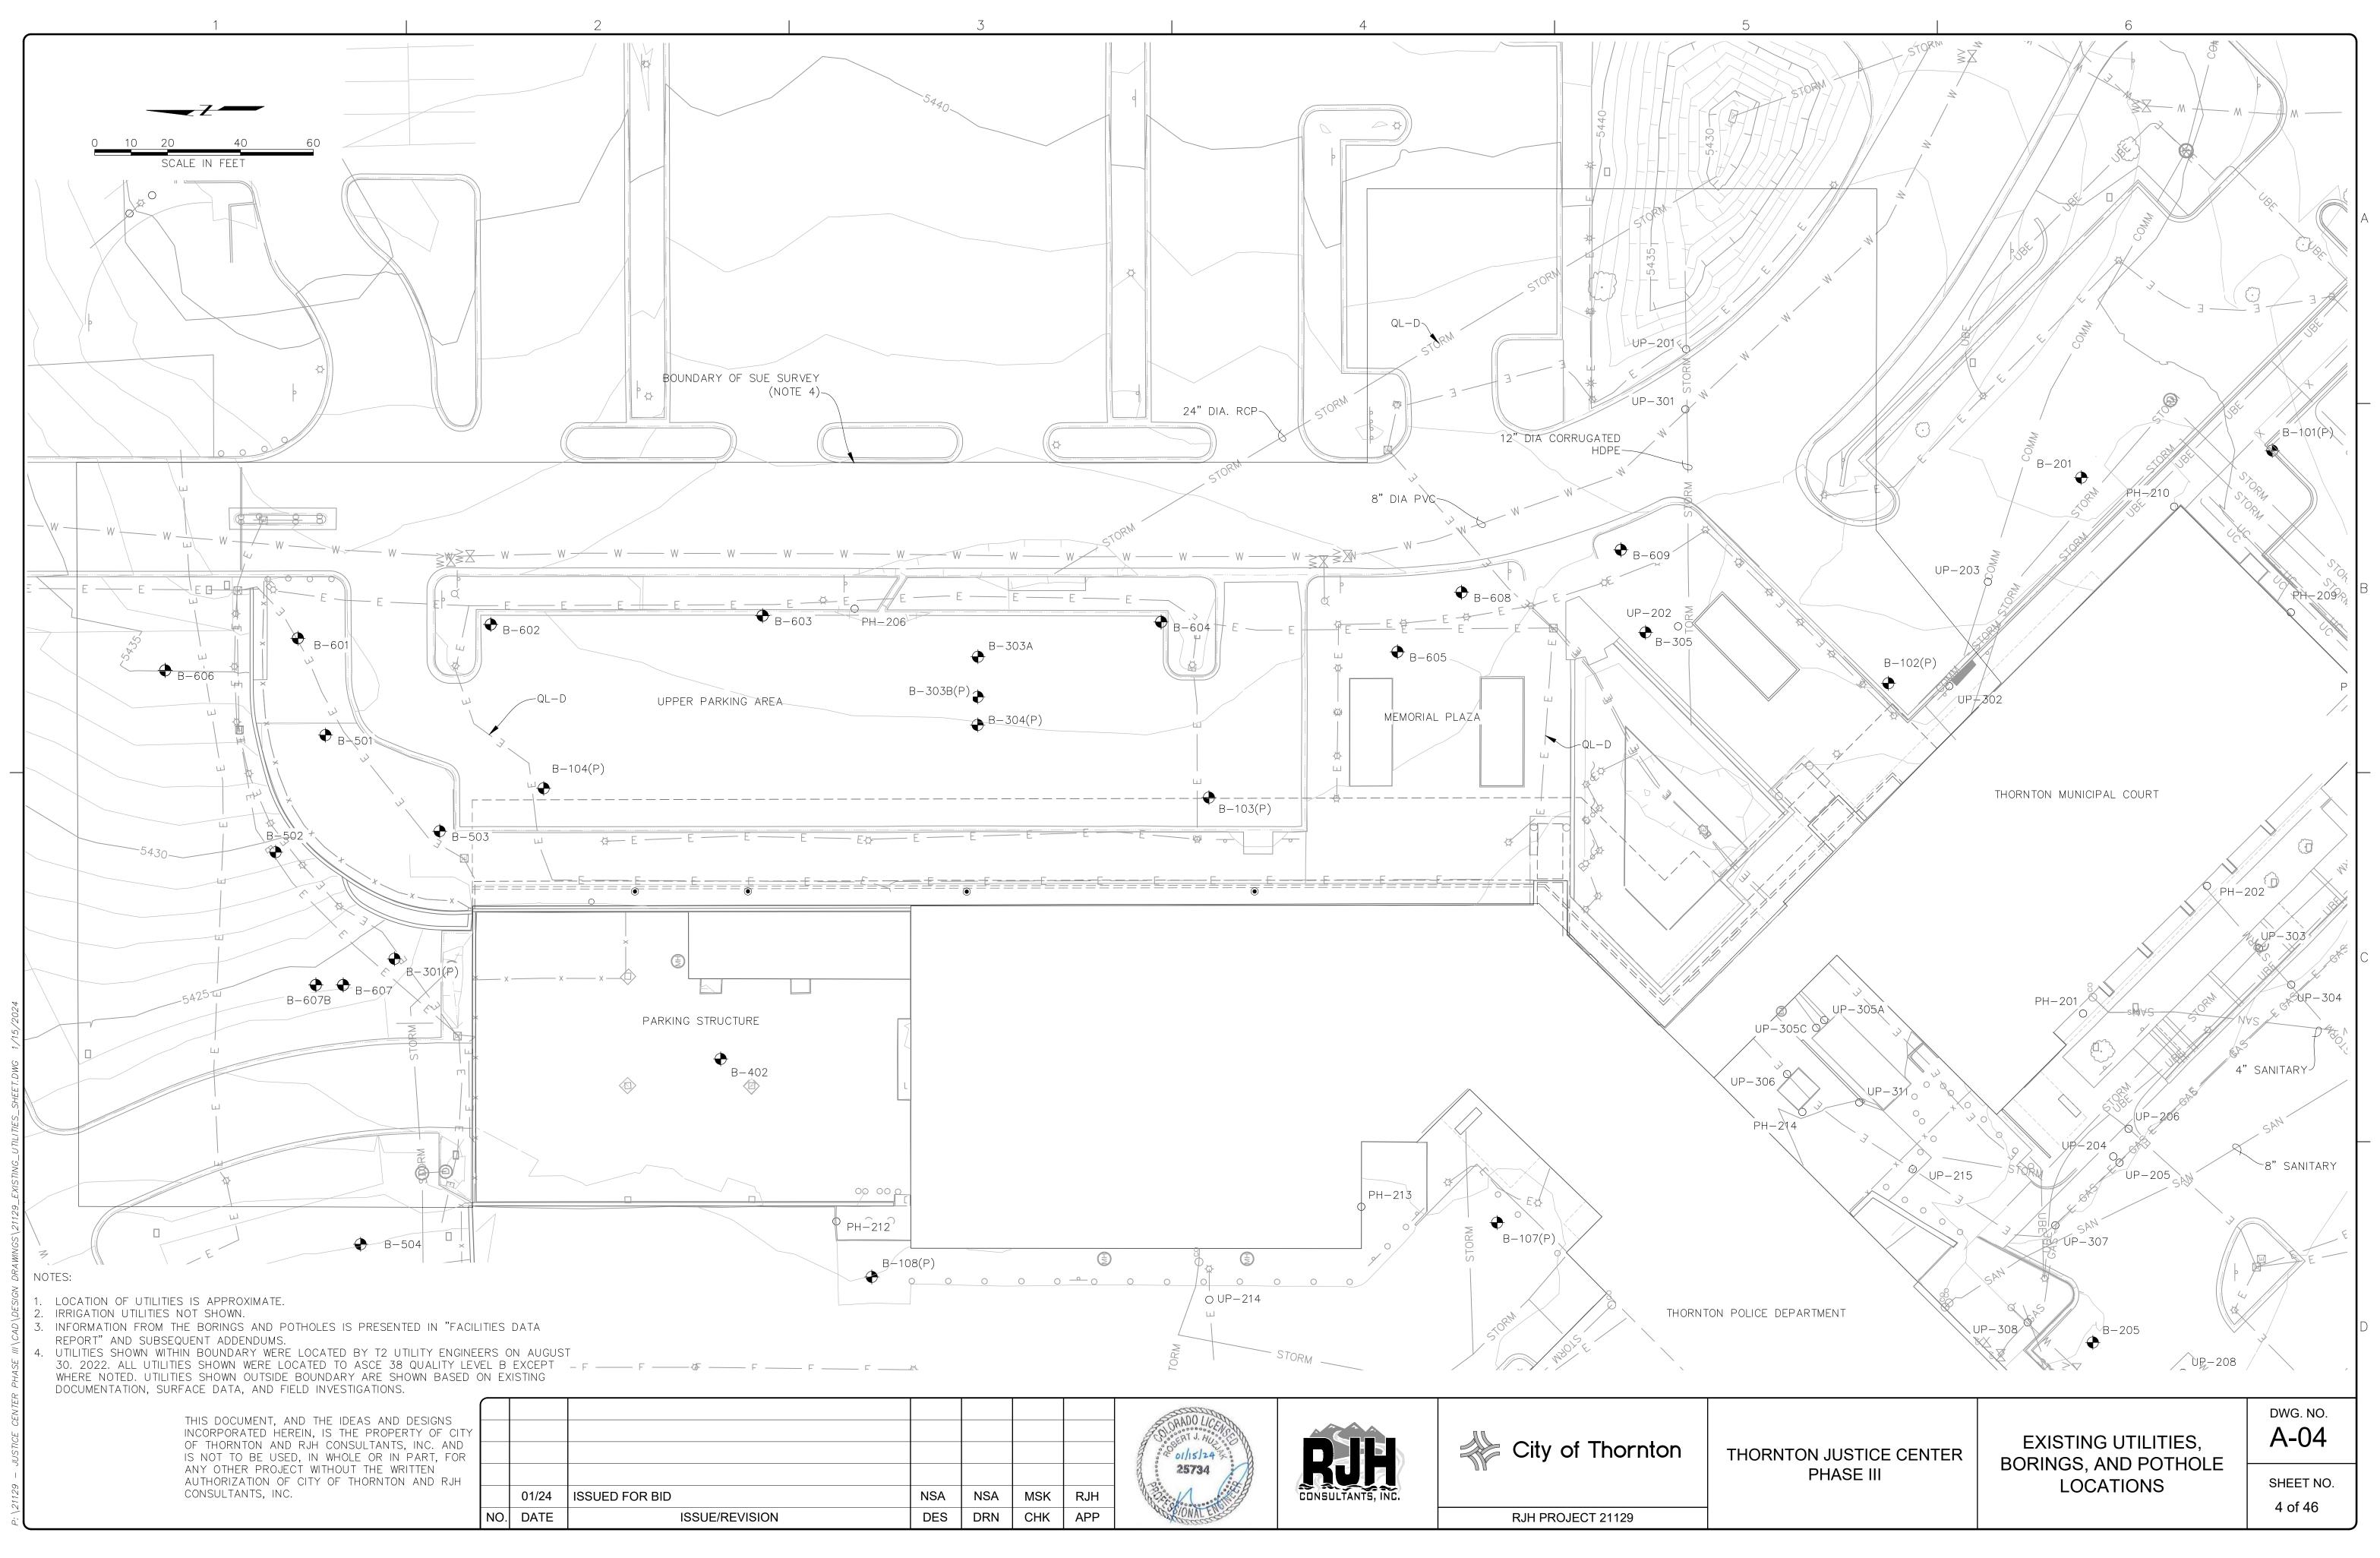


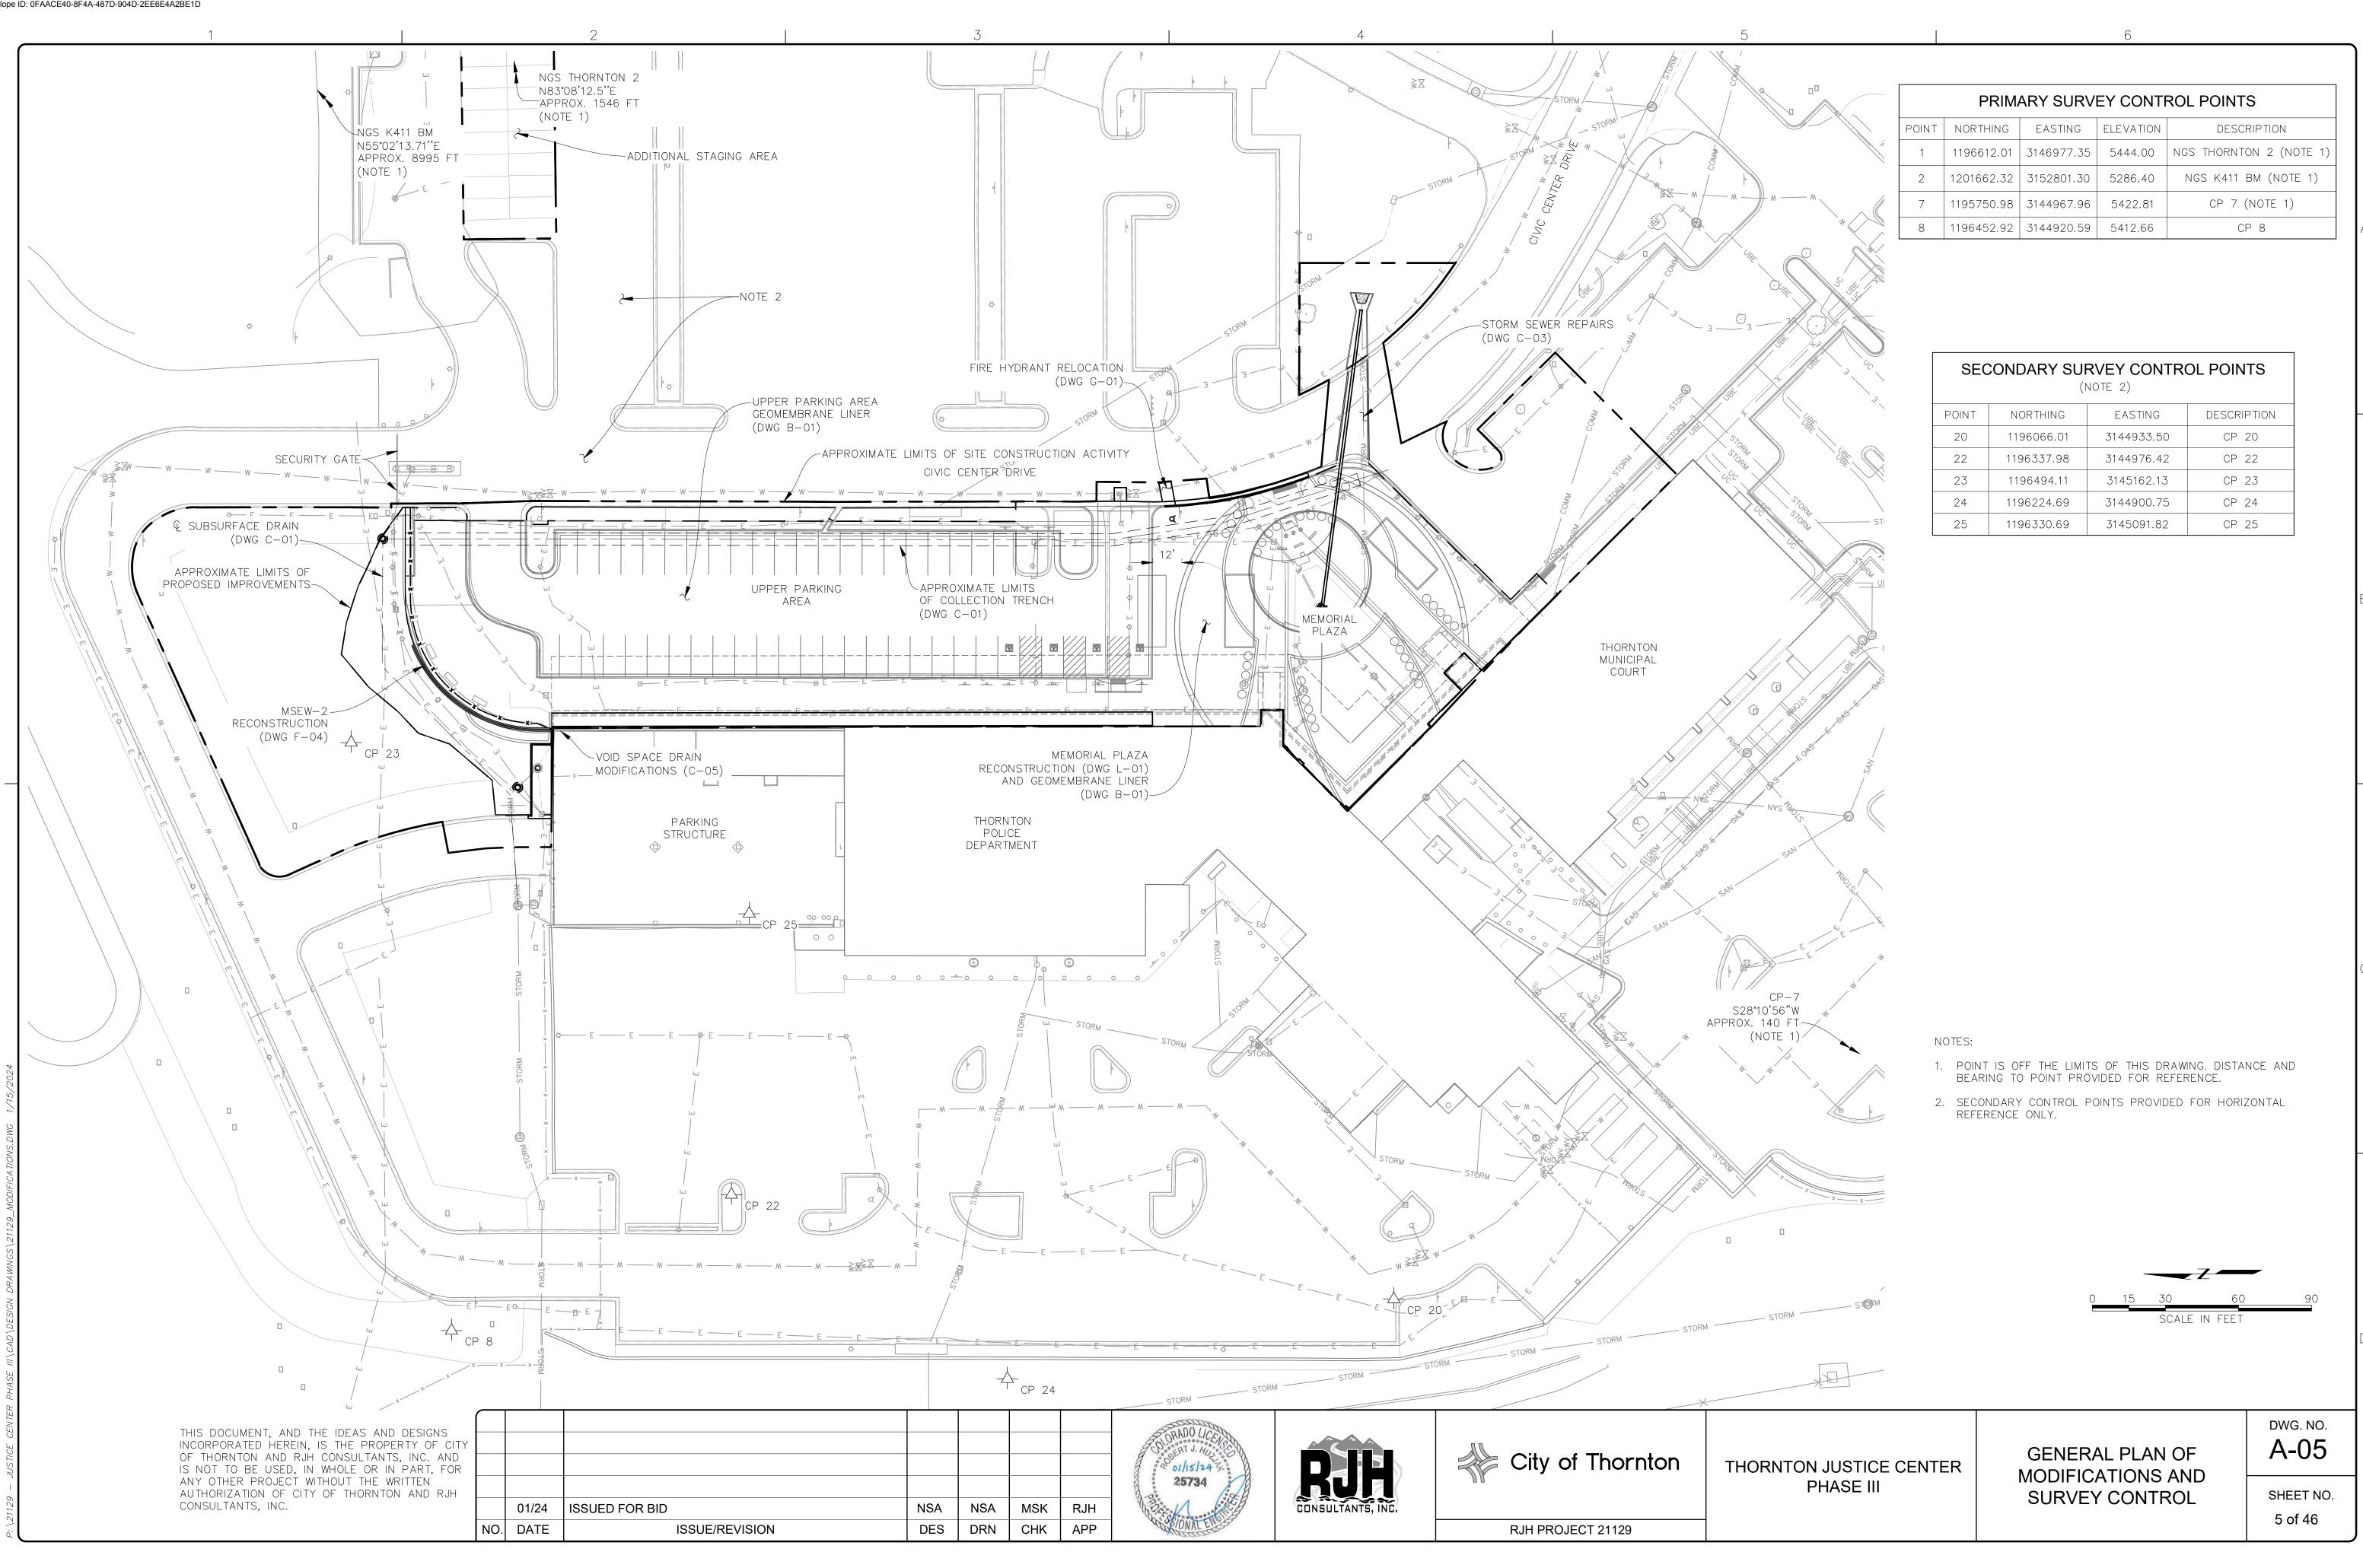
POINT	NORTHING	EASTING	ELEVATION	DESCRIPTION
1	1196612.01	3146977.35	5444.00	NGS THORNTON 2 (NOTE 1)
2	1201662.32	3152801.30	5286.40	NGS K411 BM (NOTE 1)
7	1195750.98	3144967.96	5422.81	CP 7 (NOTE 1)
8	1196452.92	3144920.59	5412.66	CP 8

SECONDARY SURVEY CONTROL POINTS (NOTE 2)						
POINT	NORTHING	EASTING	DESCRIPTION			
20	1196066.01	3144933.50	CP 20			
22	1196337.98	3144976.42	CP 22			
23	1196494.11	3145162.13	CP 23			
24	1196224.69	3144900.75	CP 24			
25	1196330.69	3145091.82	CP 25			




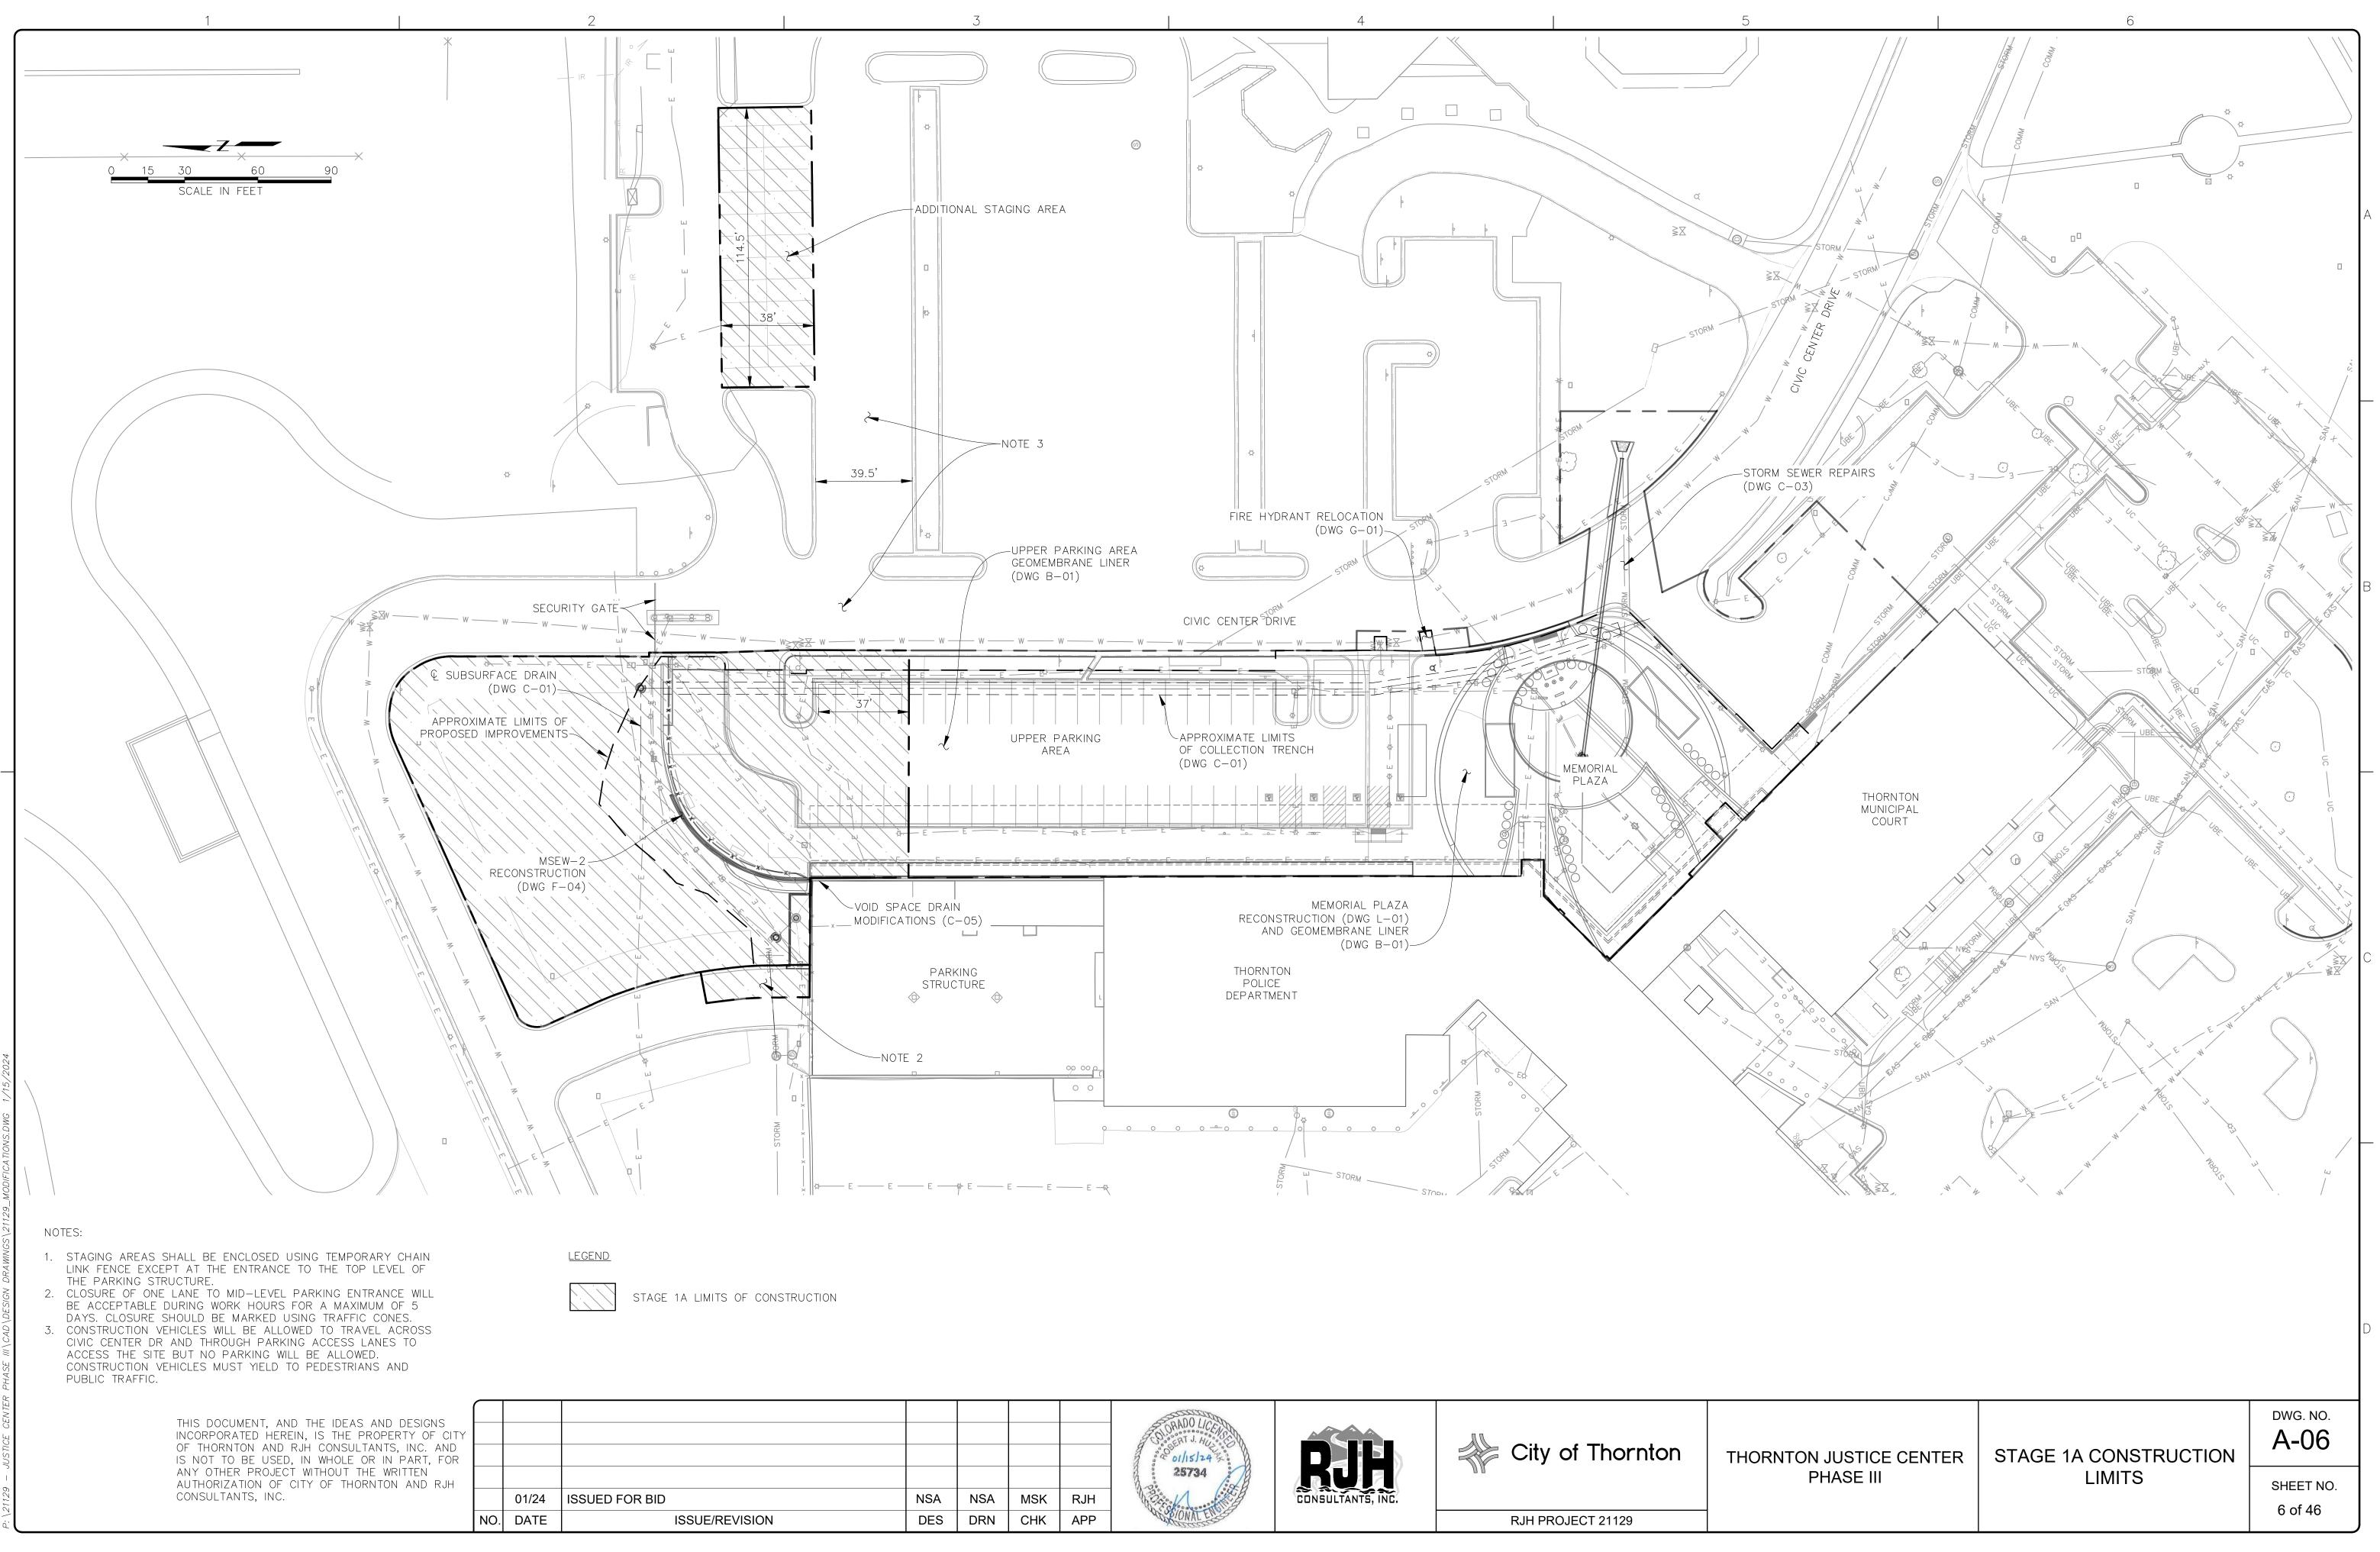


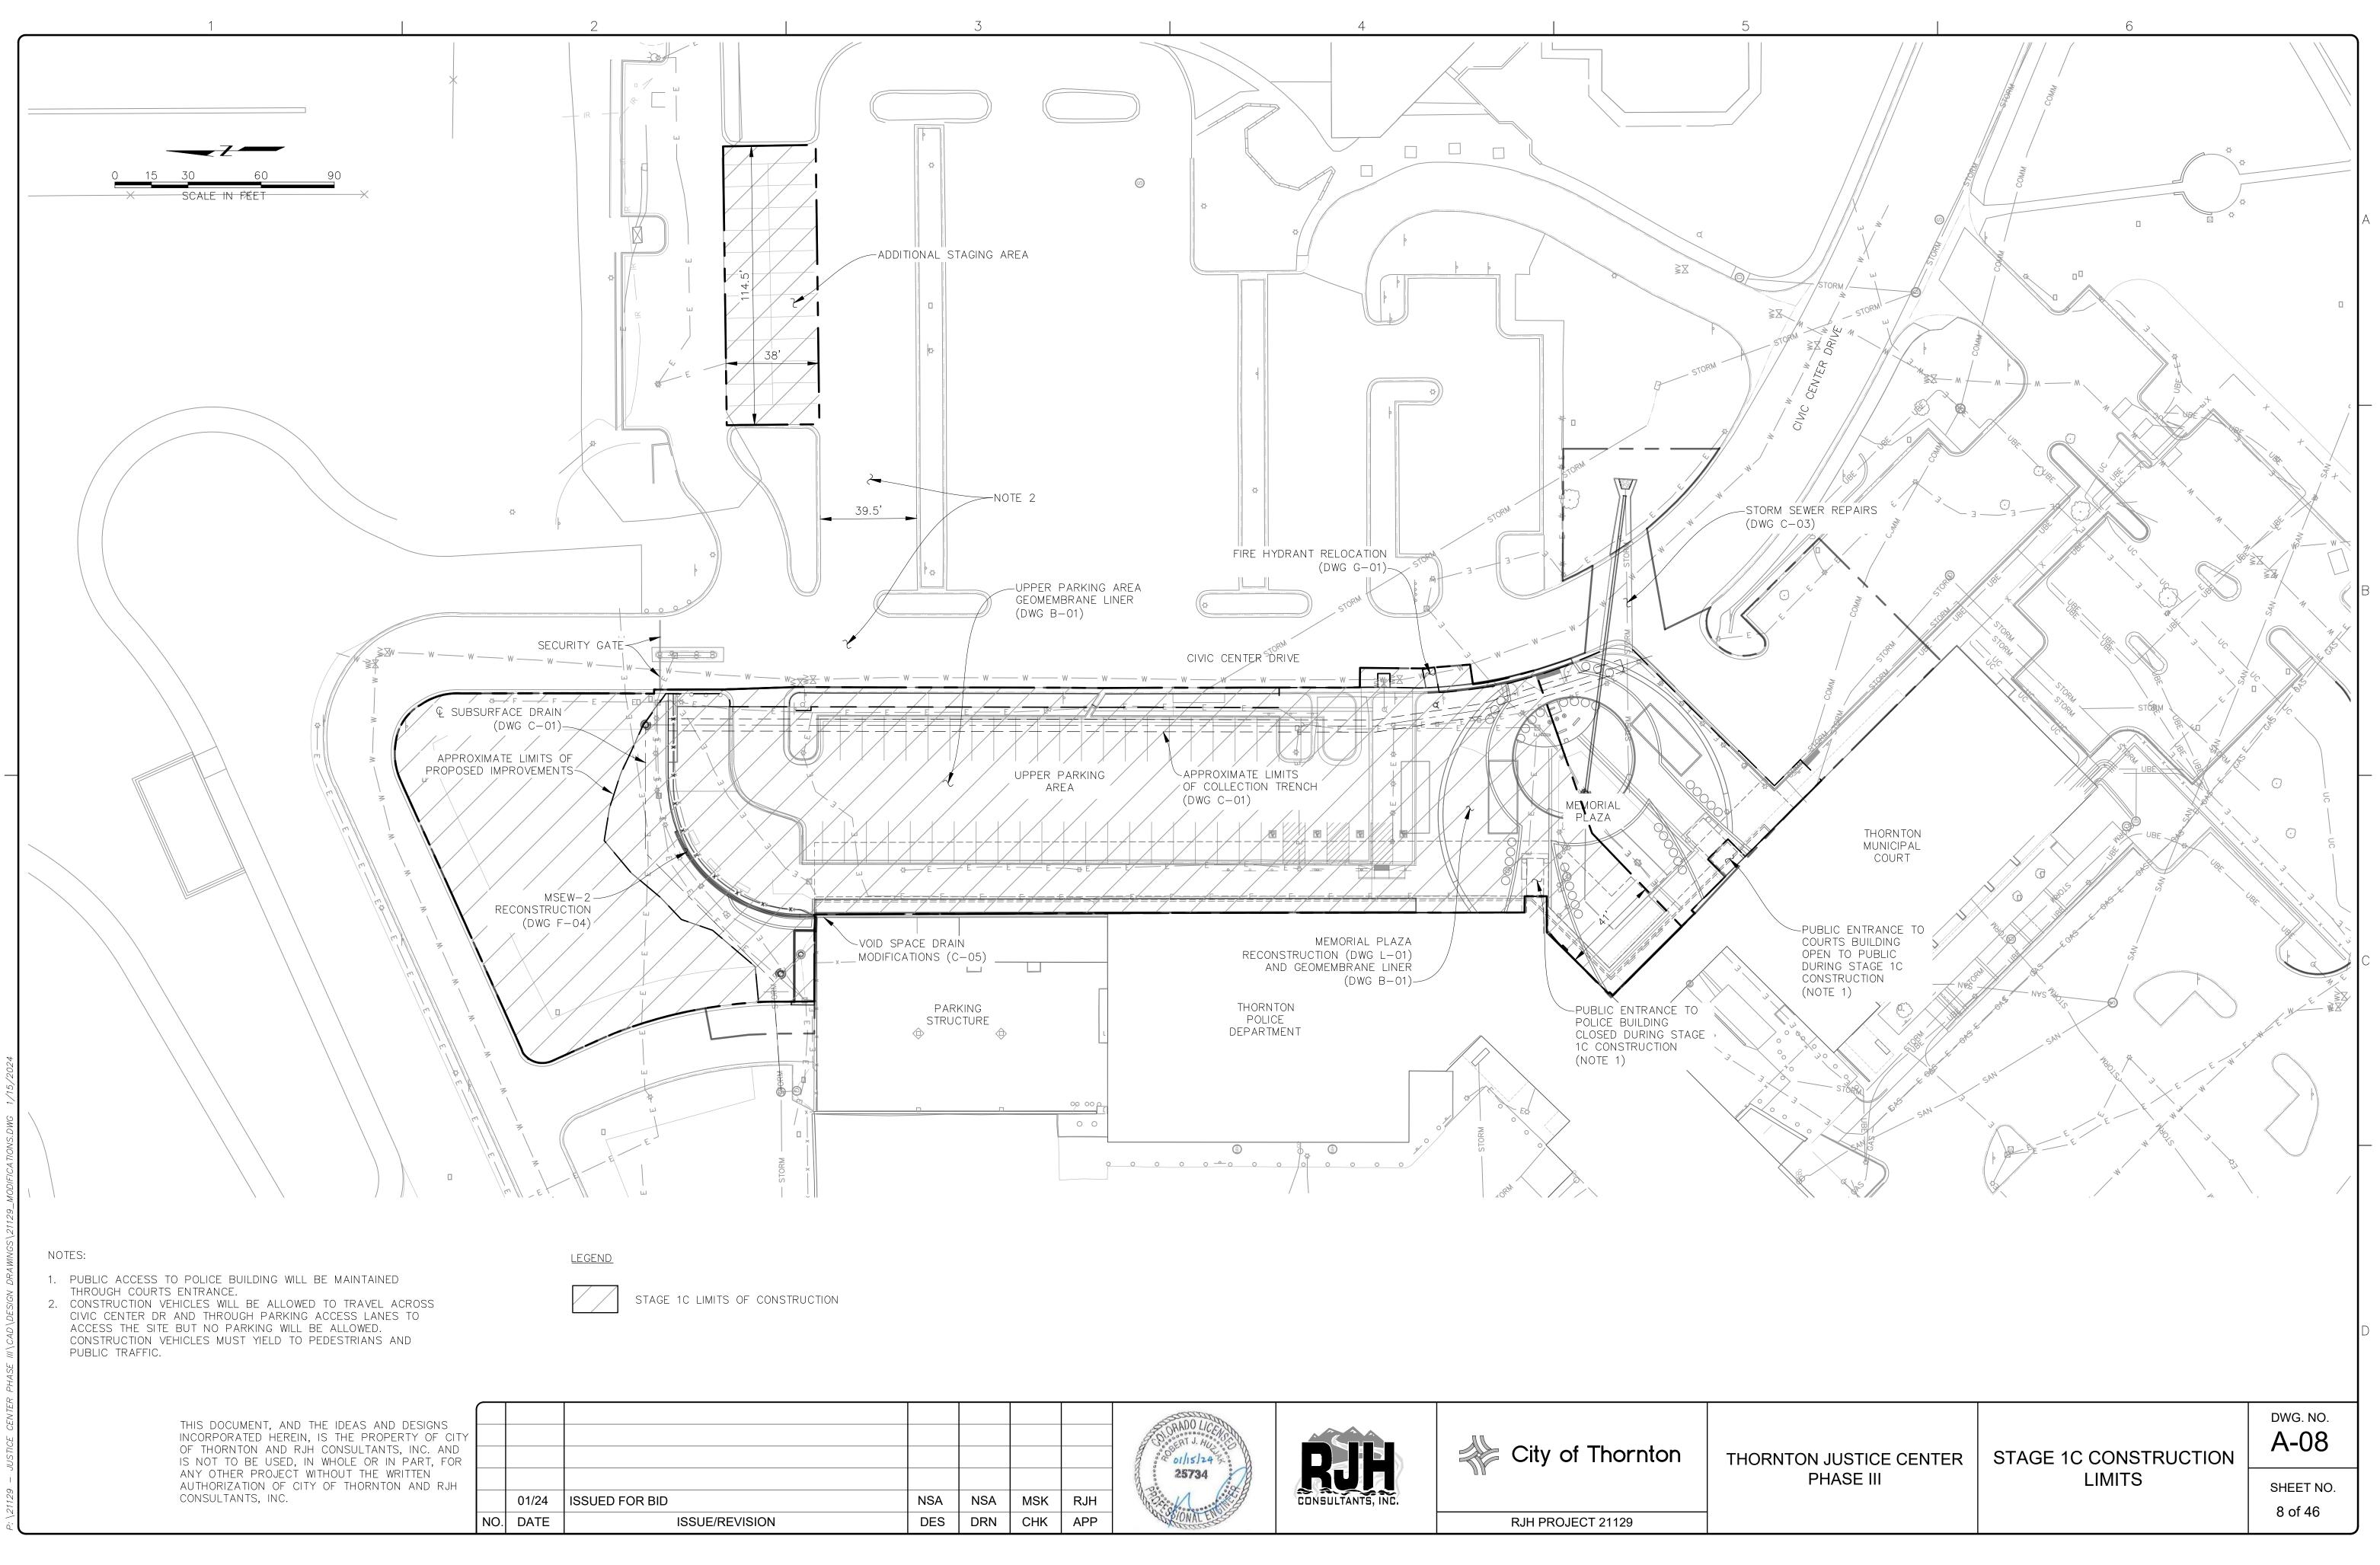

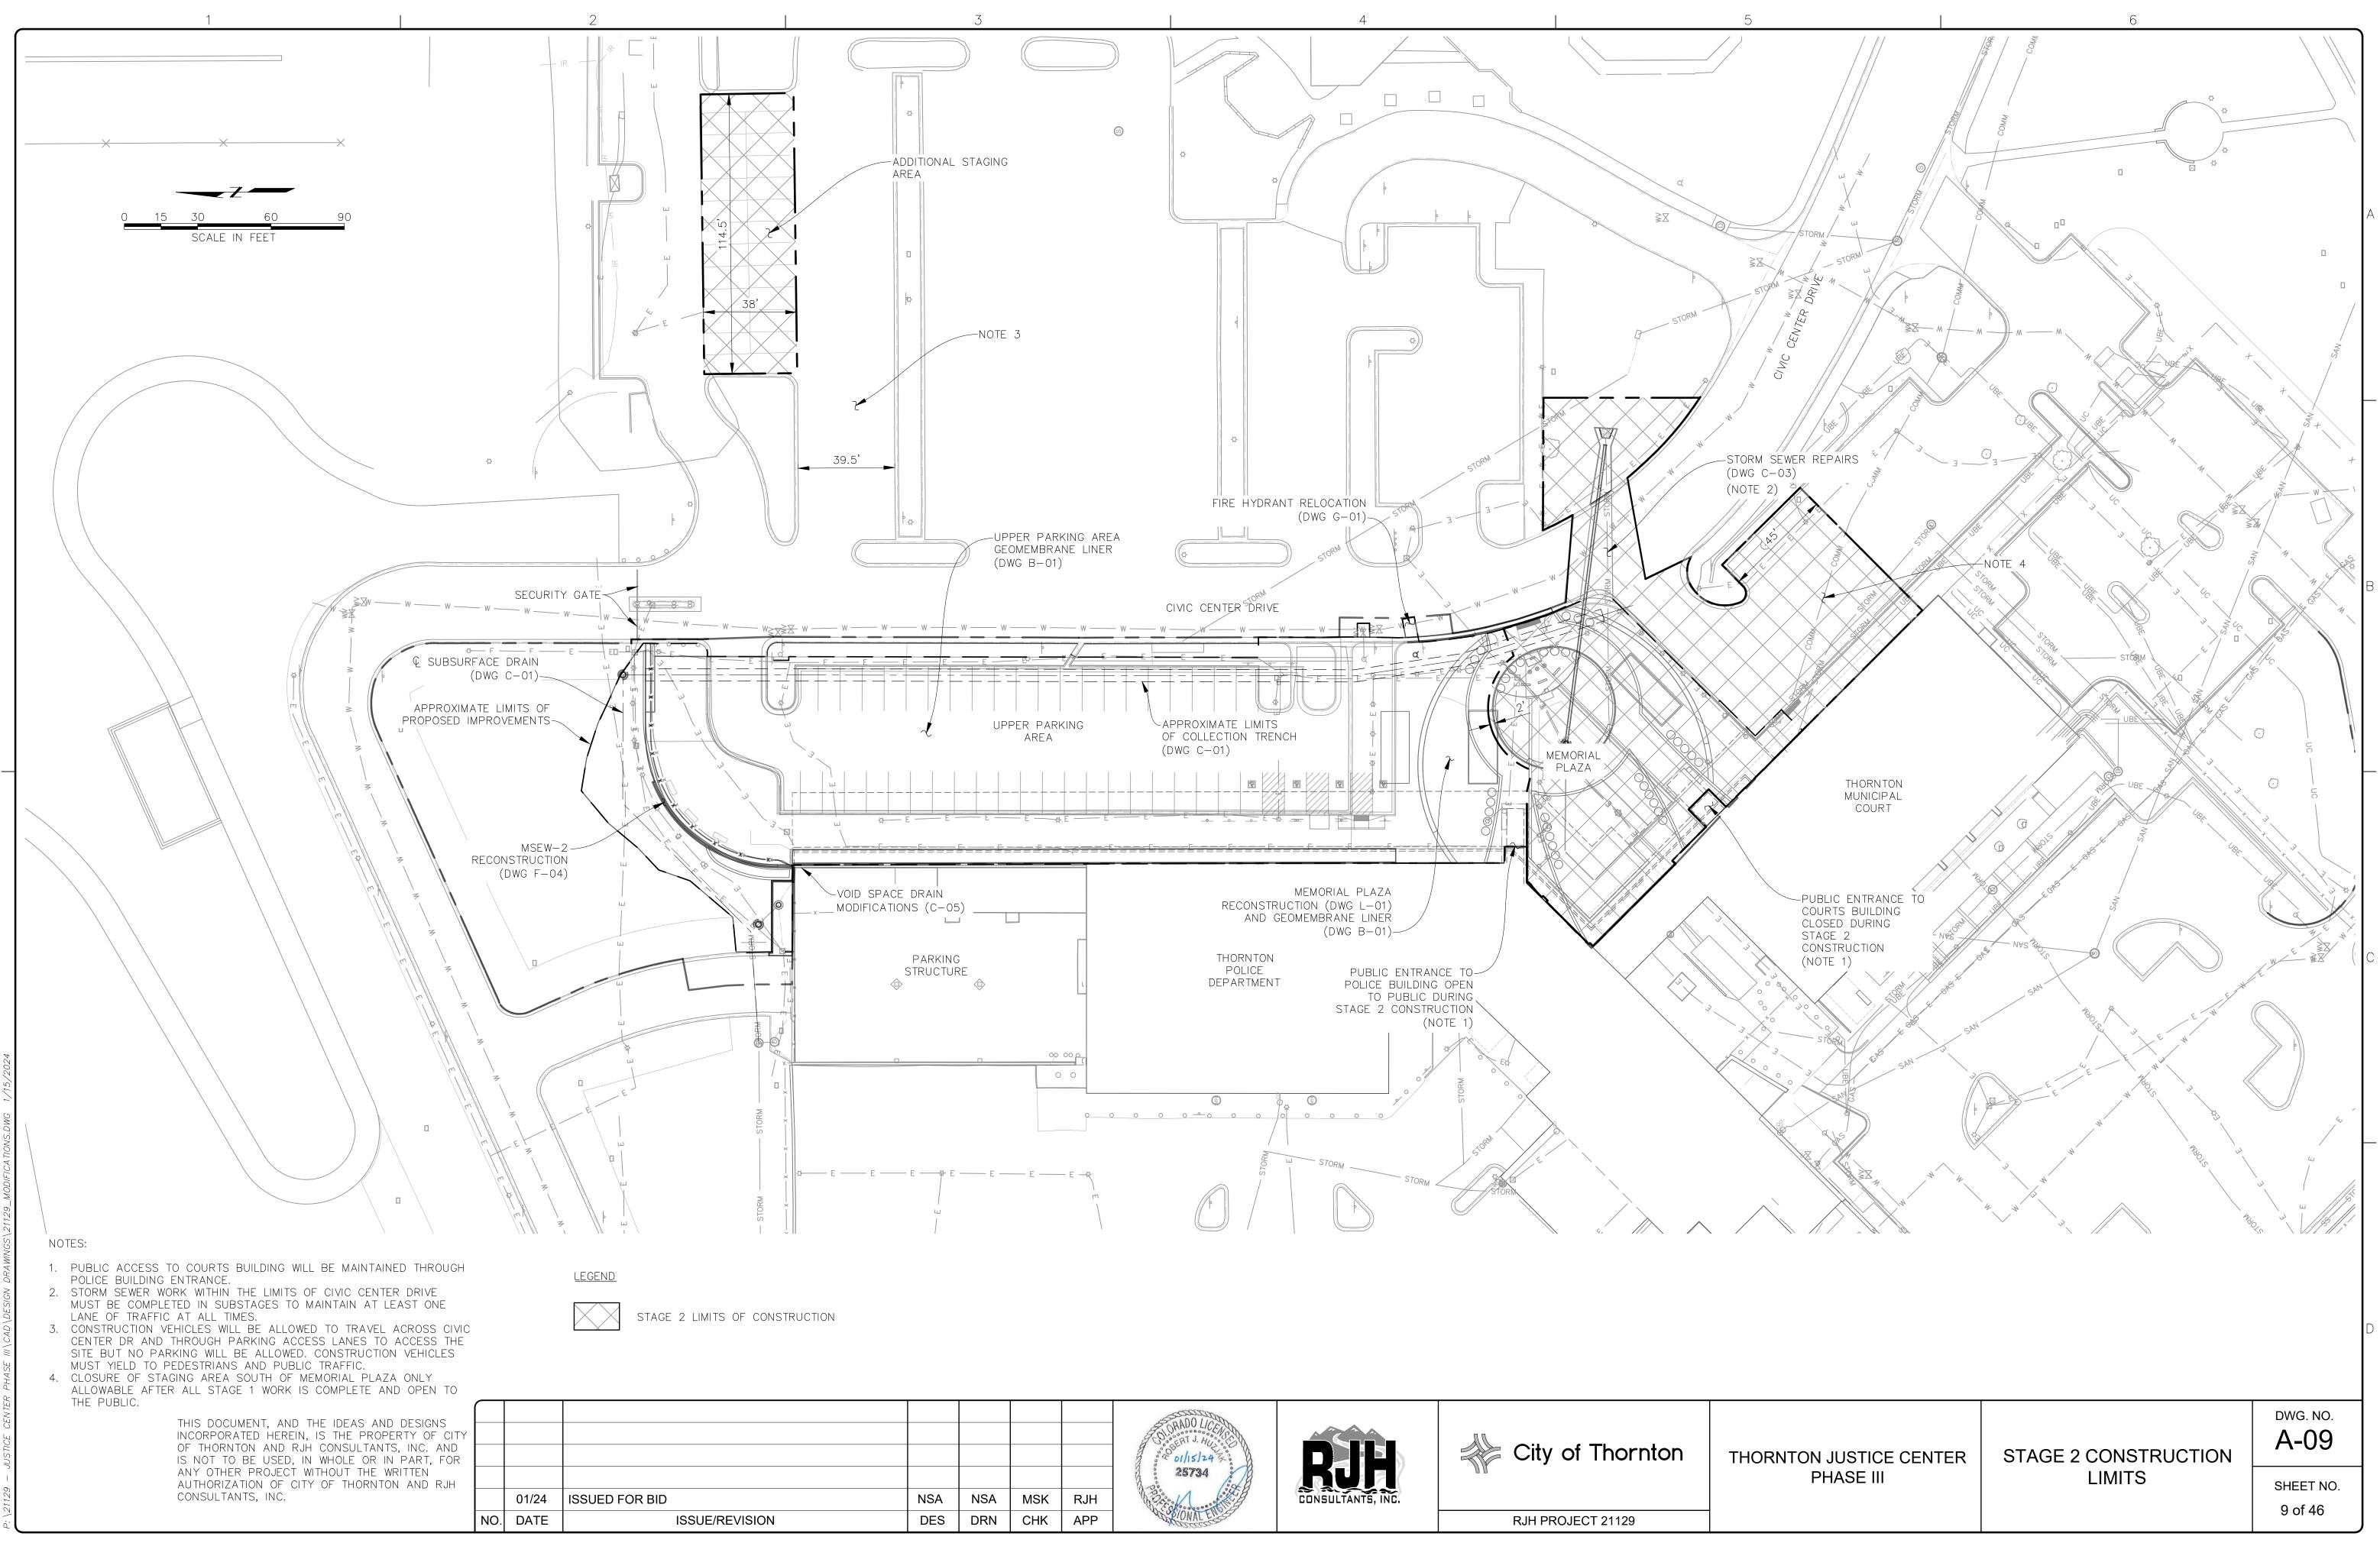


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ADDITIONAL STAGING				
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NOTE 3				
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			A TOWN	
	\$			
39.5'			STORM	STORM (DWG C (NOTE 2
	FIRE HYDRANT RE (D	ELOCATION WG G-01)	3-0	
UPPER PARKING AREA GEOMEMBRANE LINER		STORM		
(DWG B-01)			W	MH L
	CIVIC CENTER SDRIVE		W	
	W W			
UPPER PARKING	APPROXIMATE LIMITS		2	
\sim Area	OF COLLECTION TRENCH (DWG C-01)		MEMORIA	
	9			
	L			
		MORIAL PLAZA		
-VOID SPACE DRAIN MODIFICATIONS (C-05)	RECONSTRUCTIO AND GEOME	N (DWG L-01) MBRANE LINER		
PARKING	THORNTON	(DWG B-01)		
	POLICE DEPARTMENT	PUBLIC ENTRANCE TO POLICE BUILDING OPEN	Ν	
		TO PUBLIC DURINO STAGE 2 CONSTRUCTIOI (NOTE 1	N	
		STORM STORM		
0 0 0		- ·/	°× ×	
			STORM	
E E E E E	STOR	- STORM STORM	STORM.	
1			//	

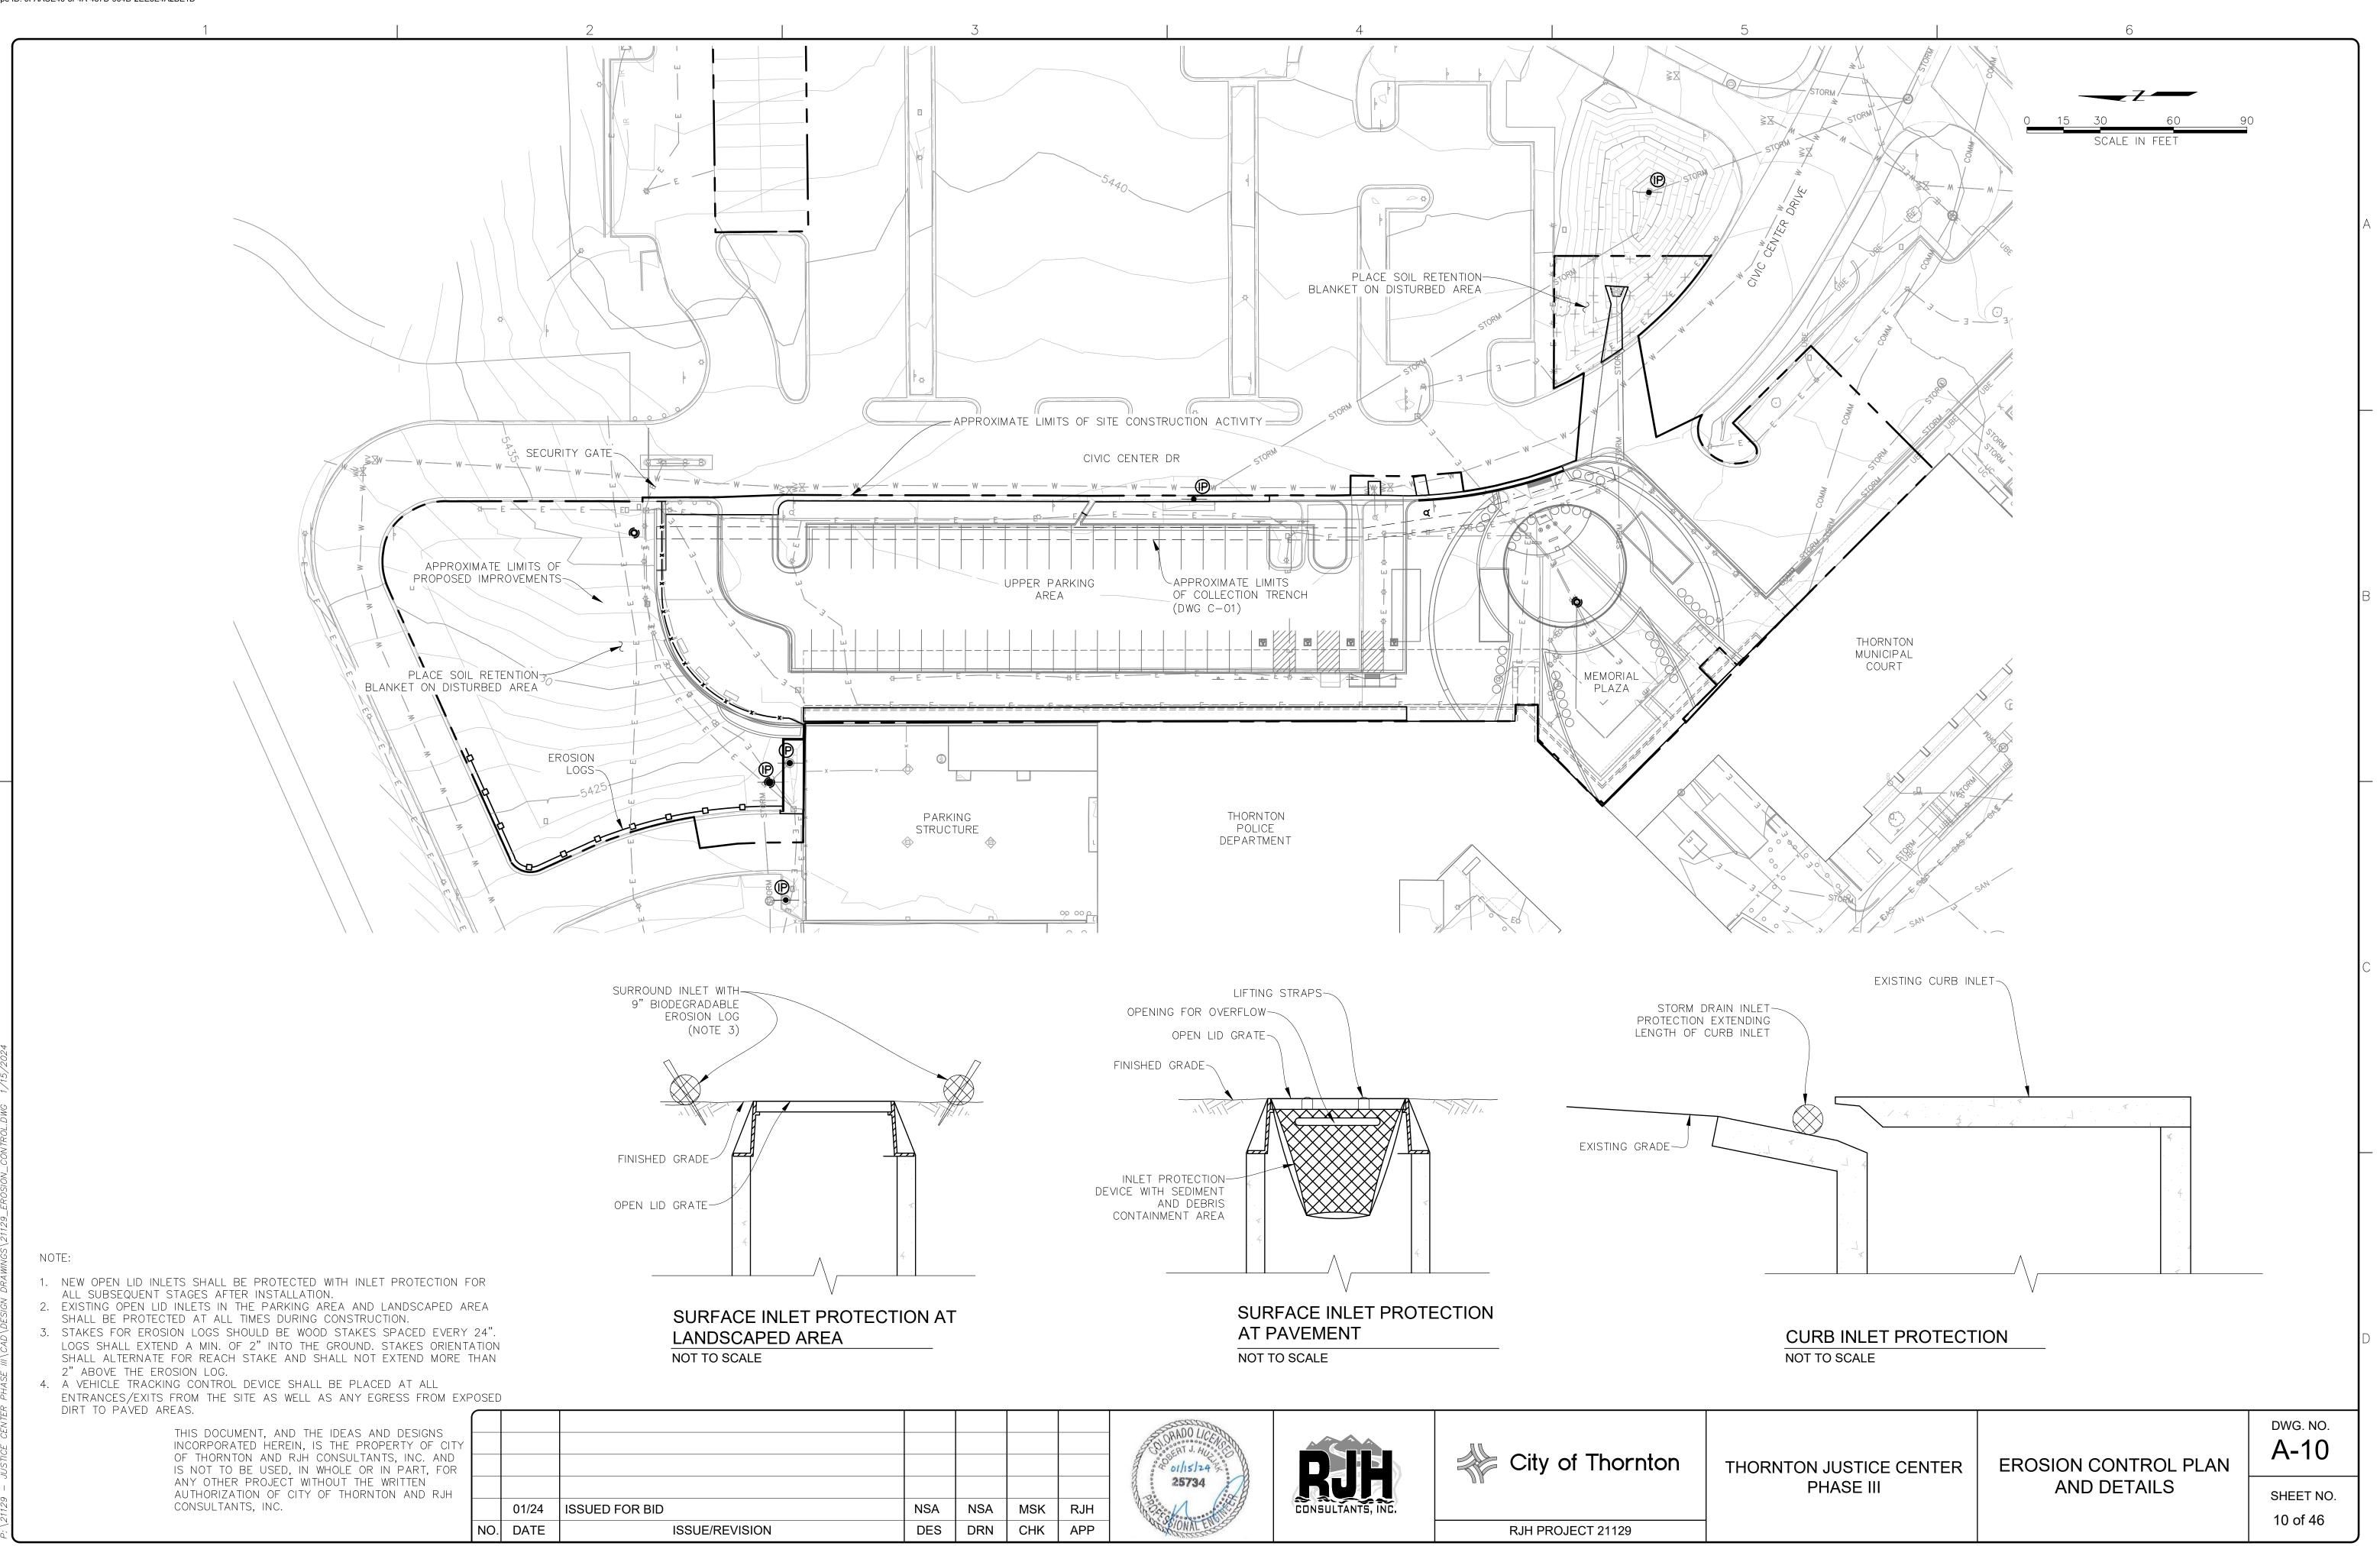


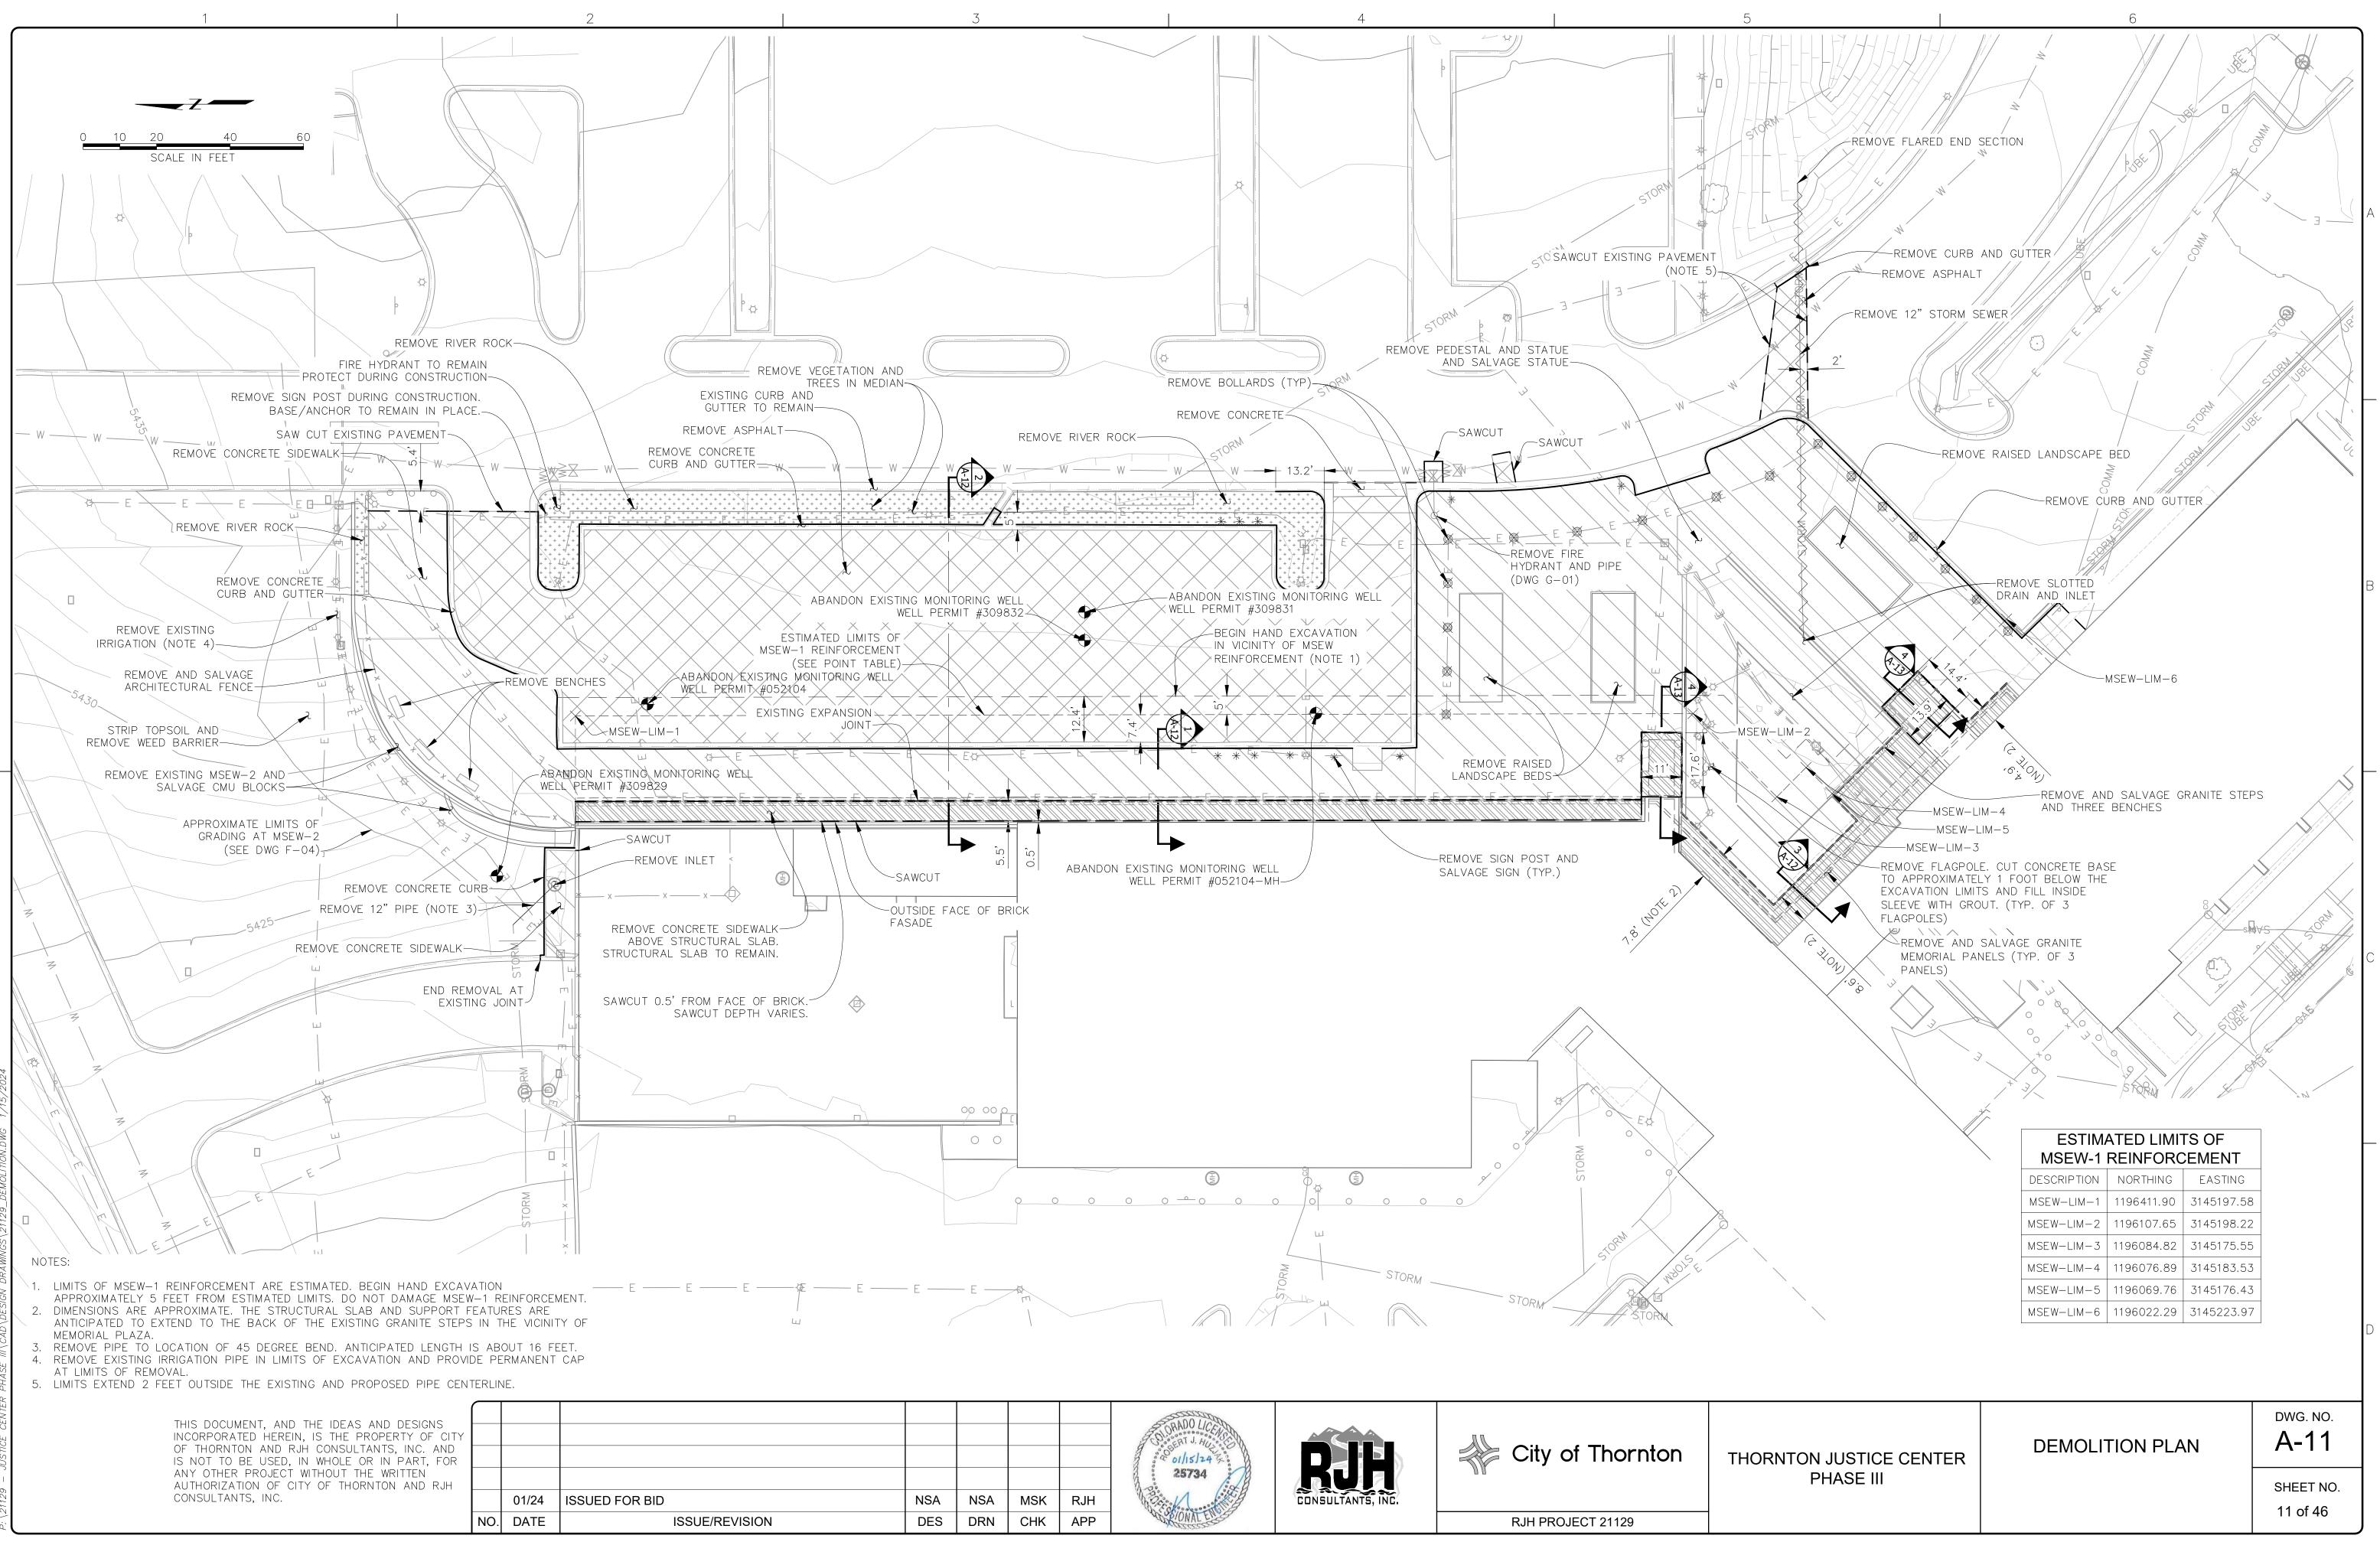

RJH		CONSULTANTS, INC.	
APP	VID SIONAL EN		B.IH PROJECT 21129

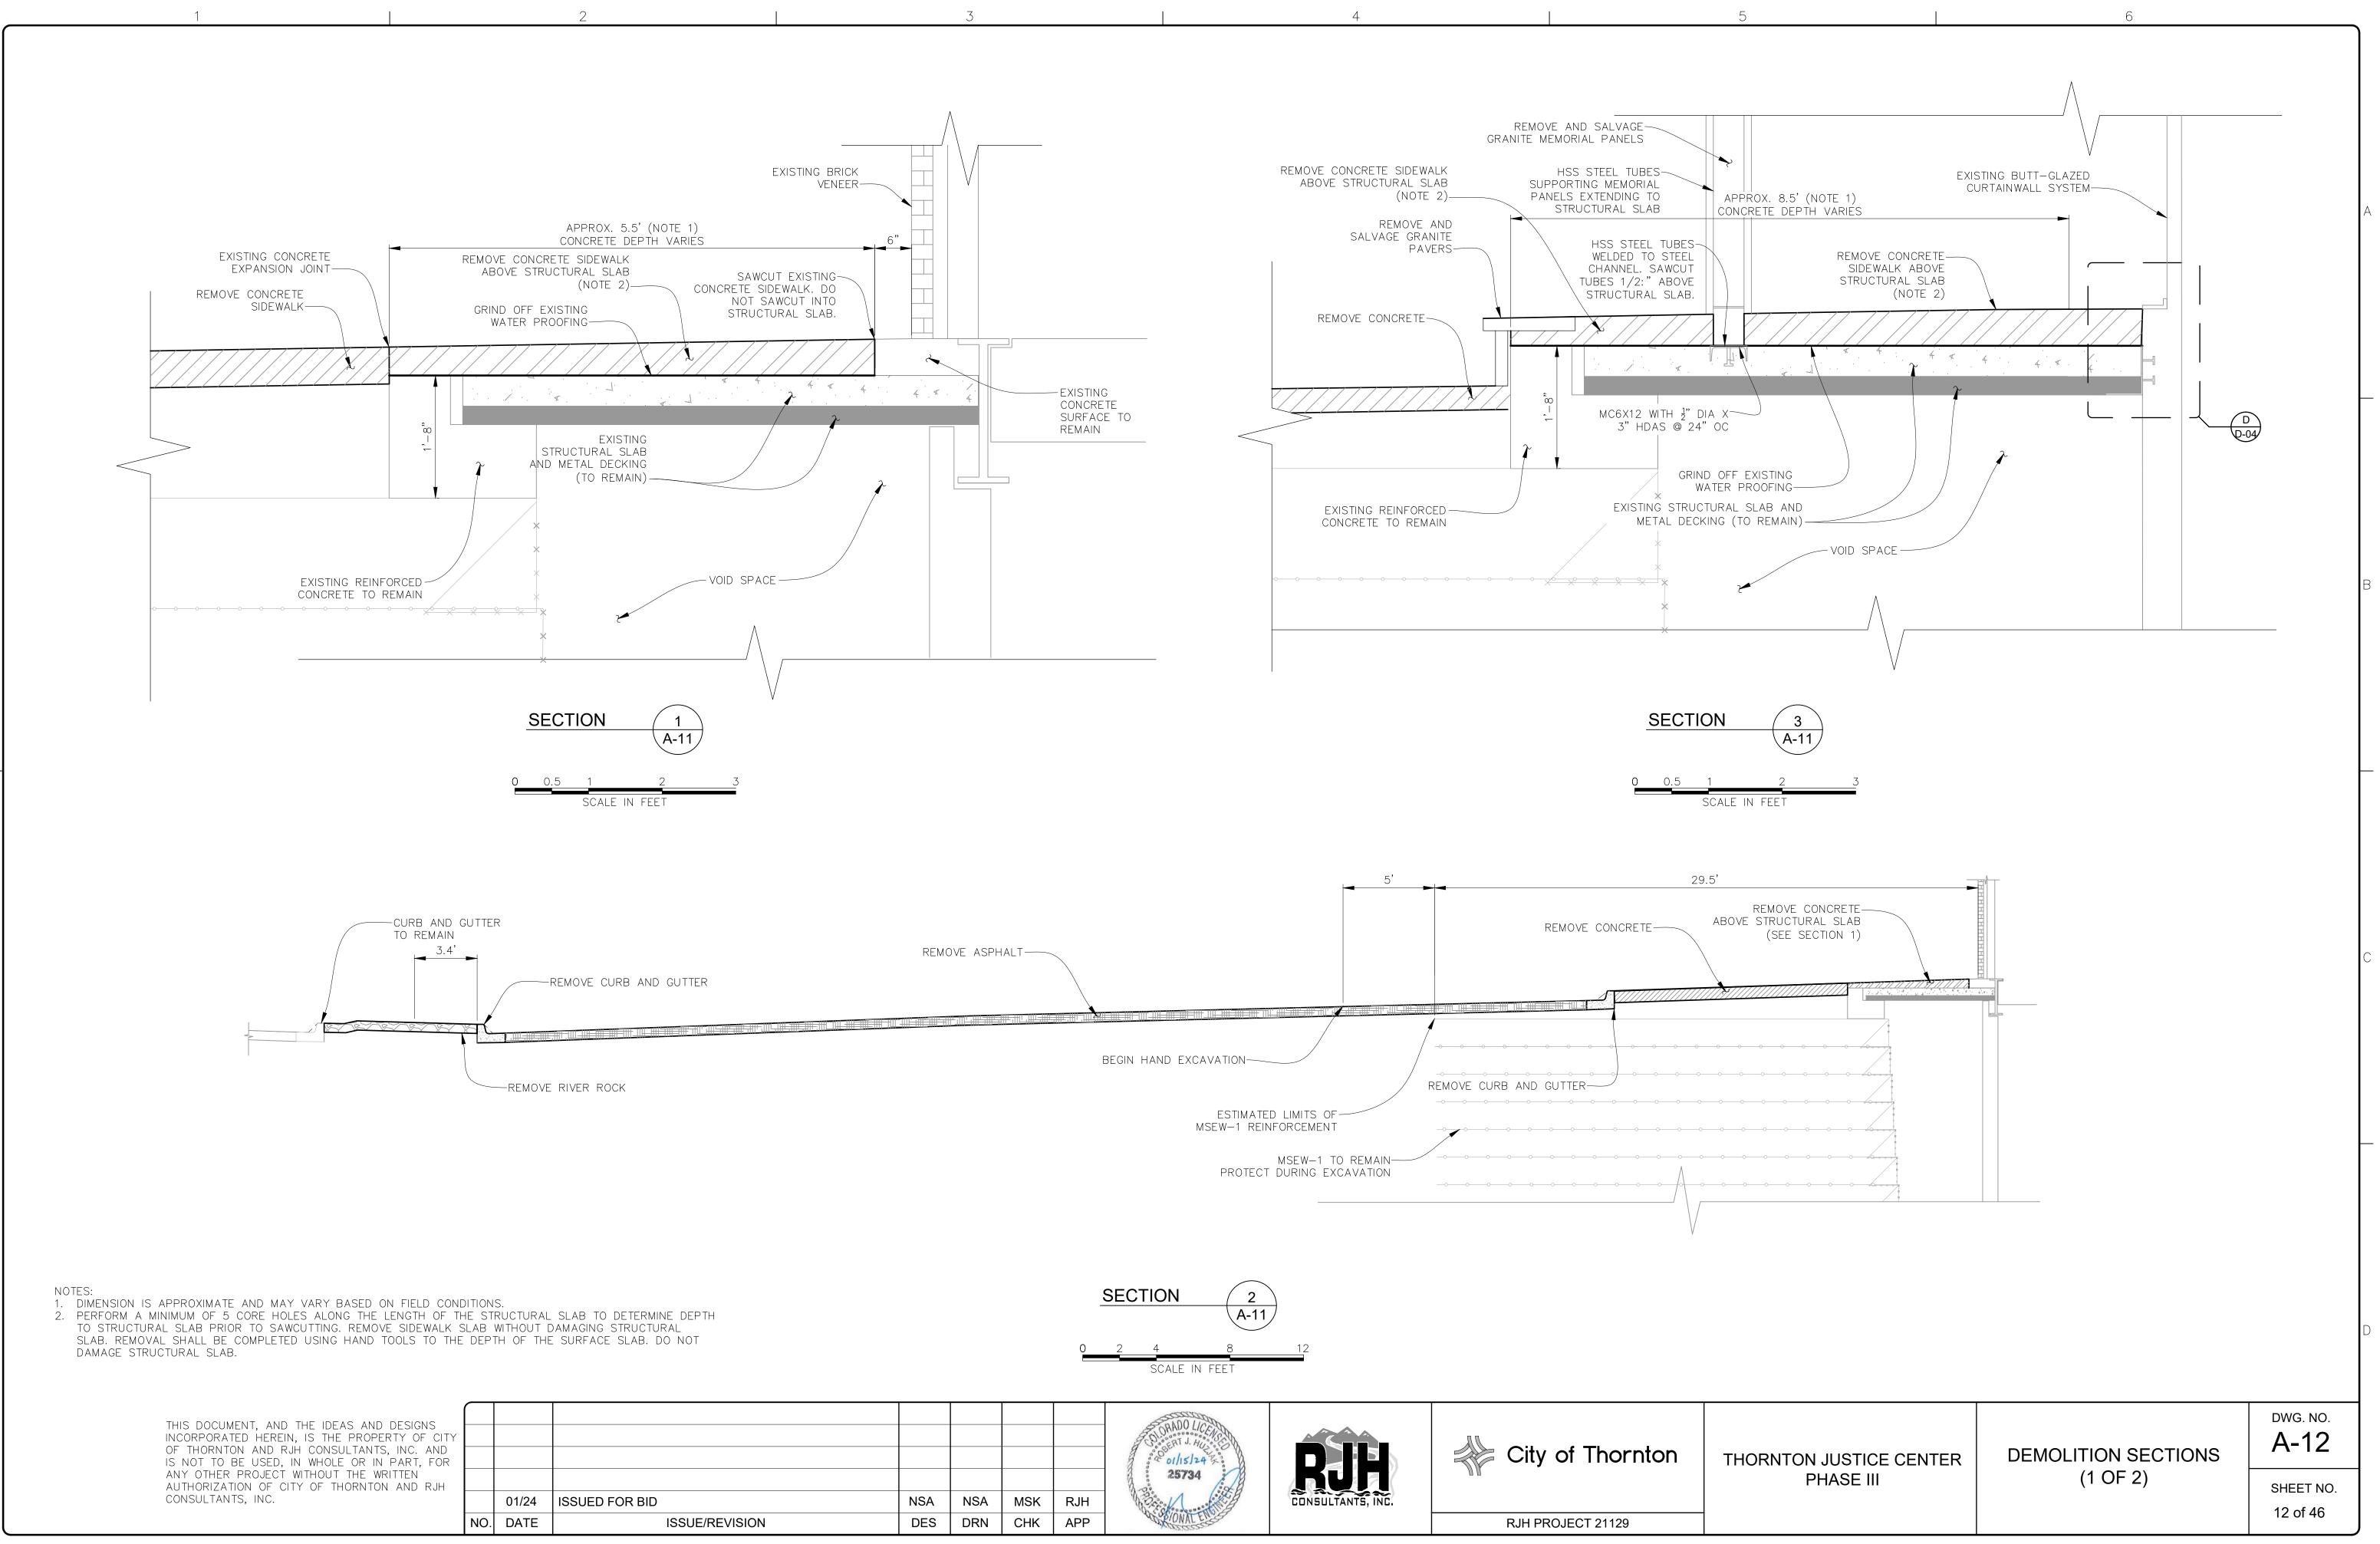



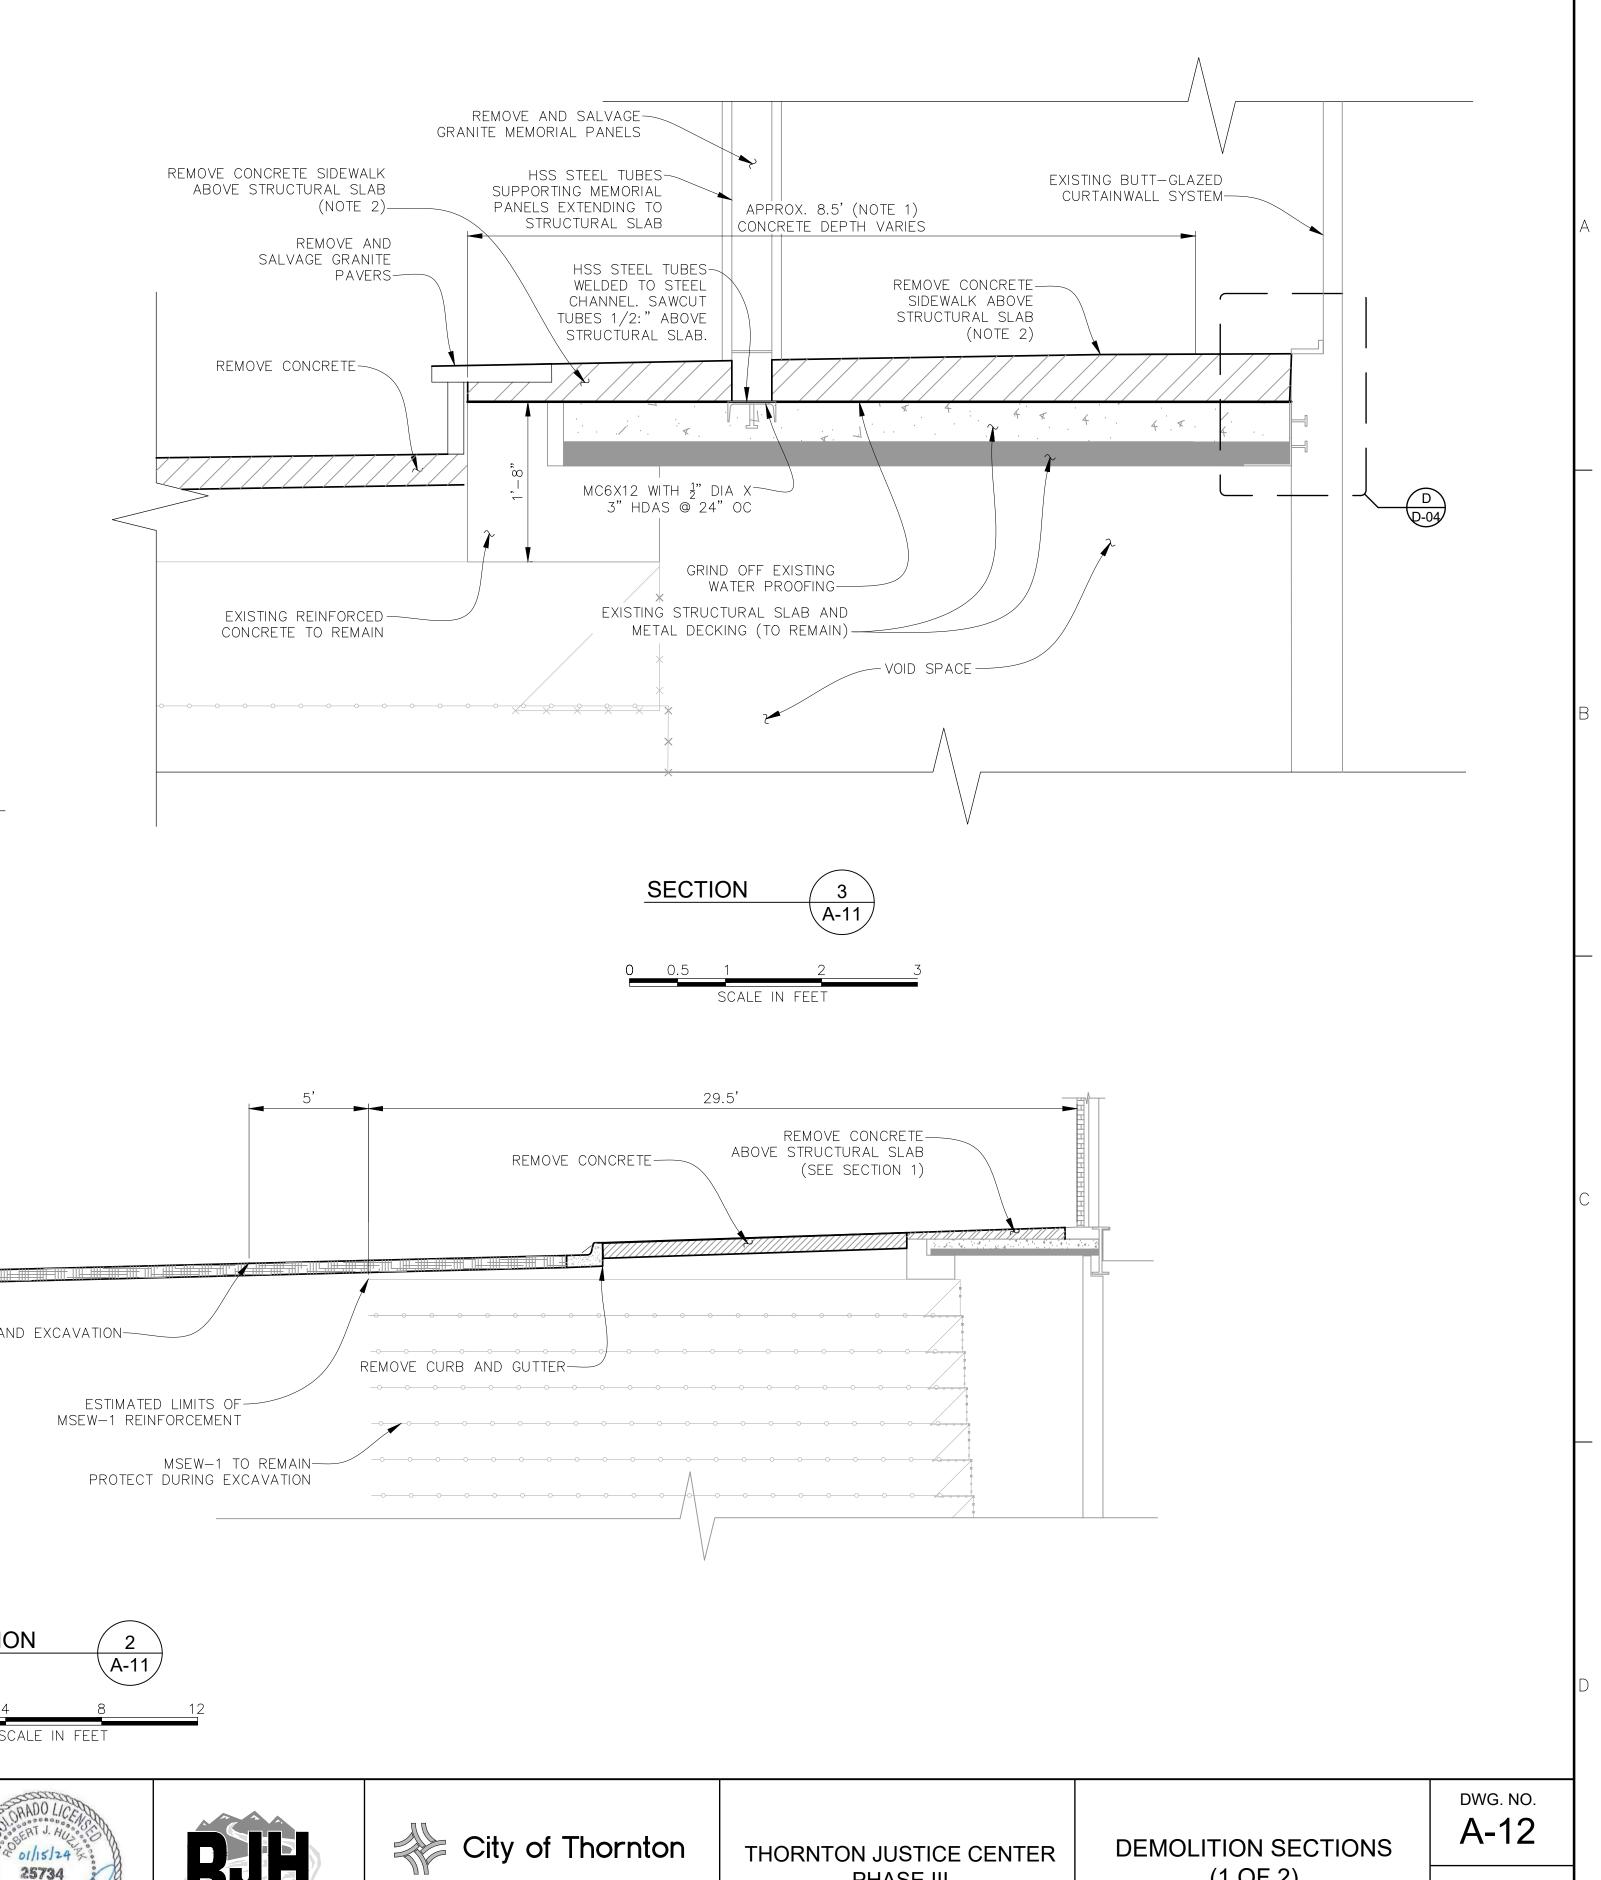




					RE	emove con Sie
						EXIST A CONC
EMOLITON.DWO 1/10/2027						
- JUDITLE LEIVIER FRADE III LAR VEDIGN PRAMINGS (ZIIZA_DEMOLITUN.DWG I/IJ/ZUZ4 2.1. Z	PERFORM A MINIMUM OF 2 CORE HOLES ALONG THE LENGTH OF THE STRU DETERMINE DEPTH TO STRUCTURAL SLAB PRIOR TO SAWCUTTING. REMOVE WITHOUT DAMAGING STRUCTURAL SLAB. REMOVAL SHALL BE COMPLETED U TO THE DEPTH OF THE SURFACE SLAB. DO NOT DAMAGE STRUCTURAL SLA	ICTUF SIDEV SING	RAL SLAB Walk Sla	В		
r. Vziiza - Judiice Ce	THIS DOCUMENT, AND THE IDEAS AND DESIGNS INCORPORATED HEREIN, IS THE PROPERTY OF CITY OF THORNTON AND RJH CONSULTANTS, INC. AND IS NOT TO BE USED, IN WHOLE OR IN PART, FOR ANY OTHER PROJECT WITHOUT THE WRITTEN AUTHORIZATION OF CITY OF THORNTON AND RJH CONSULTANTS, INC.	NO.	01/24 DATE	ISSUED FOR BID ISS	UE/REVISION	



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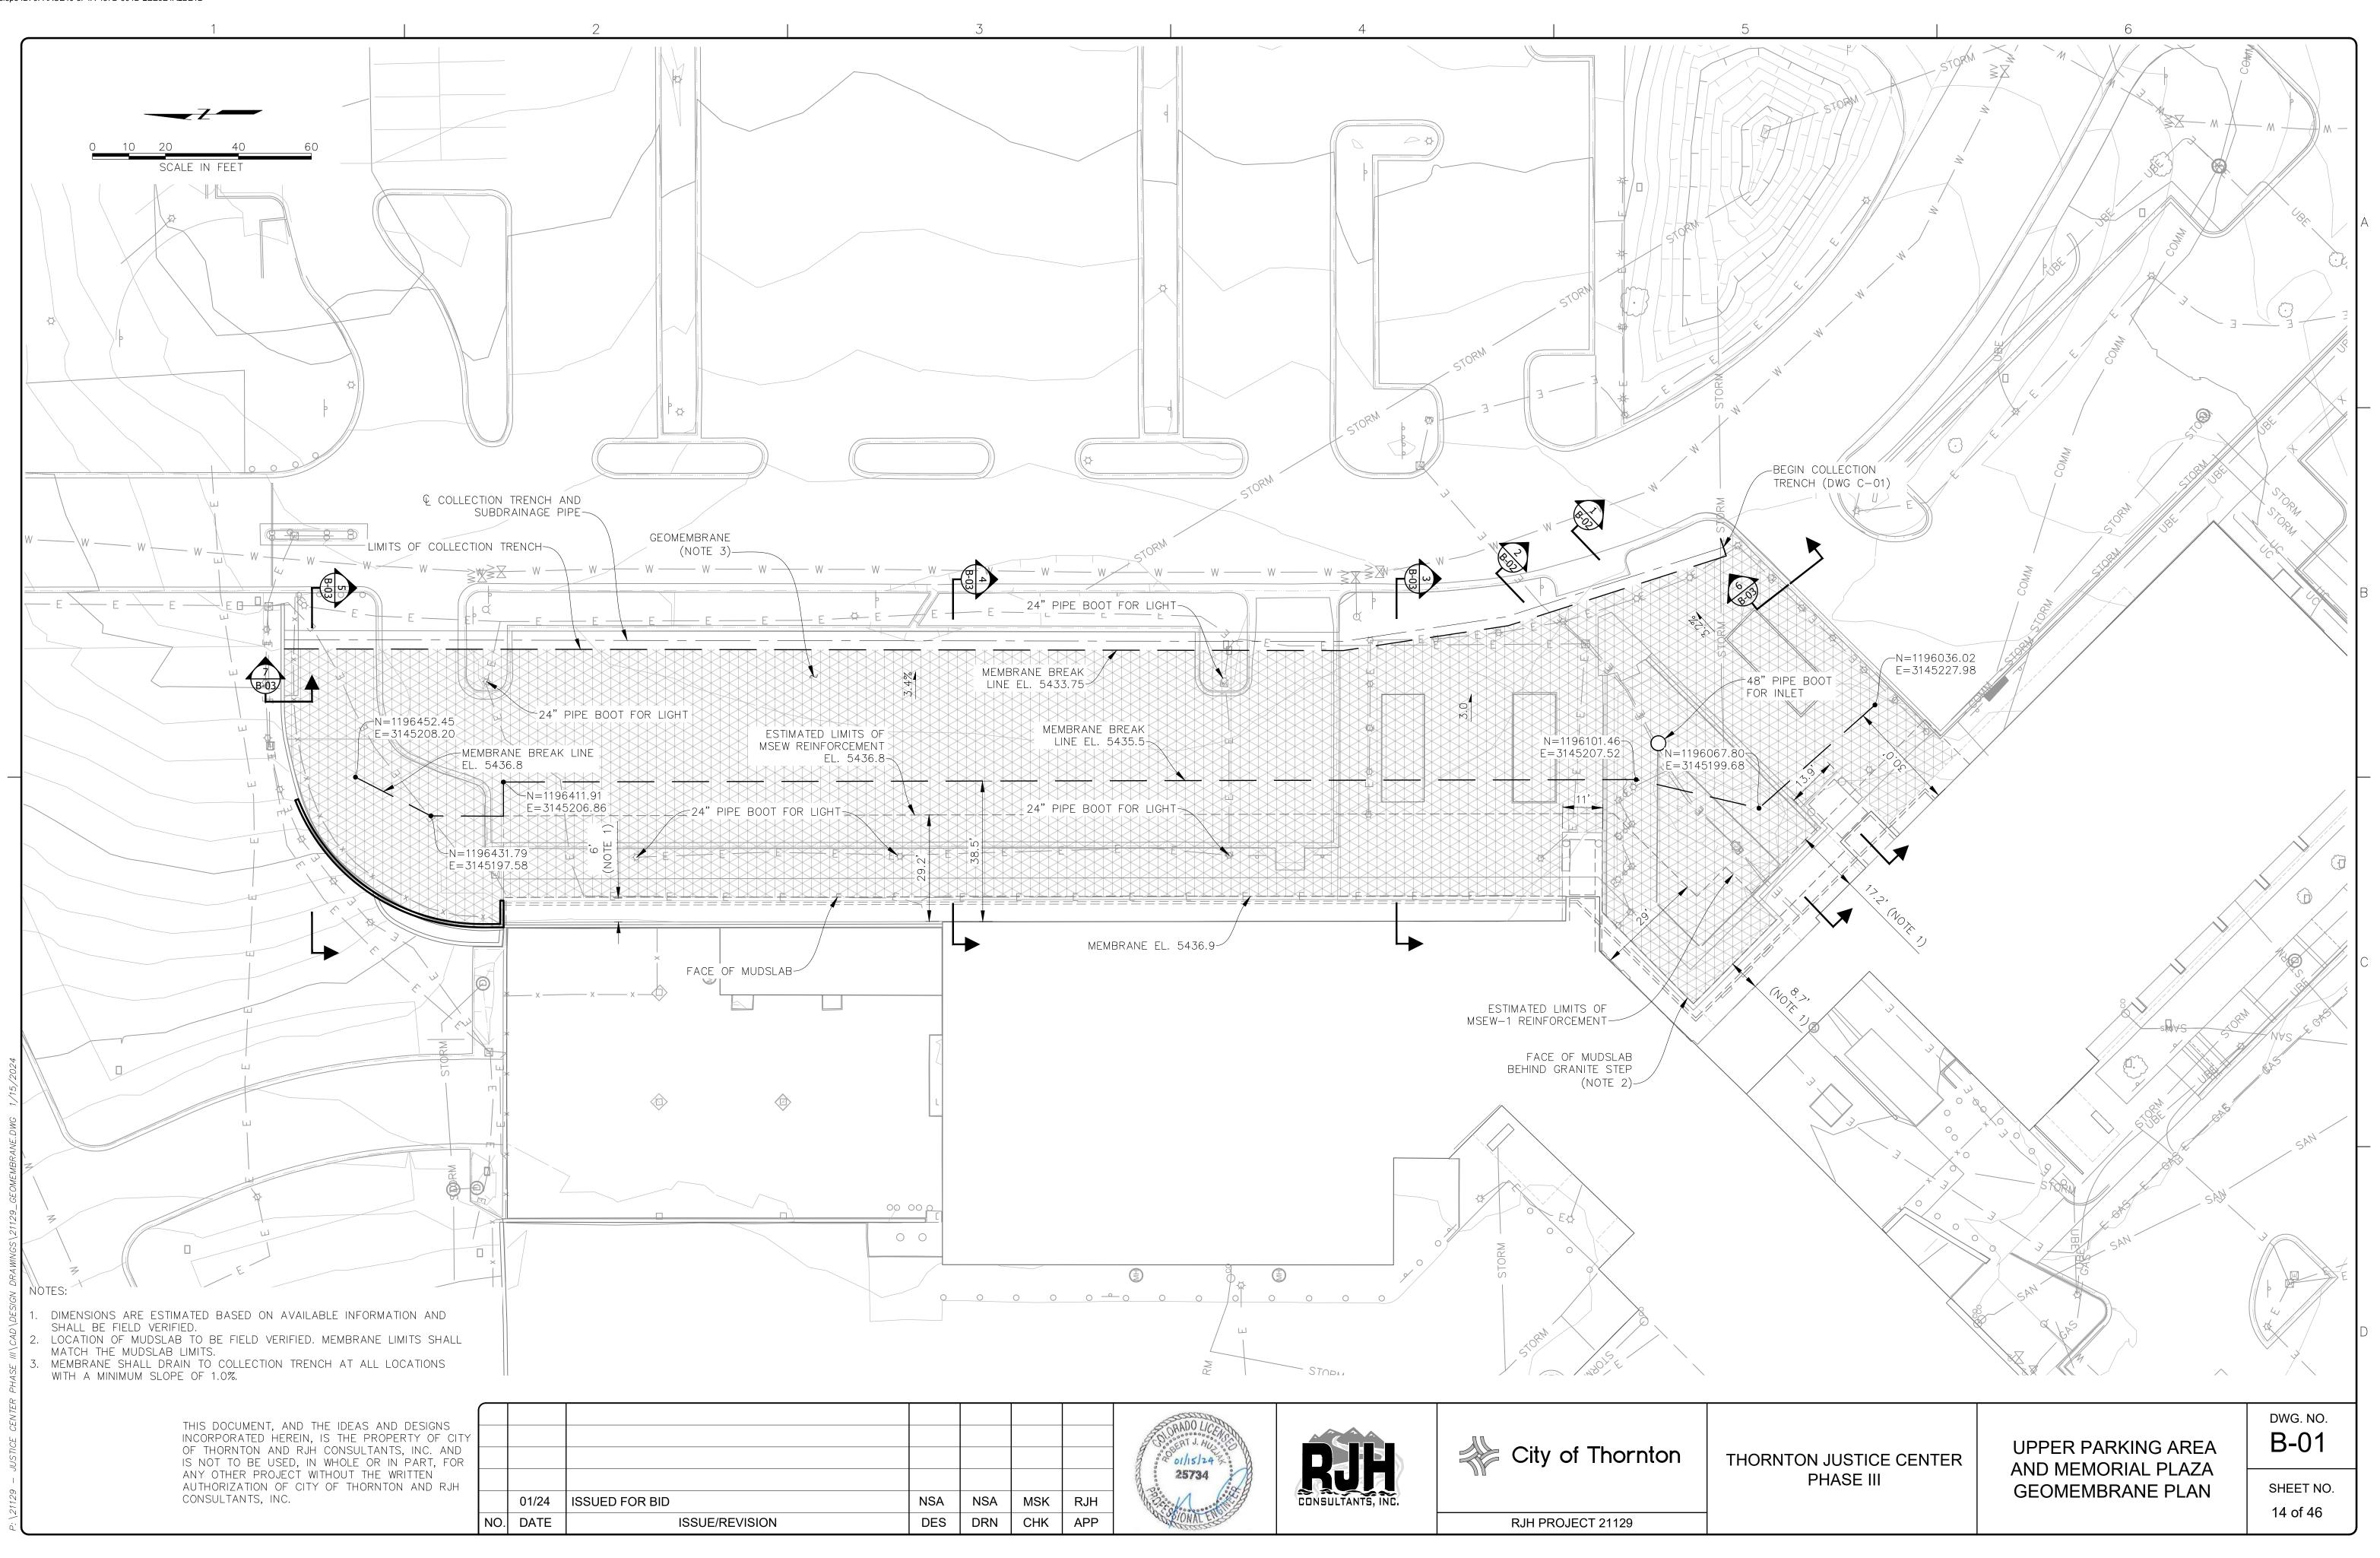


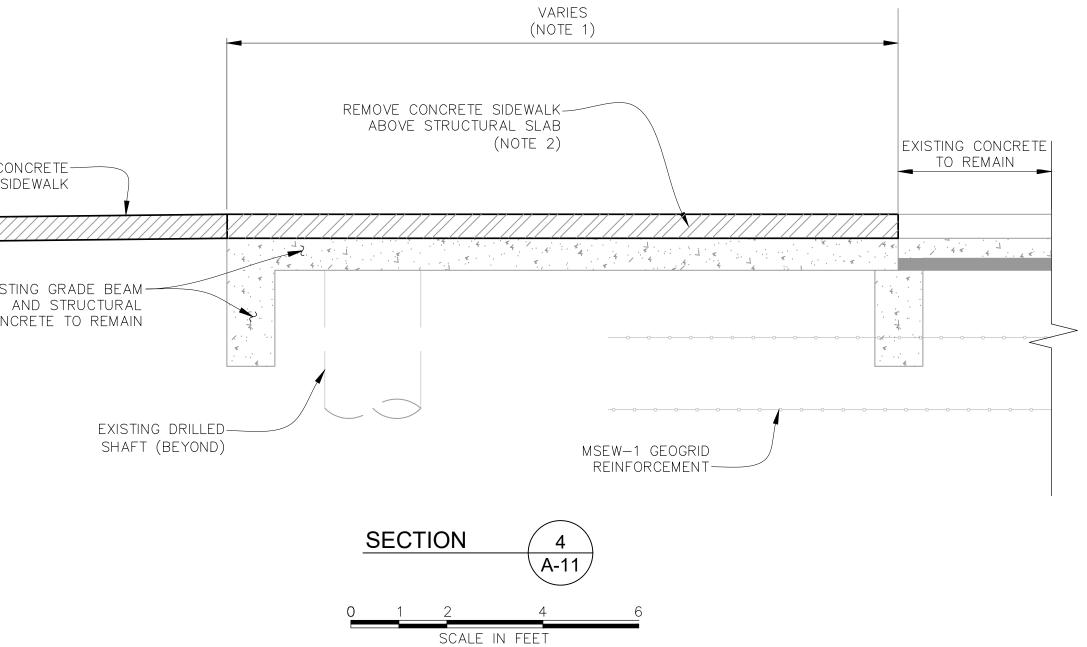


ORNTON JUSTICE CENTER	DEMOLITION SECTIONS (2	dwg. no. A-13
PHASE III	OF 2)	SHEET NO. 13 of 46


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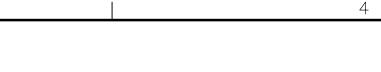


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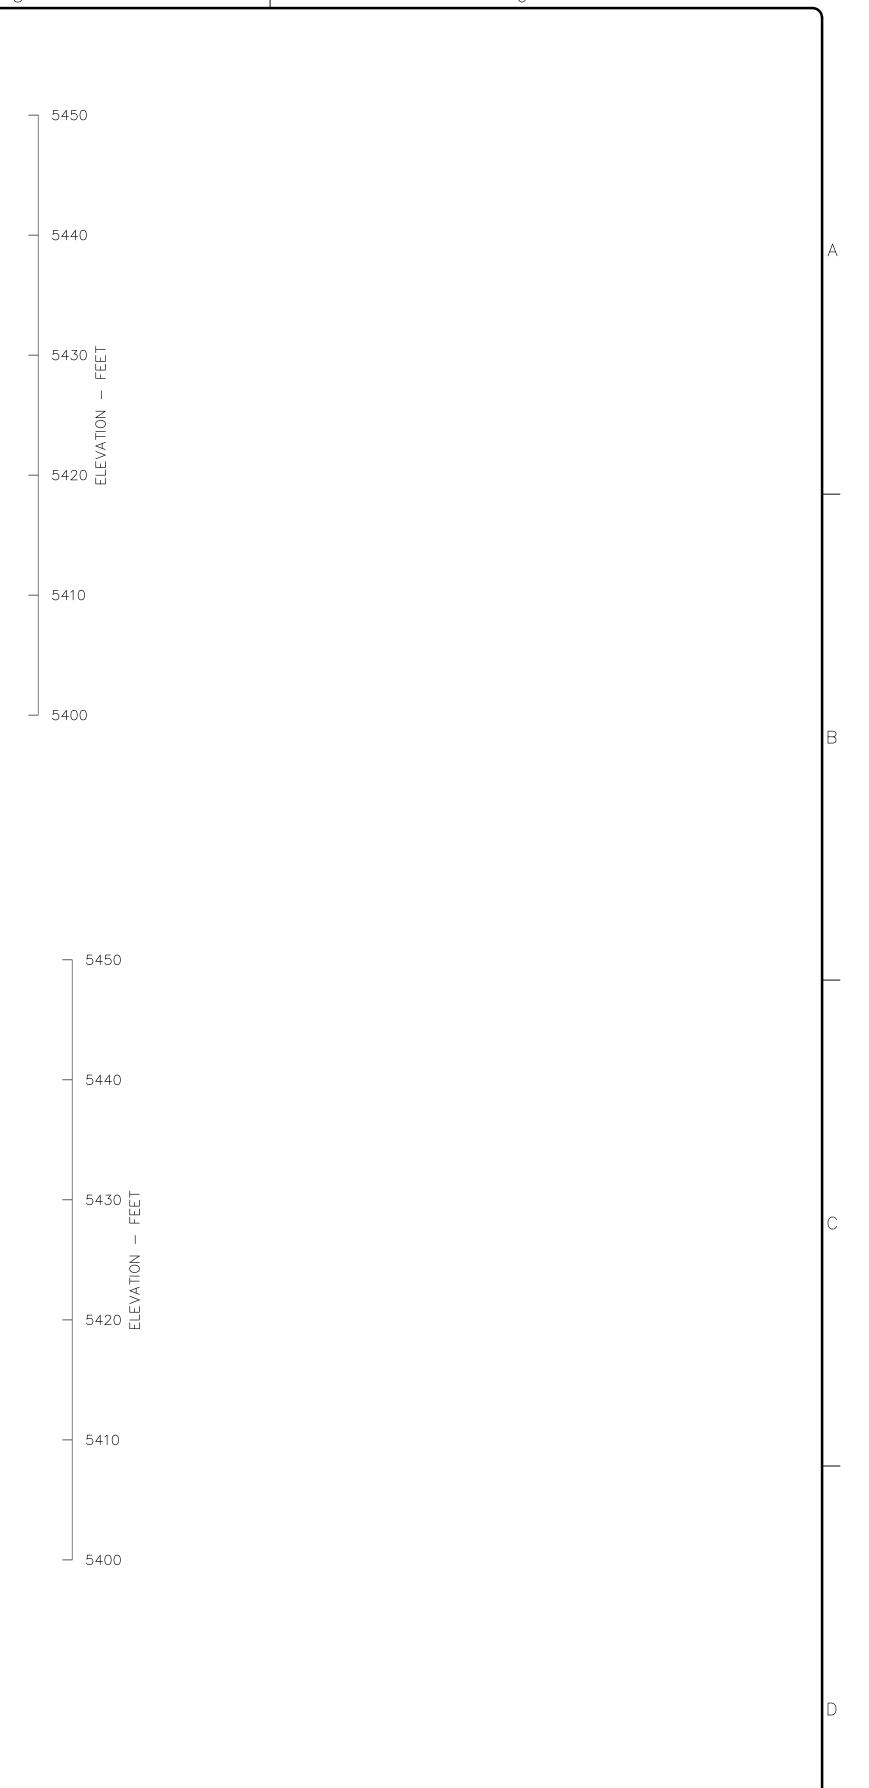




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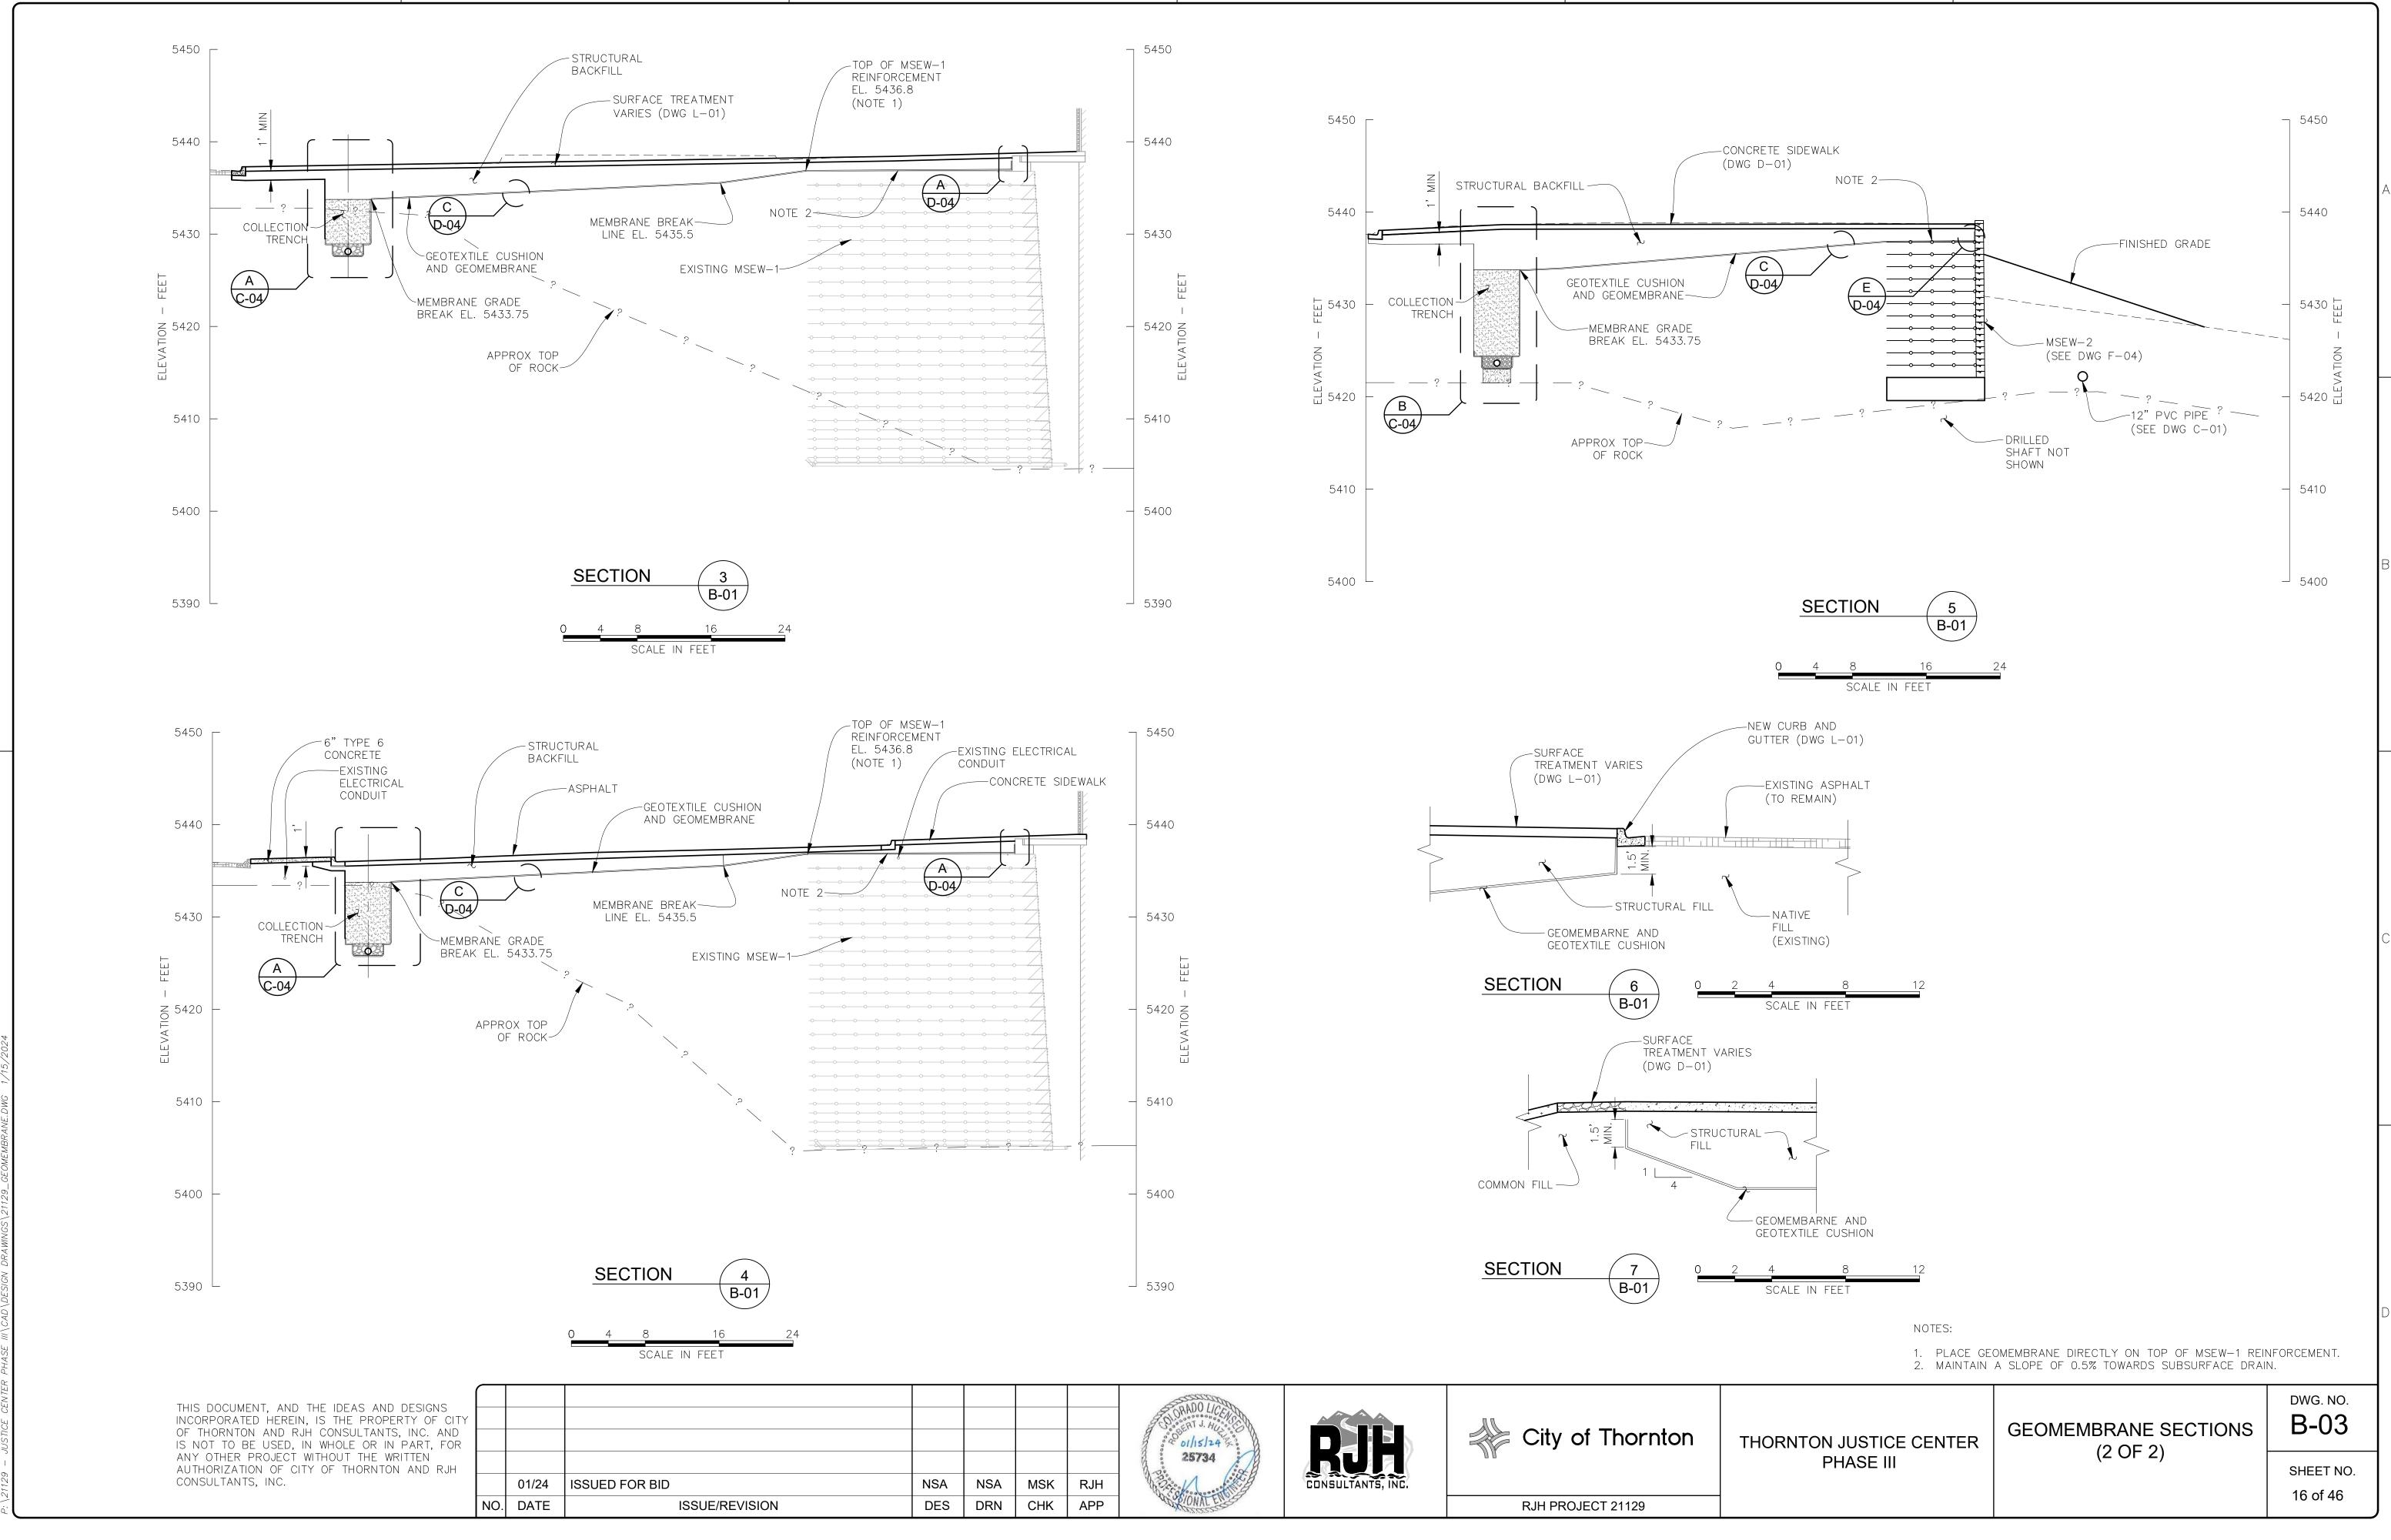


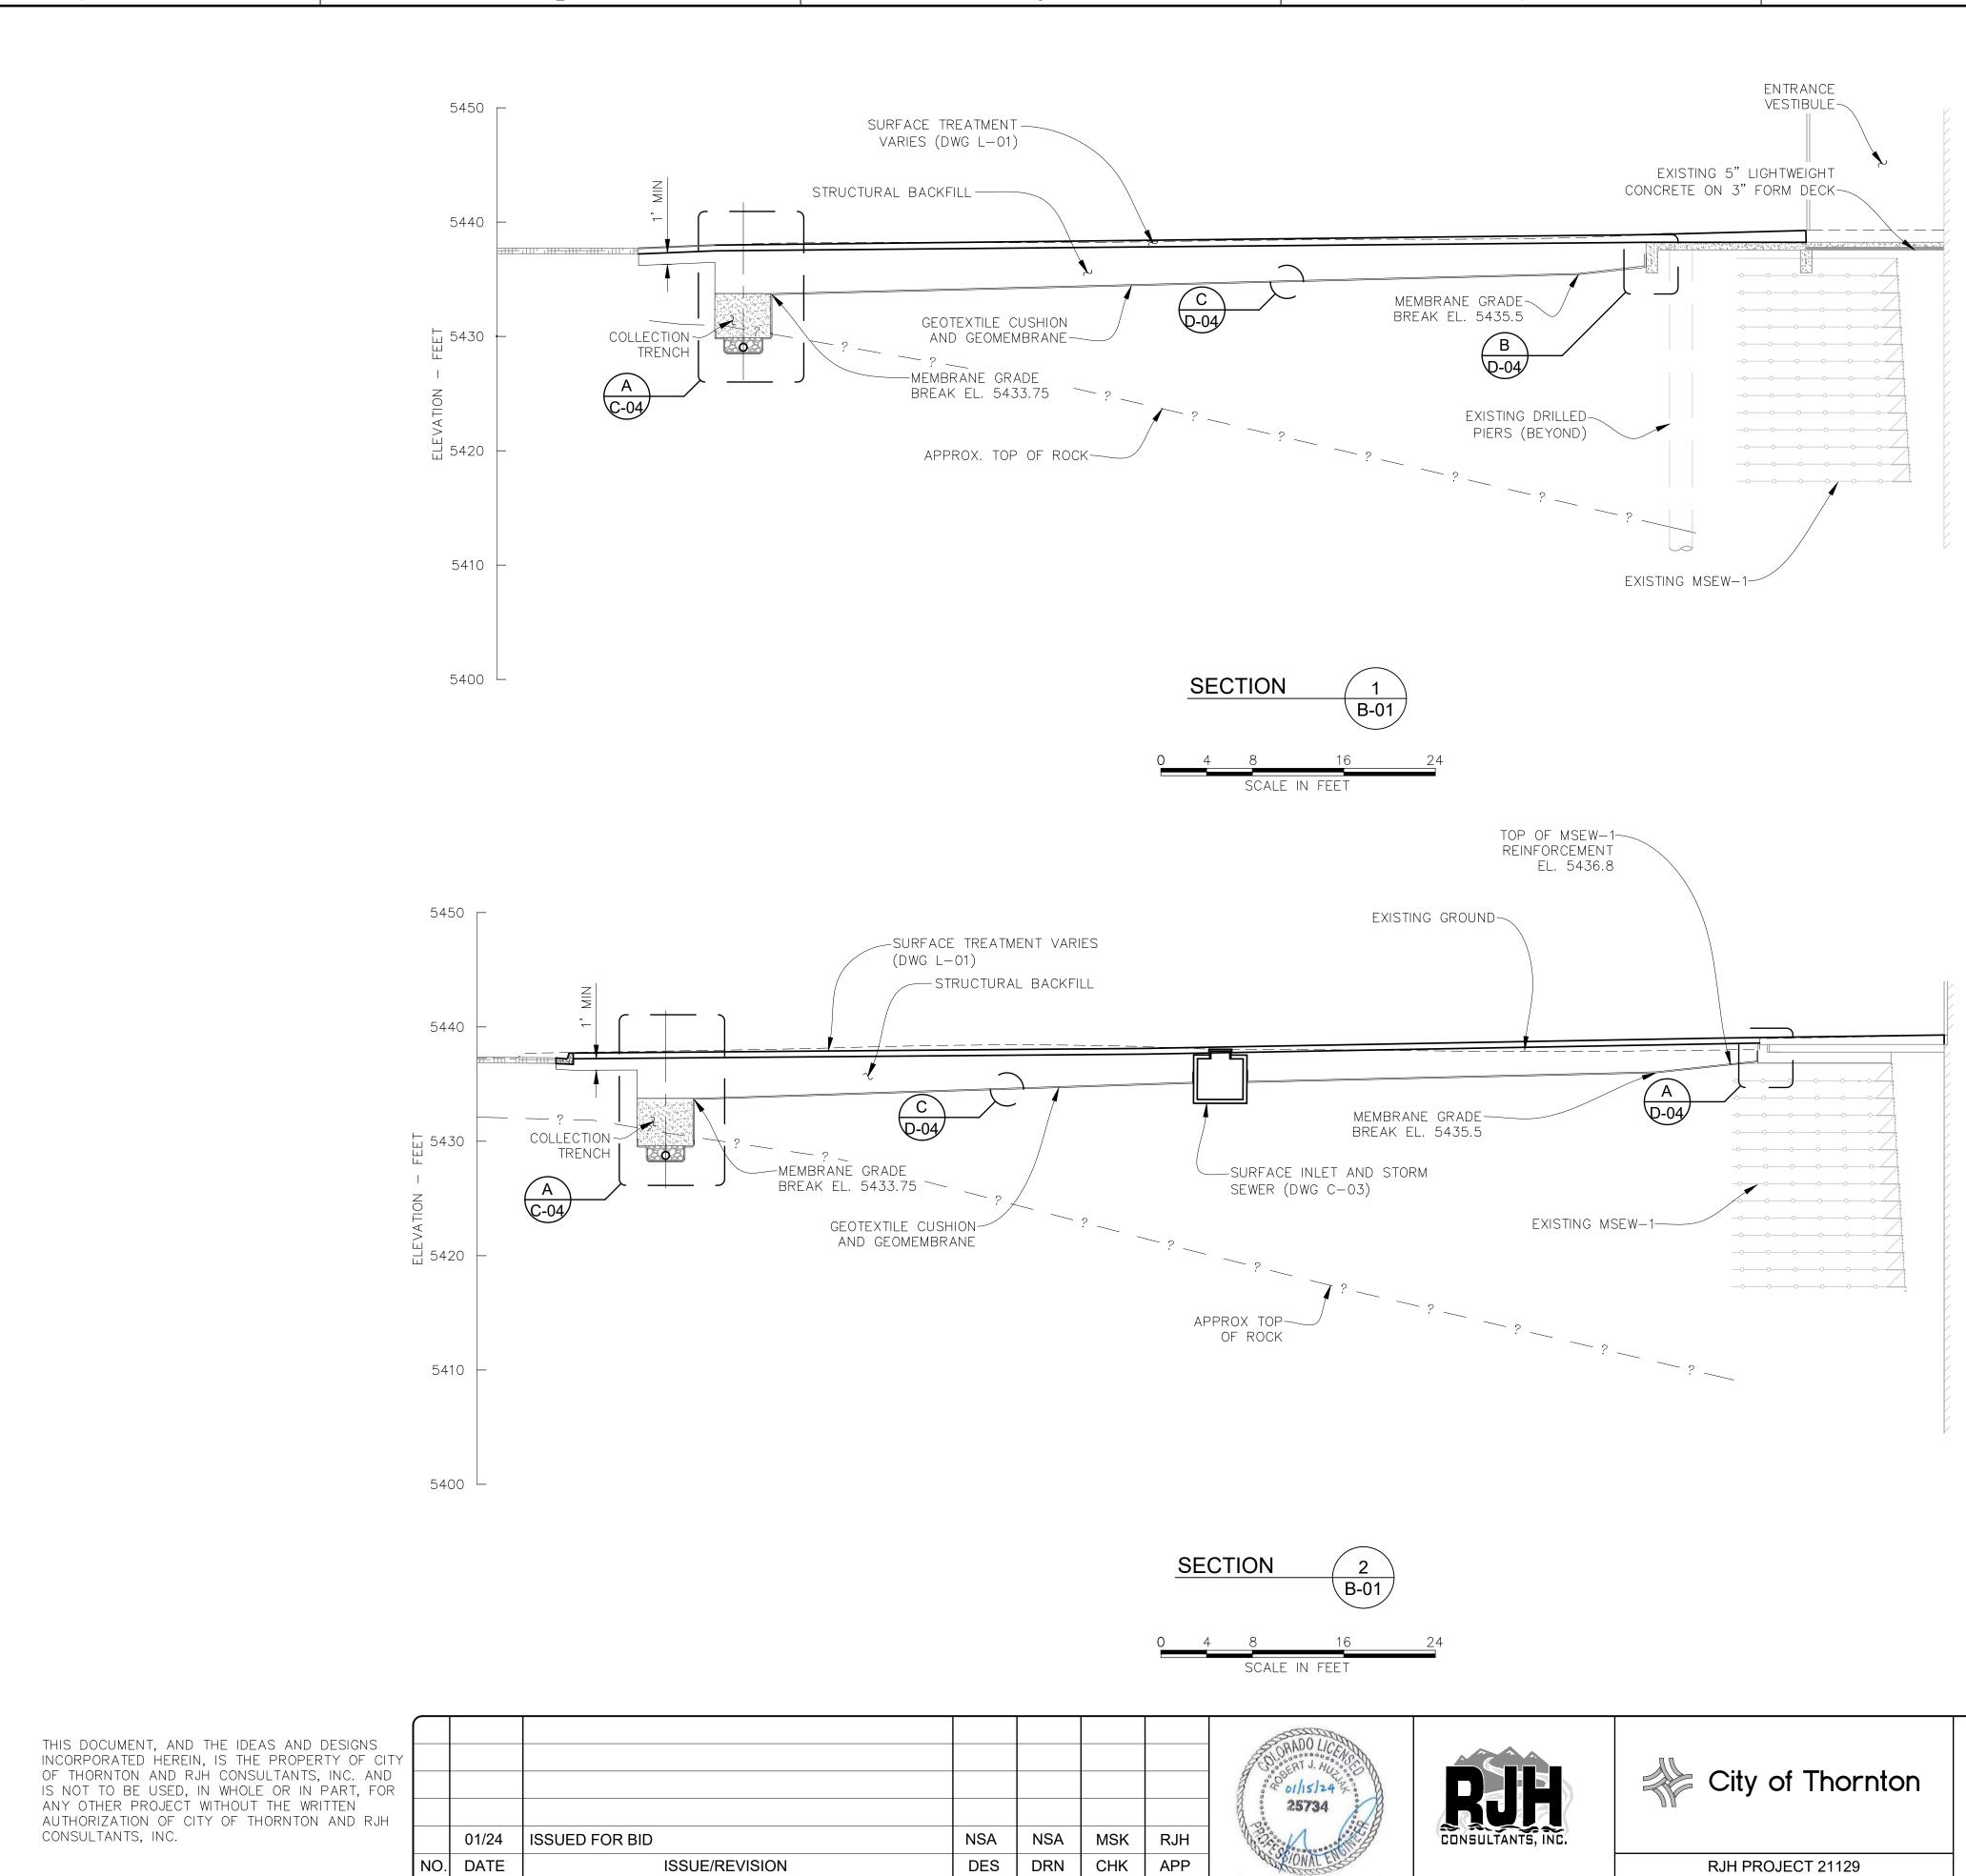

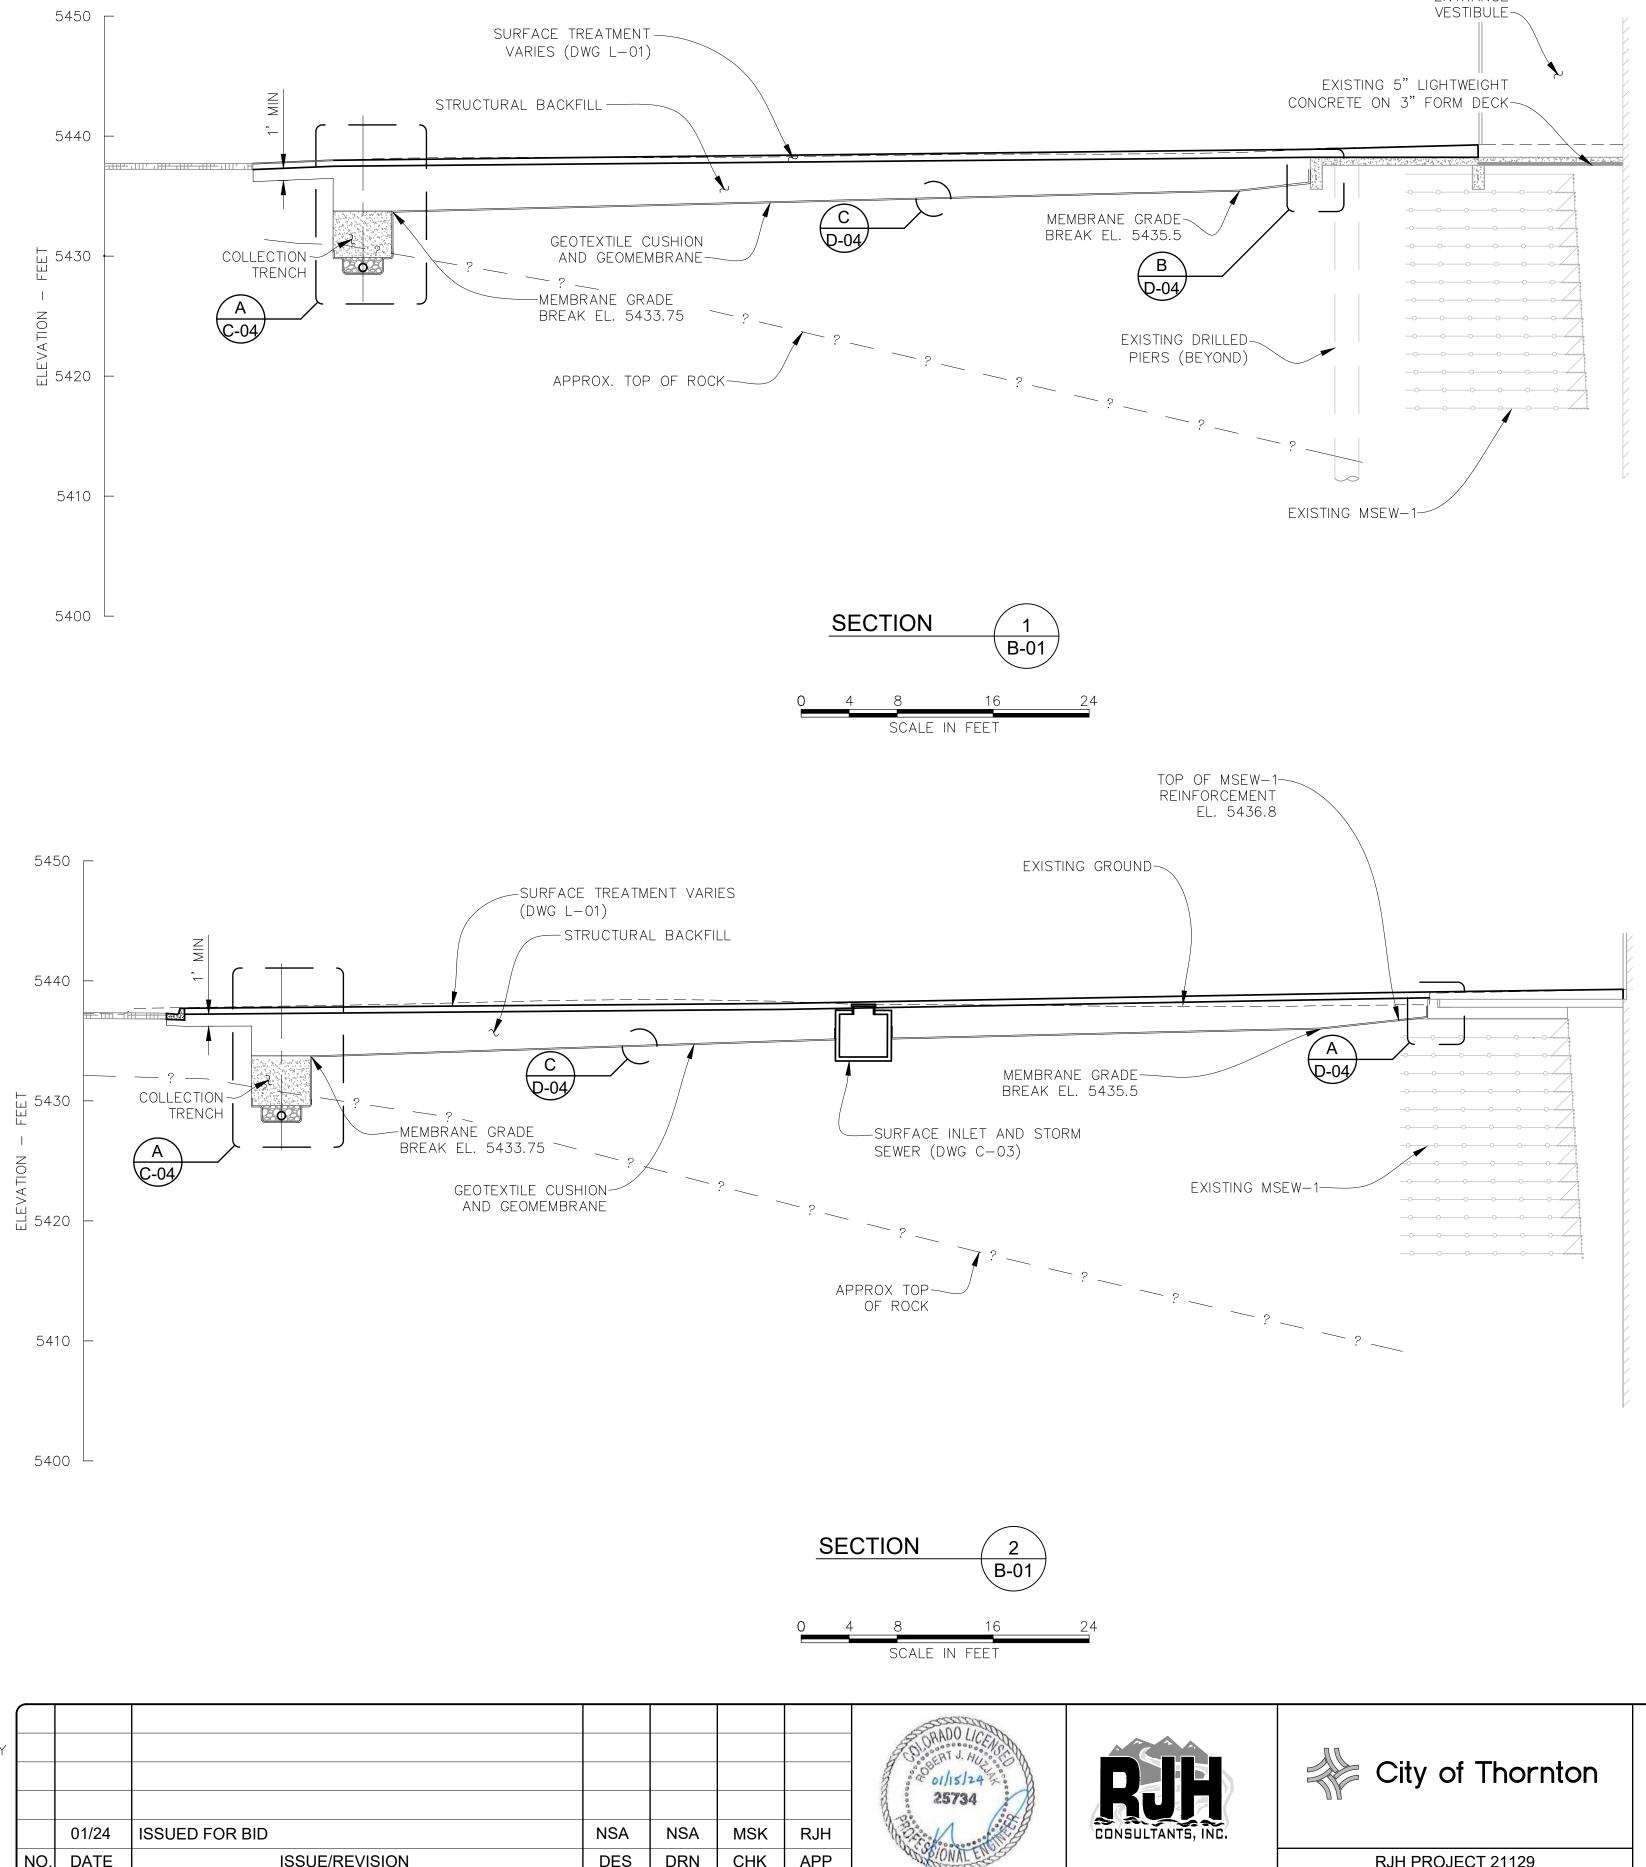



THORNTON JUSTICE CENTER	GEOMEMBRANE SECTIONS	dwg. no. B-02
PHASE III	(1 OF 2)	SHEET NO

SHEET NO.
15 of 46







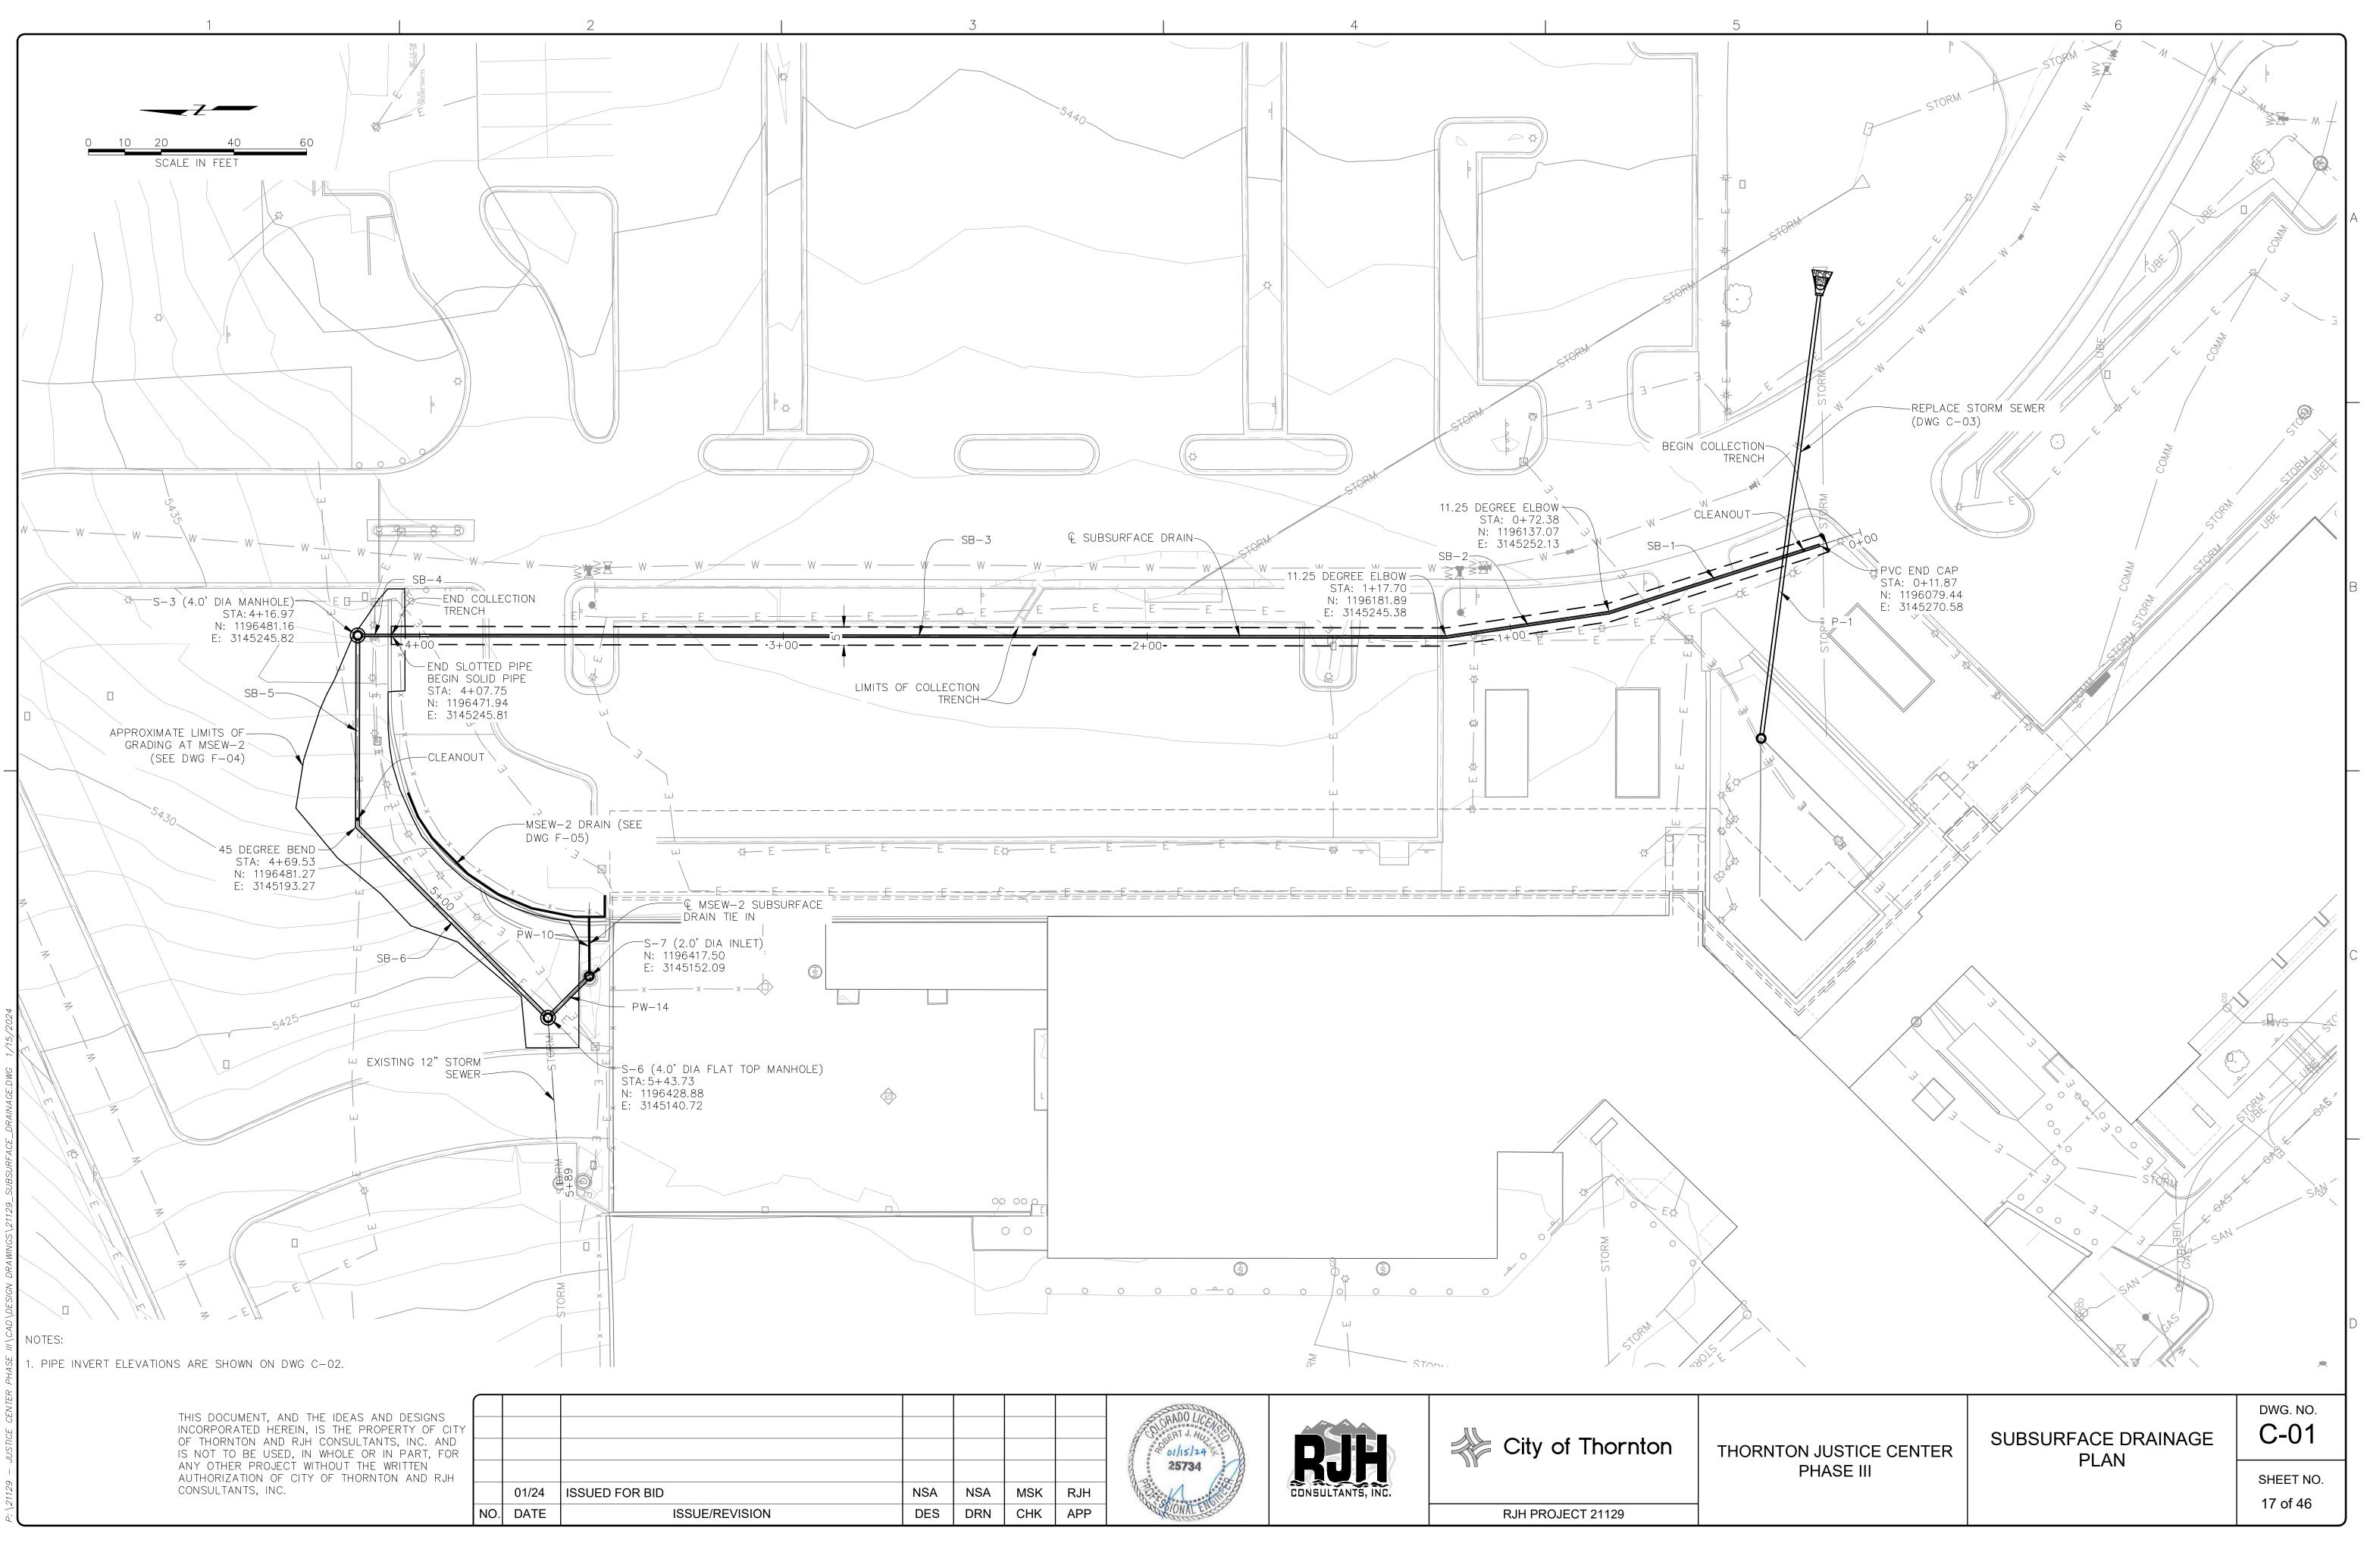

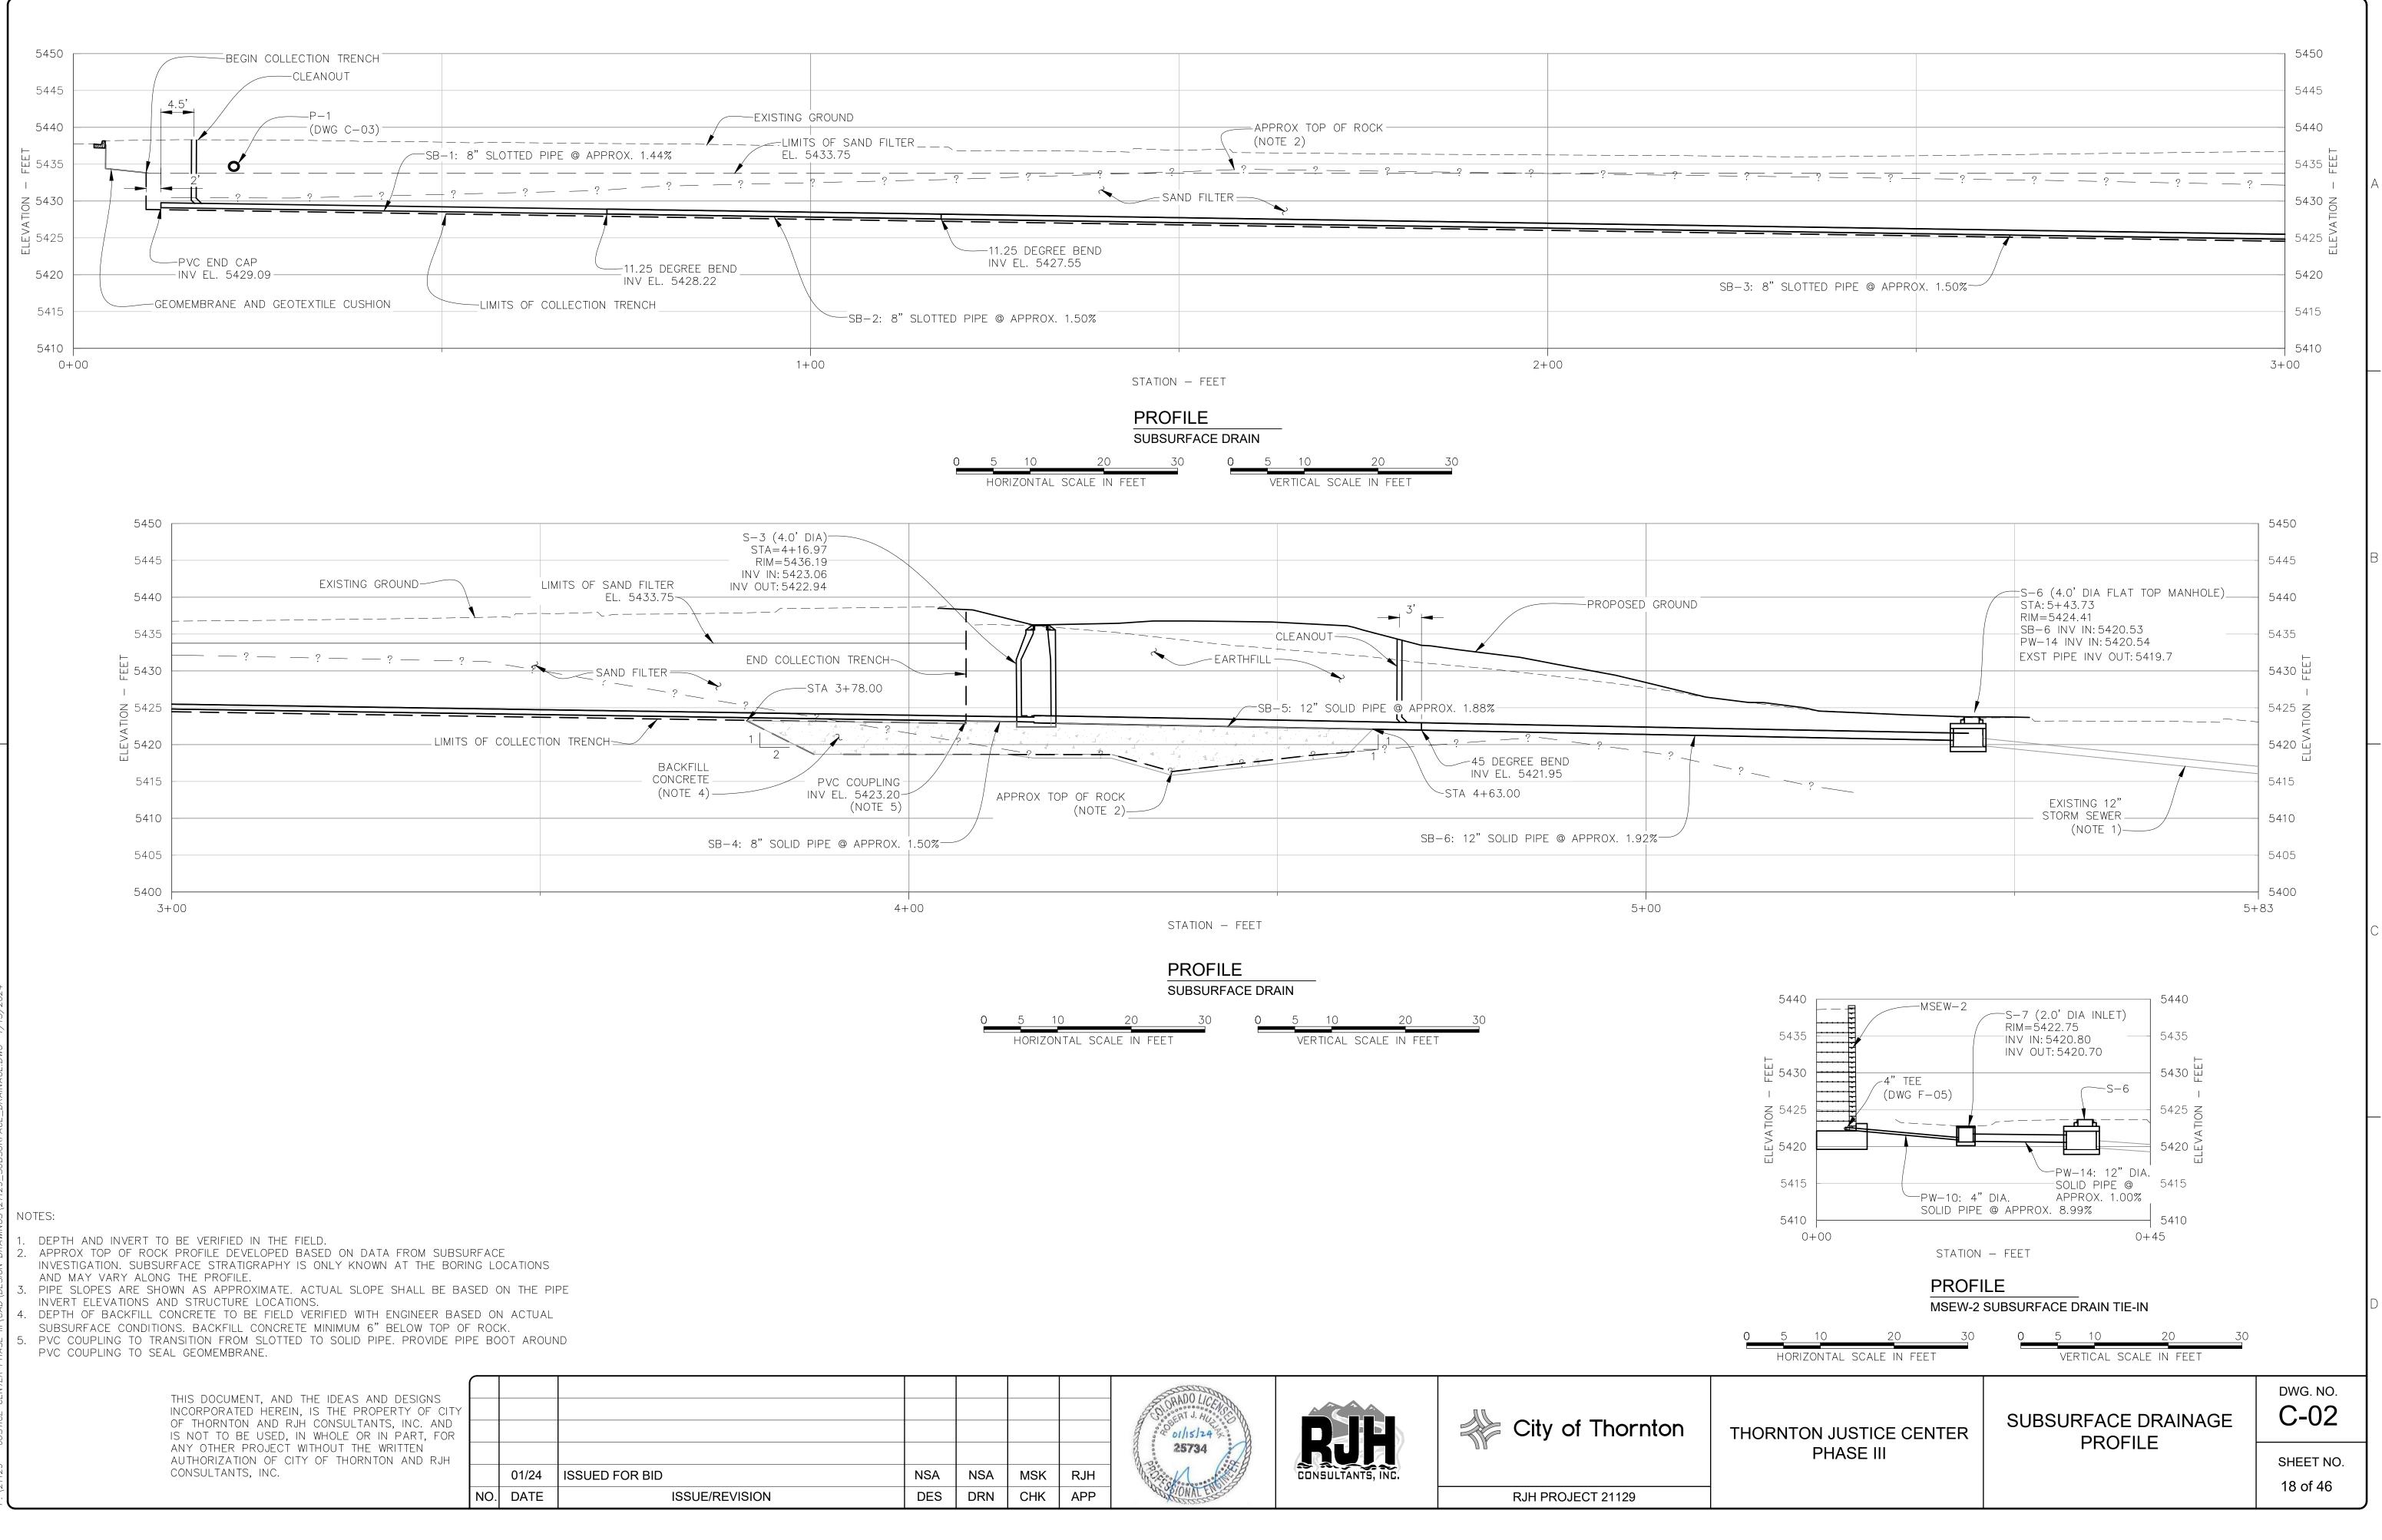




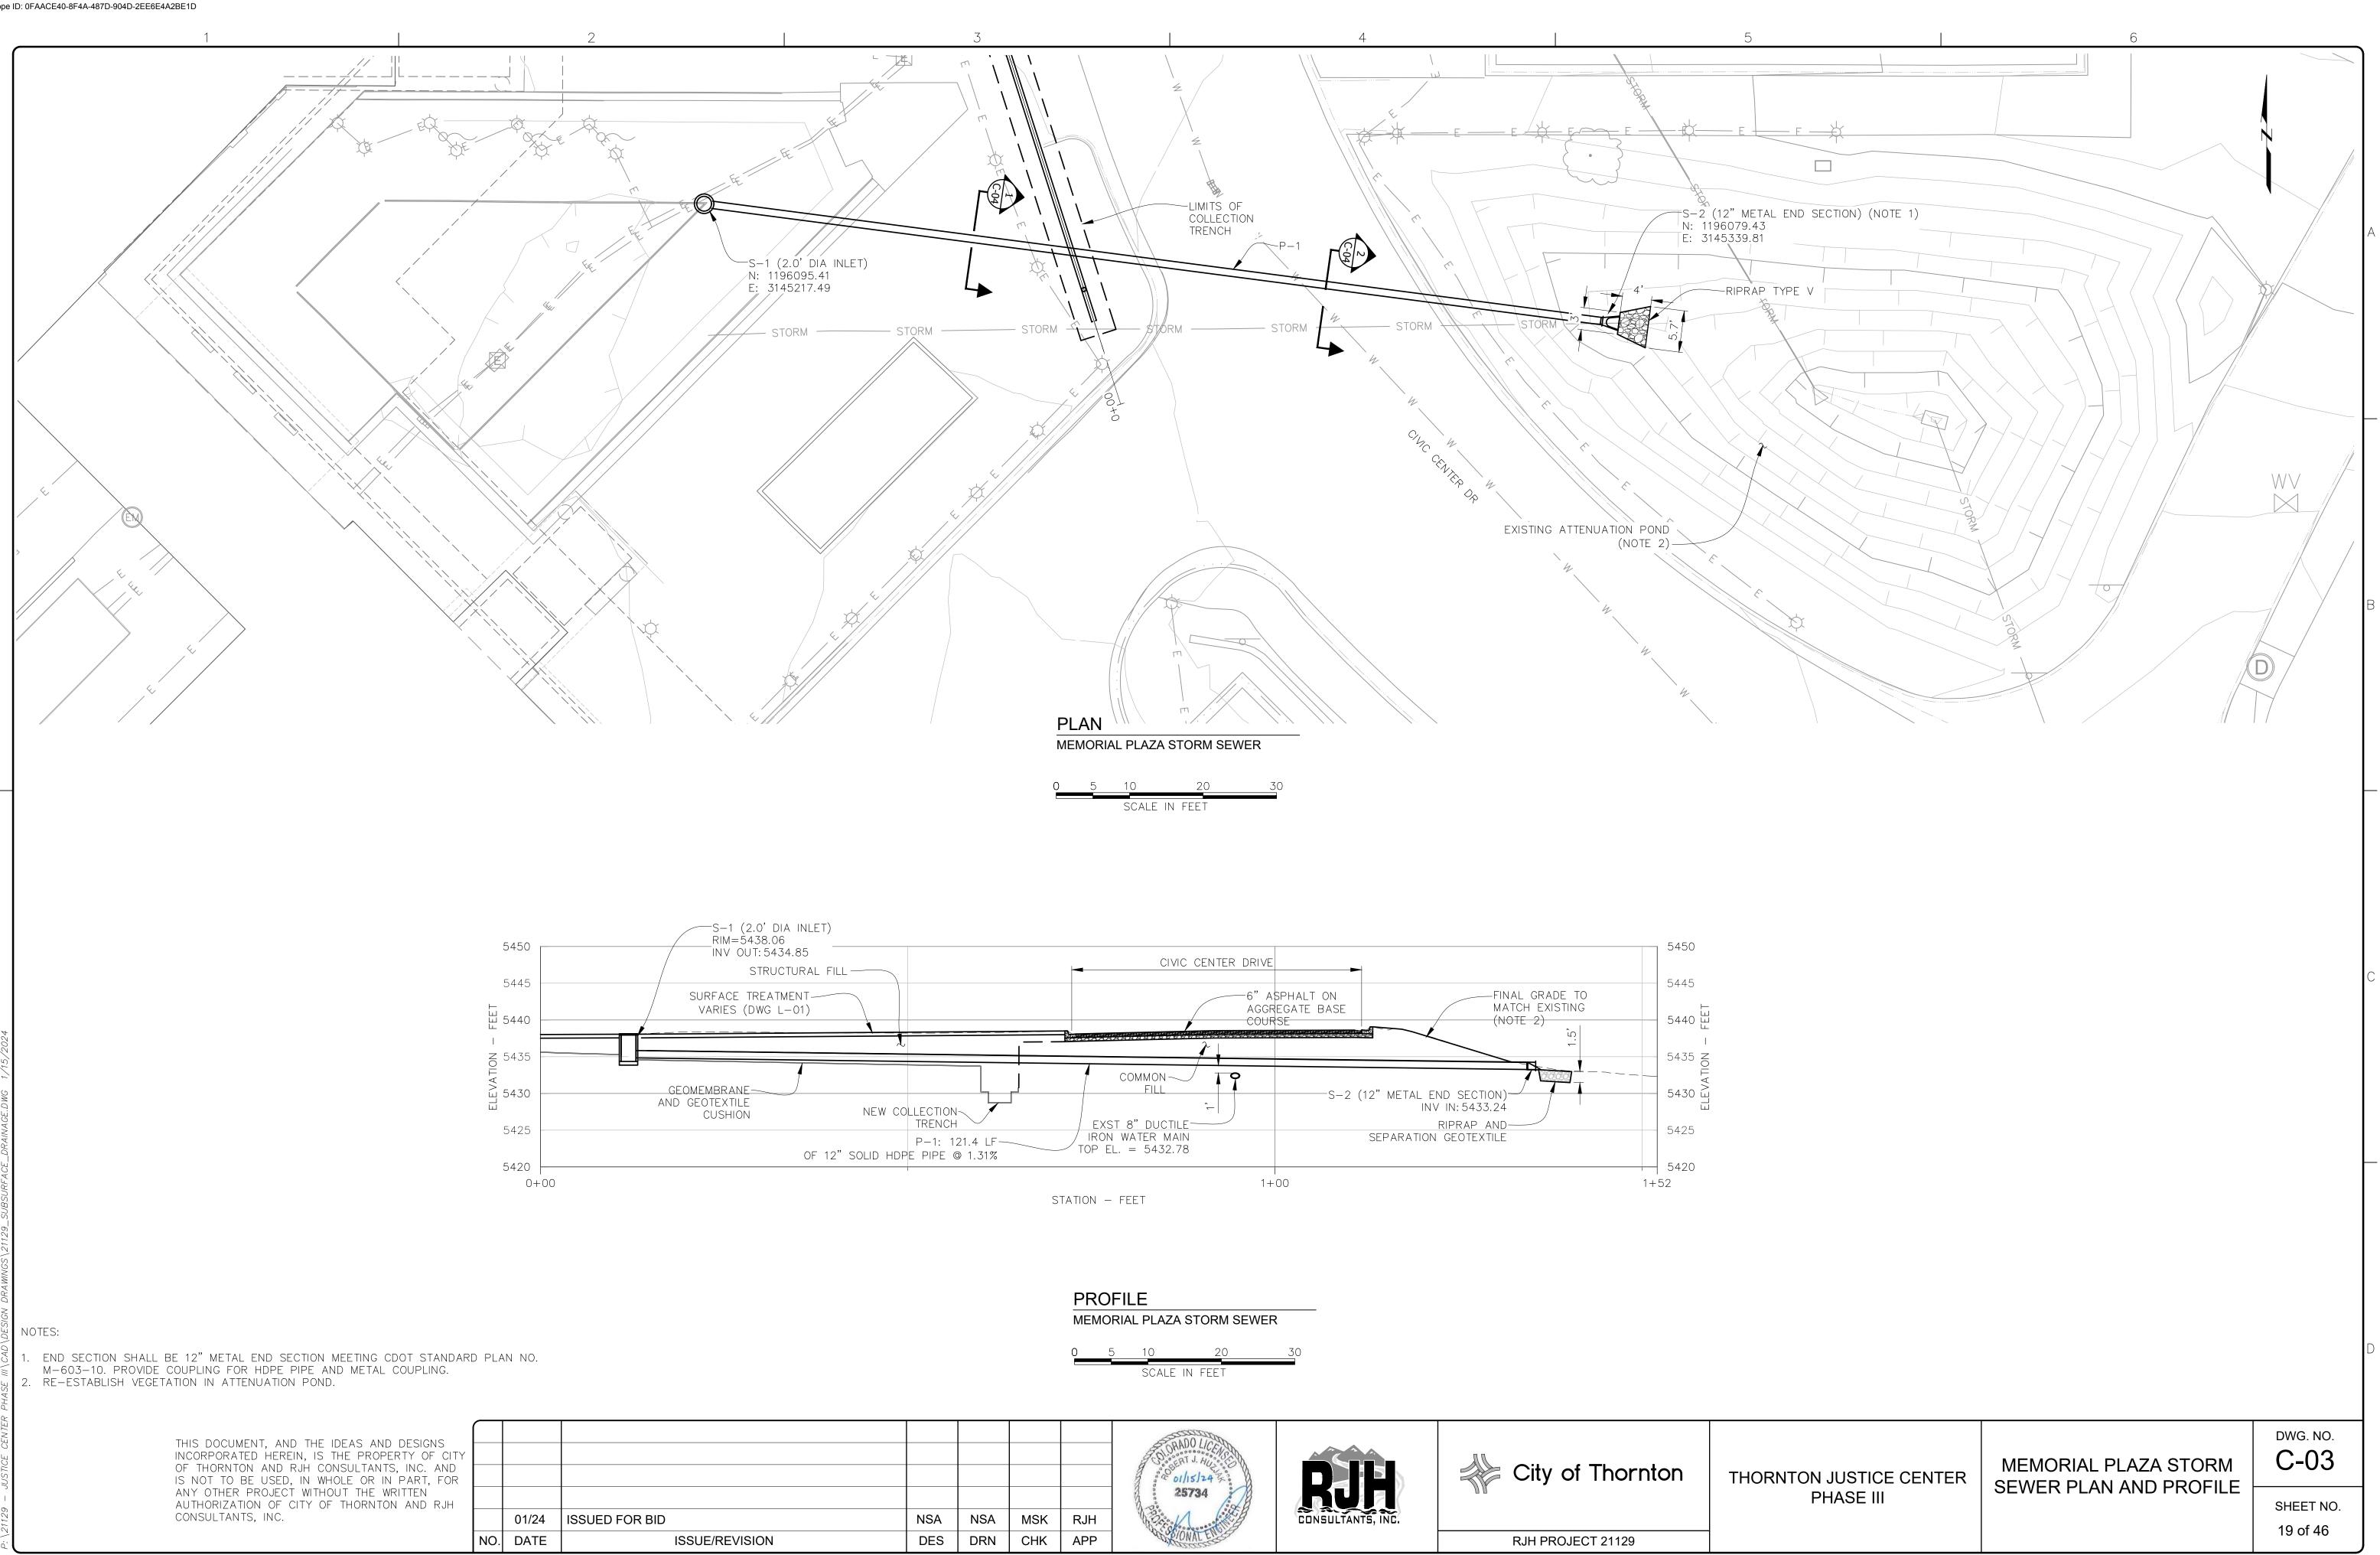


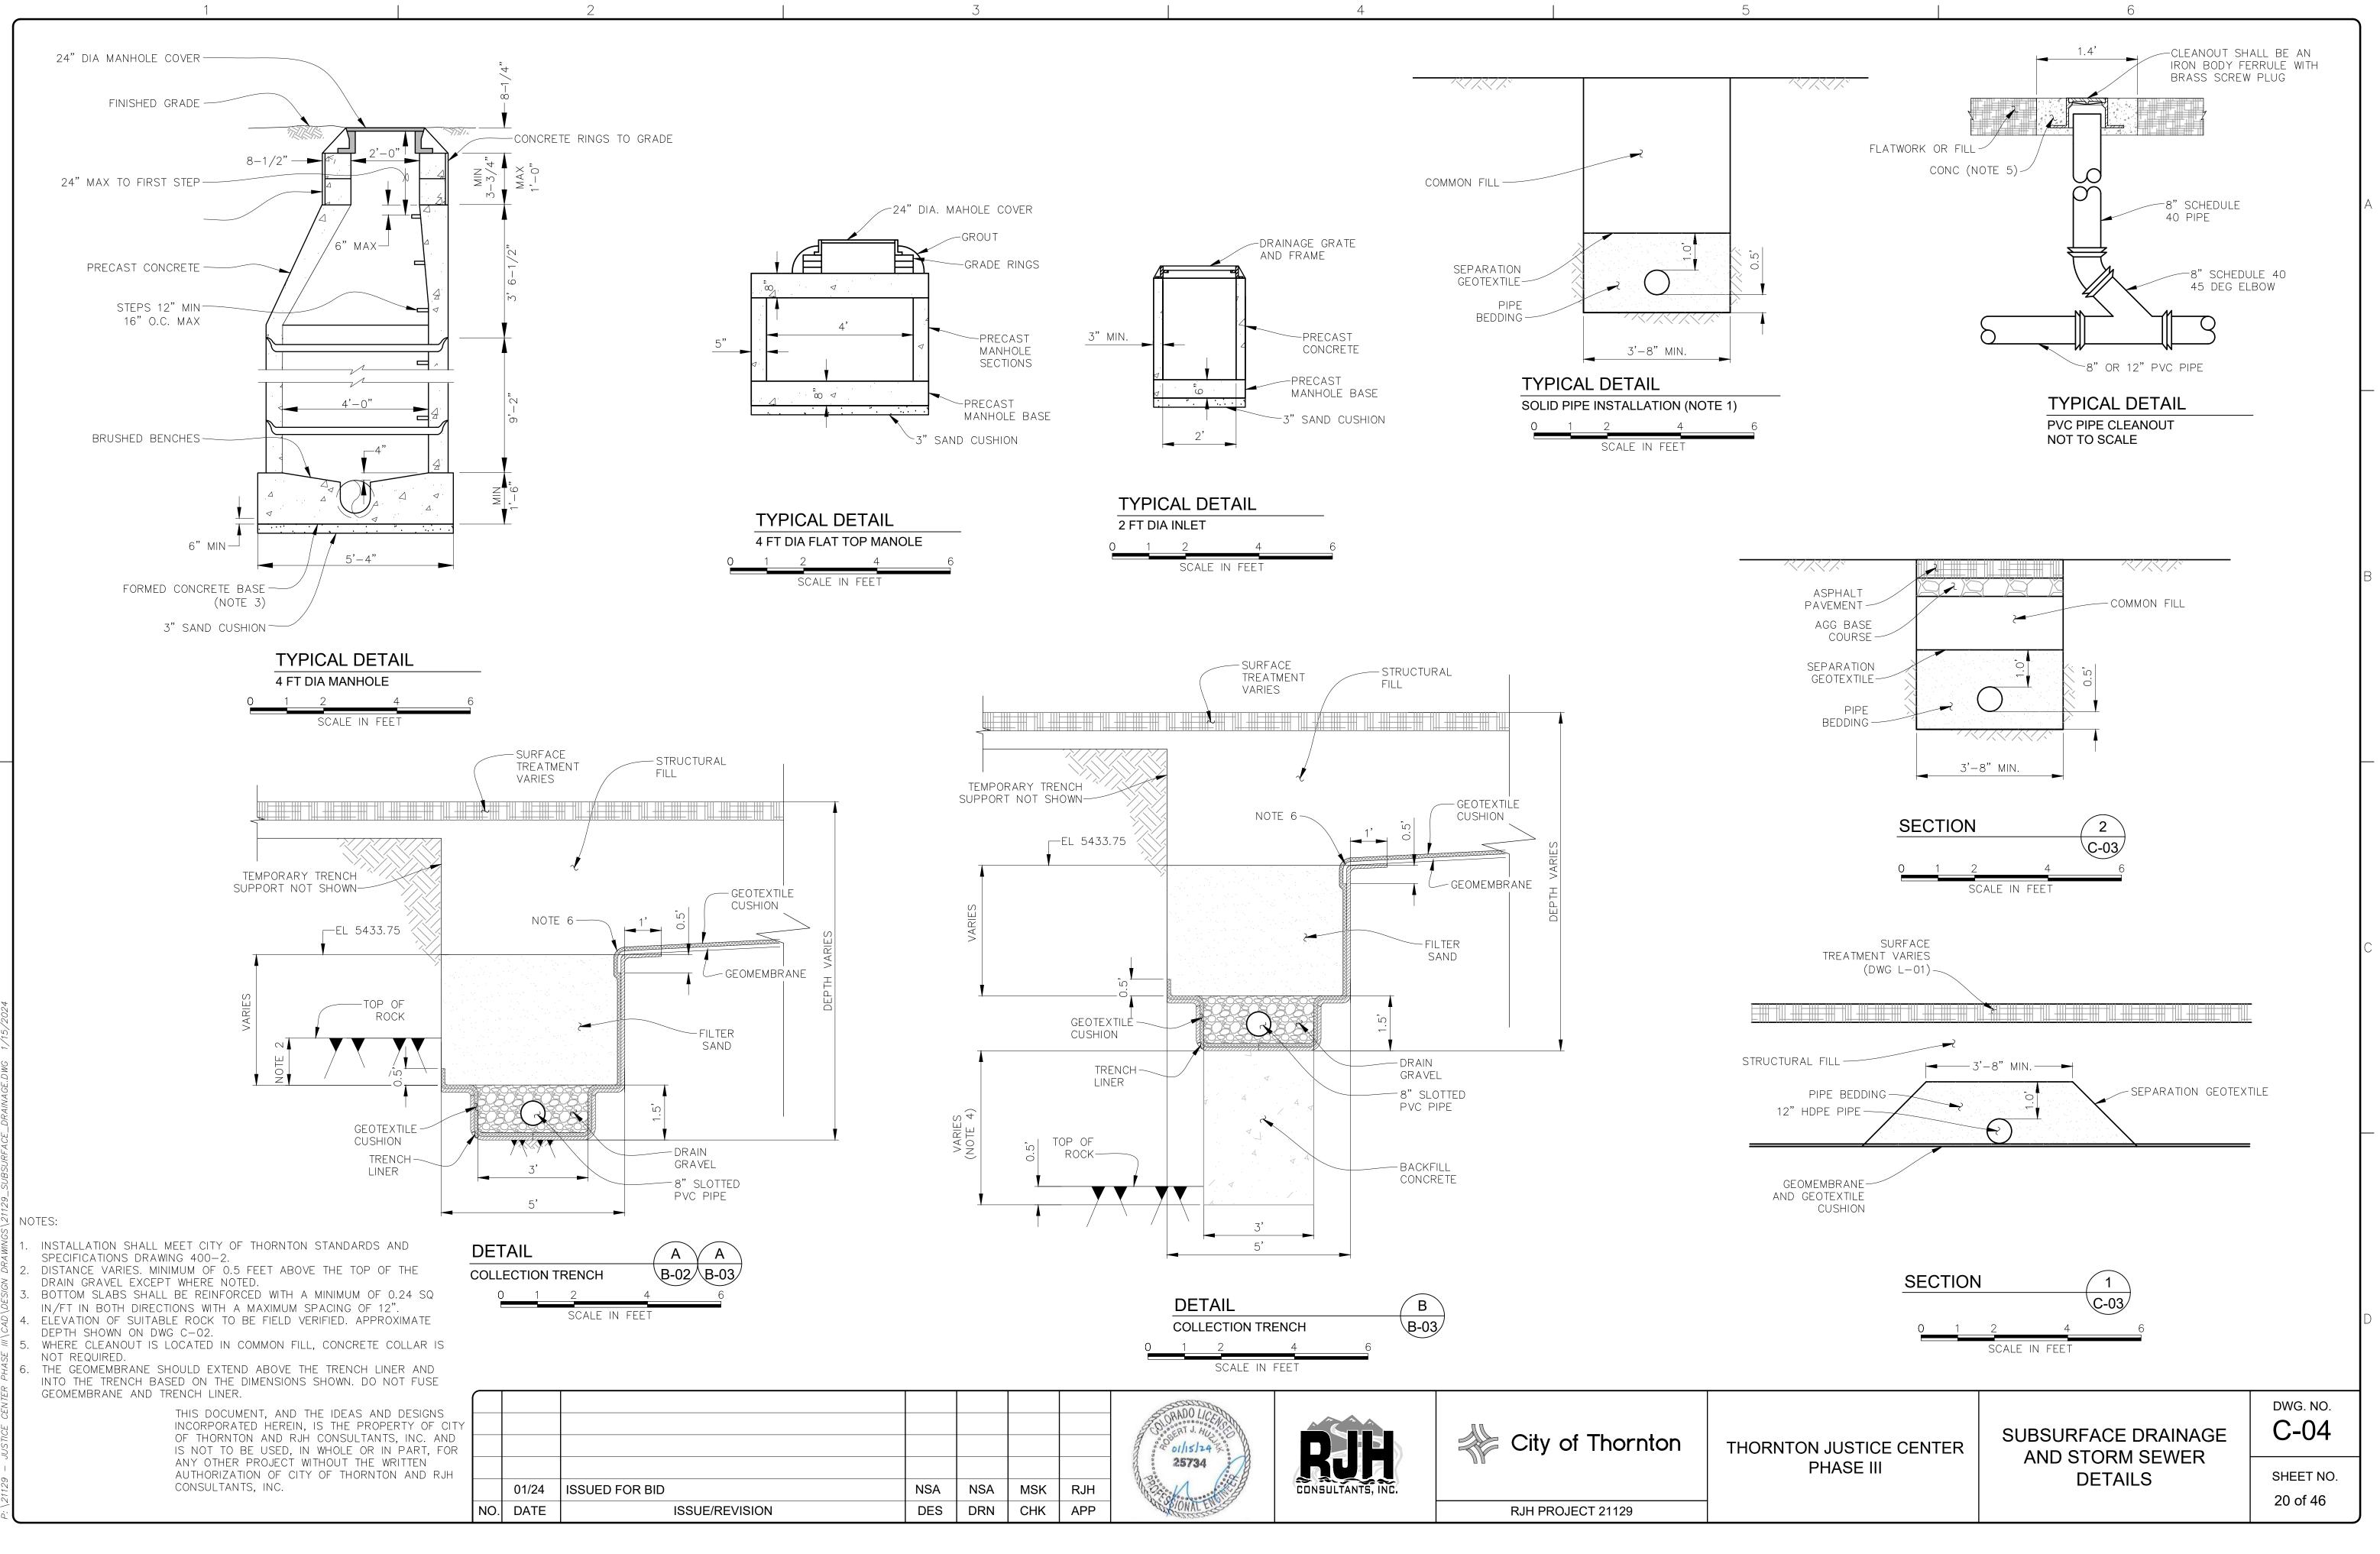


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	INCORPORATED HEREIN, IS THE PROPERTY OF CITY			
	THIS DOCUMENT, AND THE IDEAS AND DESIGNS			
2. EXS	ST INVERT IS ESTIMATED AND SLOPE WILL VARY BASED ON FIELD C OPE IS 0.5%.		IONS. MIN	IIMUM
LOC 4 F	CATION OF PIPE STRAP MOUNTING SHALL BE FIELD FIT TO MAINTAIN TEET BETWEEN STRAPS AND A MINIMUM CLEARANCE OF 2.5" TO TH NCRETE.	I A M	IAXIMUM S	SPACING OF
1 DID	E STRAPS SHALL BE STAINLESS STEEL AND MOUNTED TO CONCRET		<u>.</u> <u>3</u> " doi	75
NOTES:				



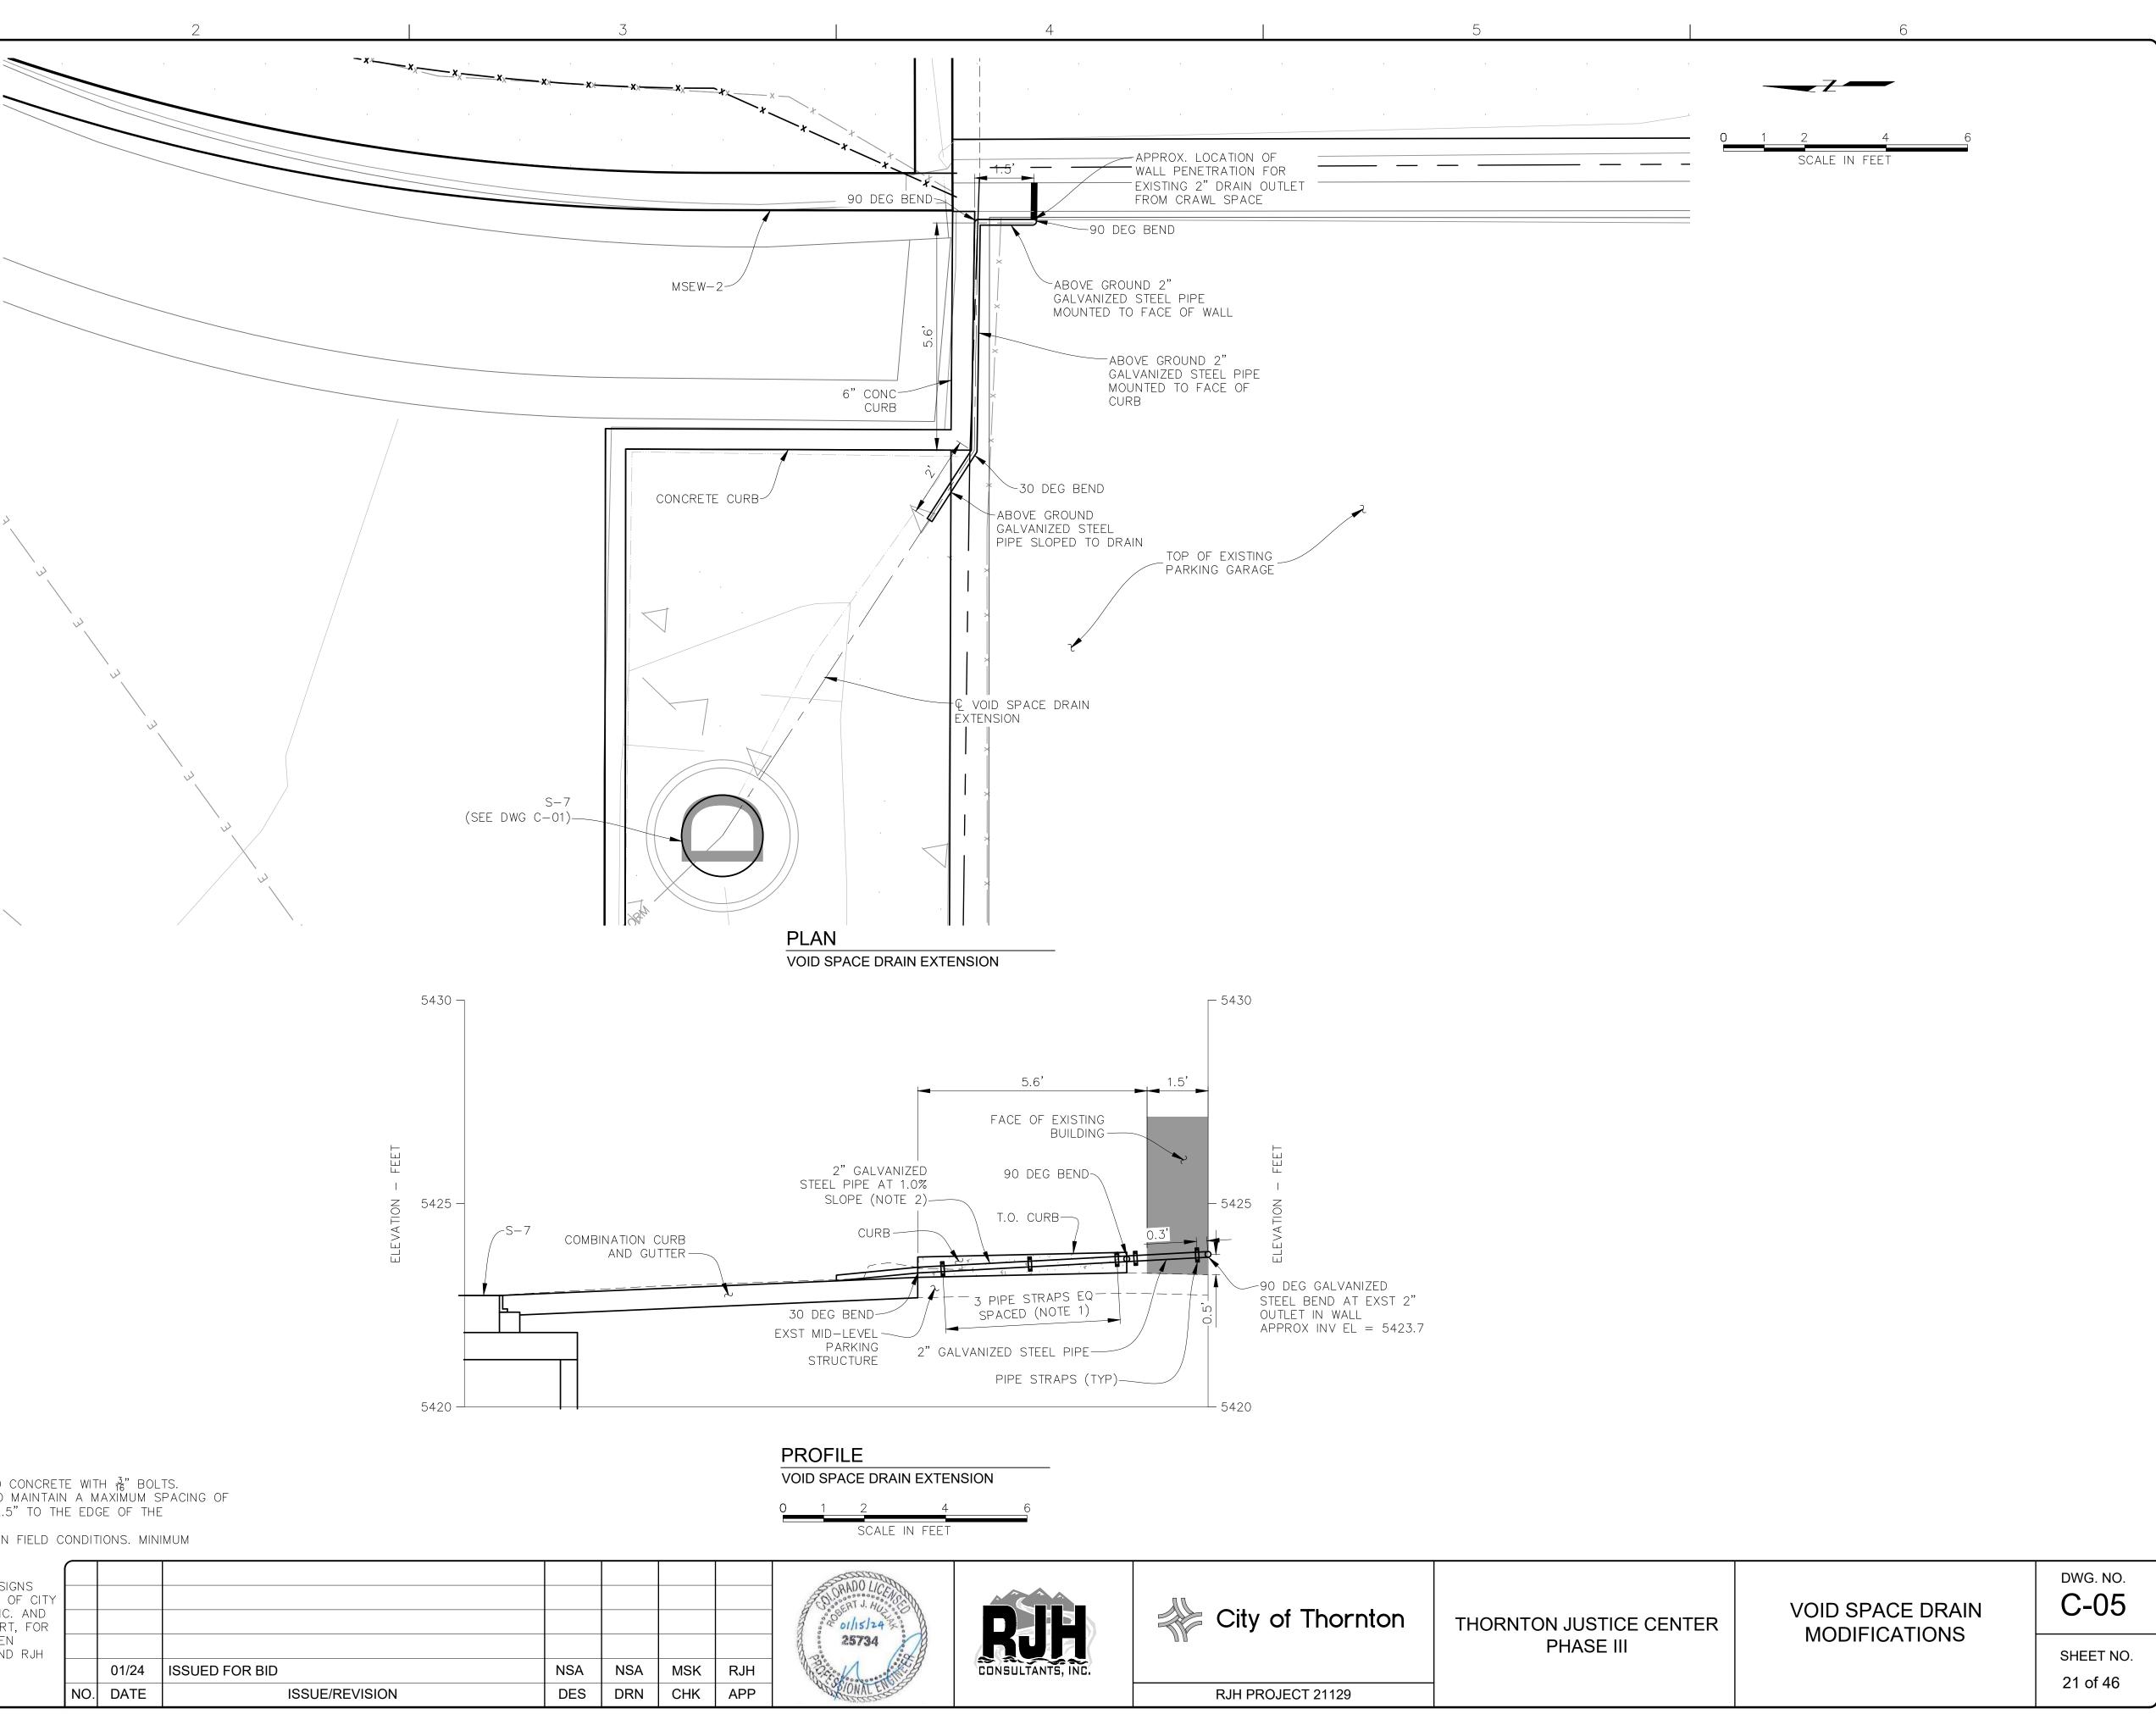

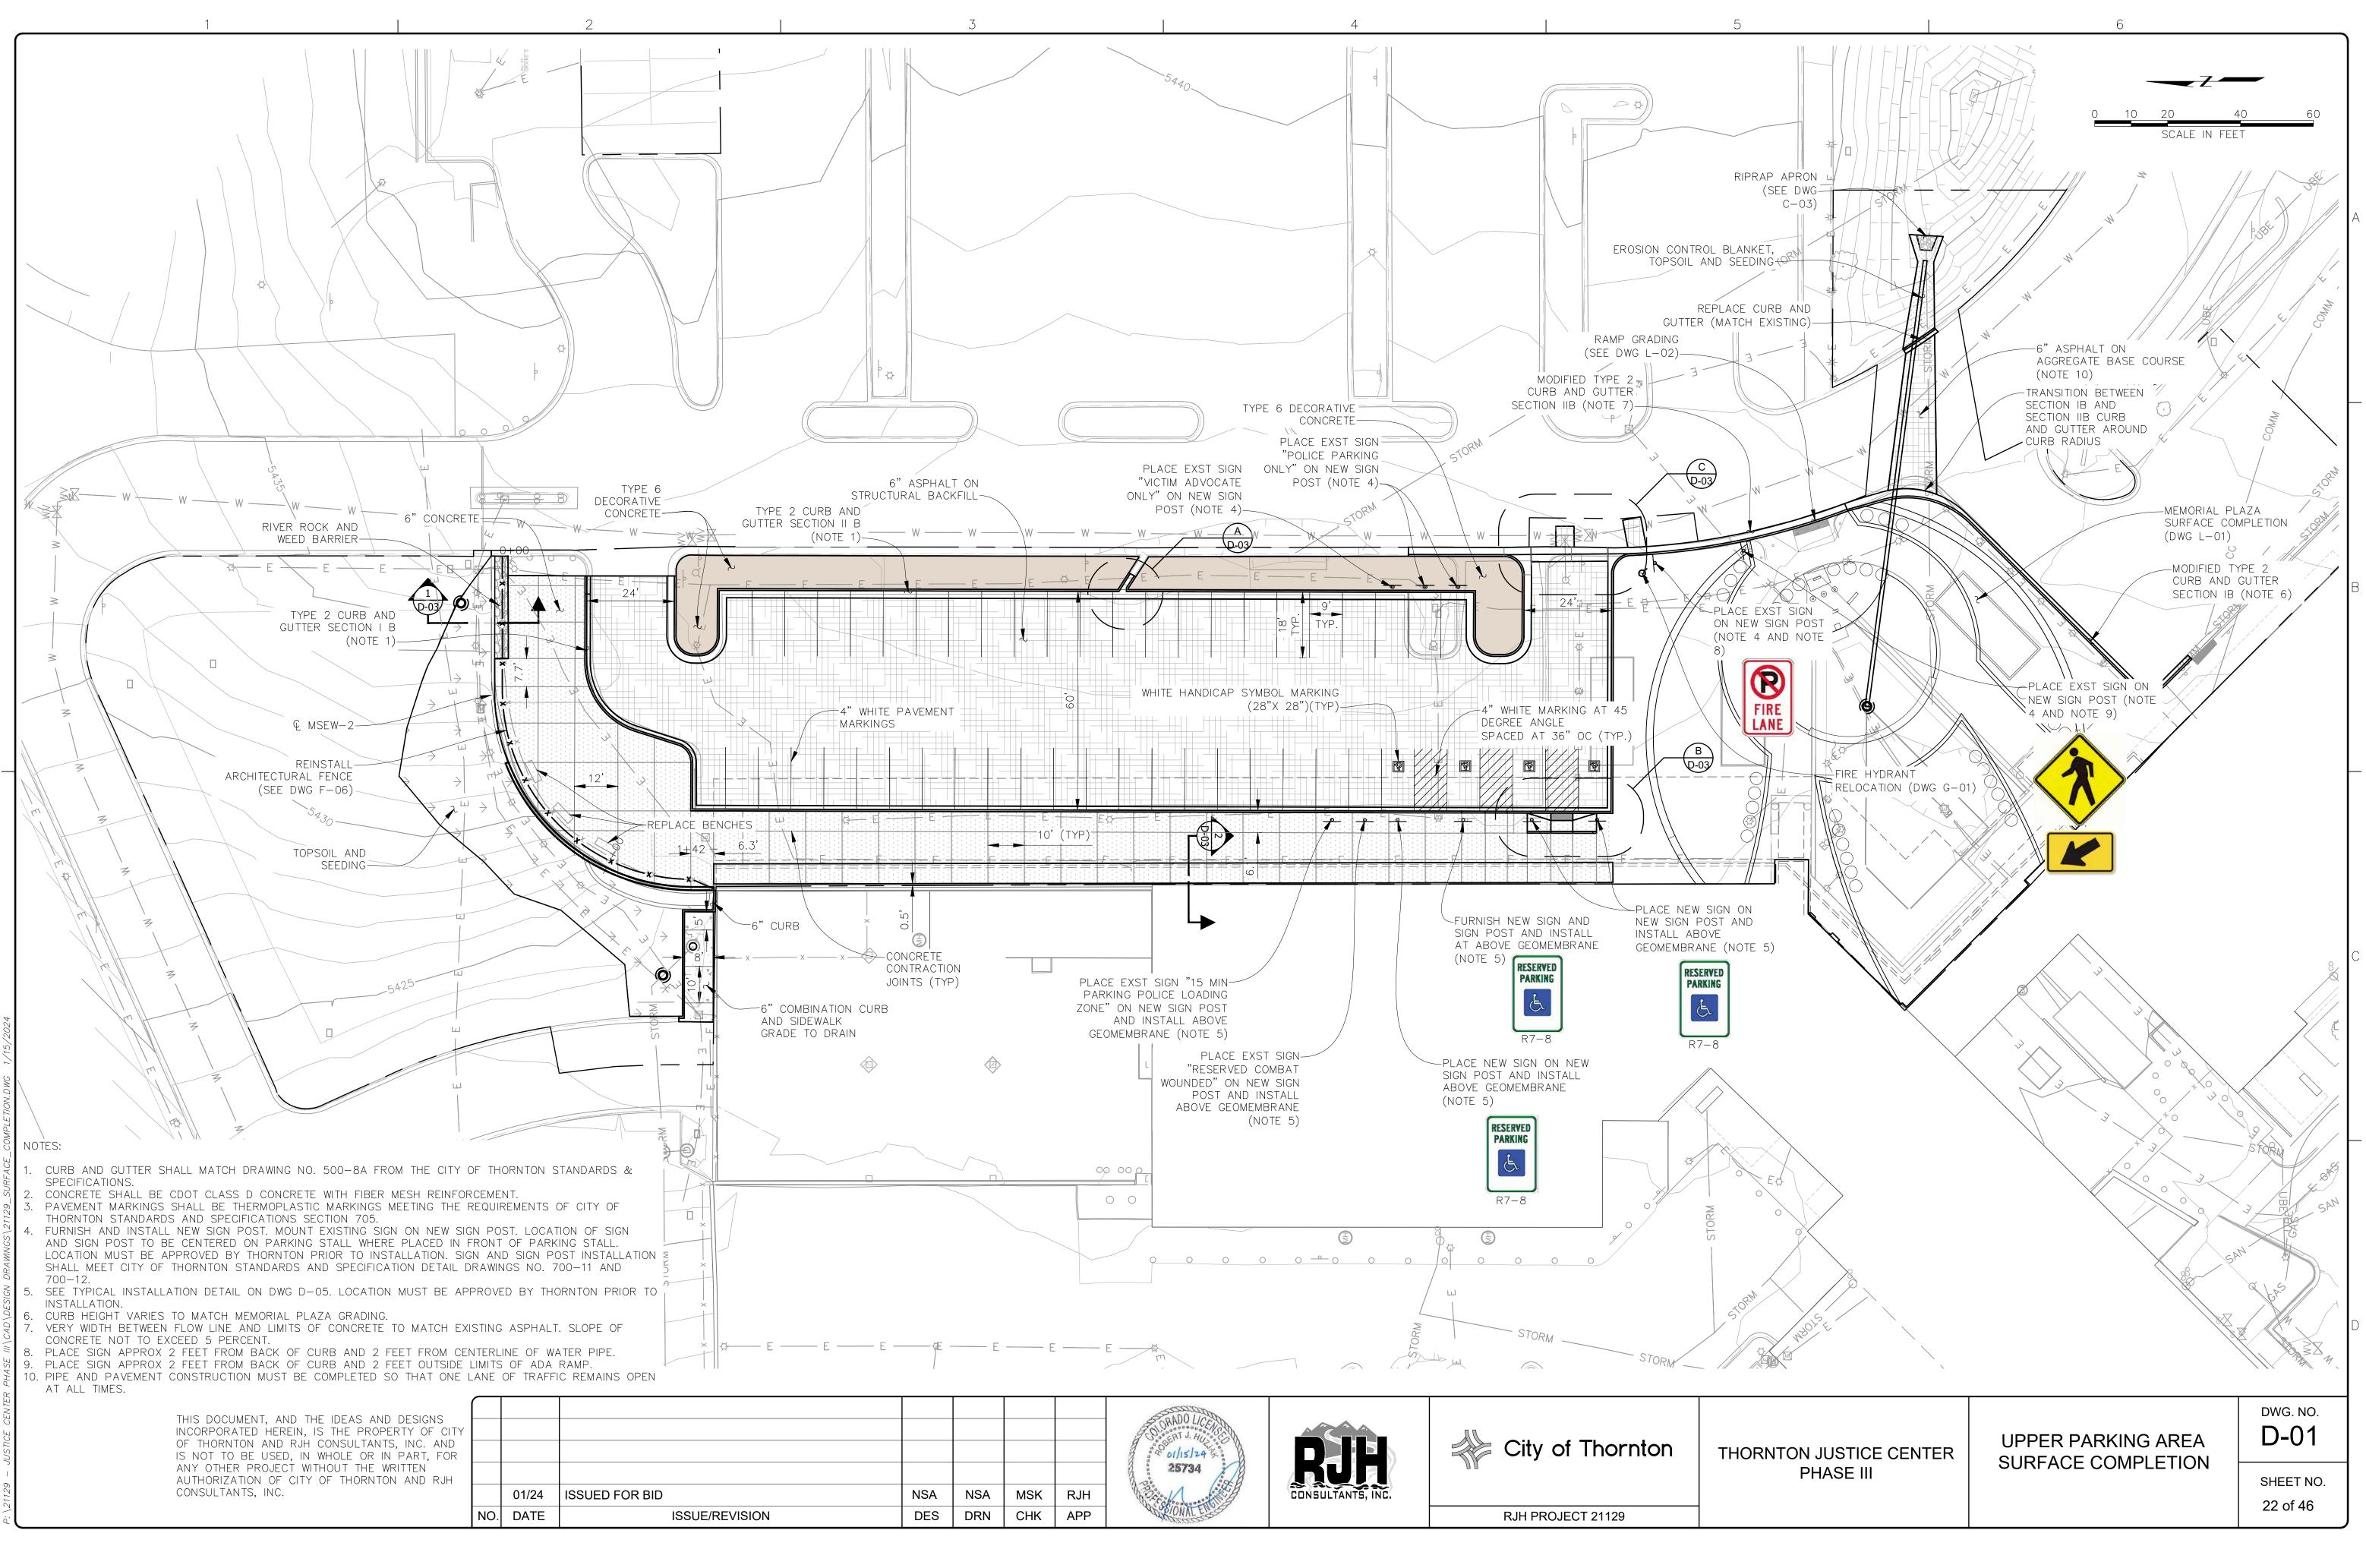

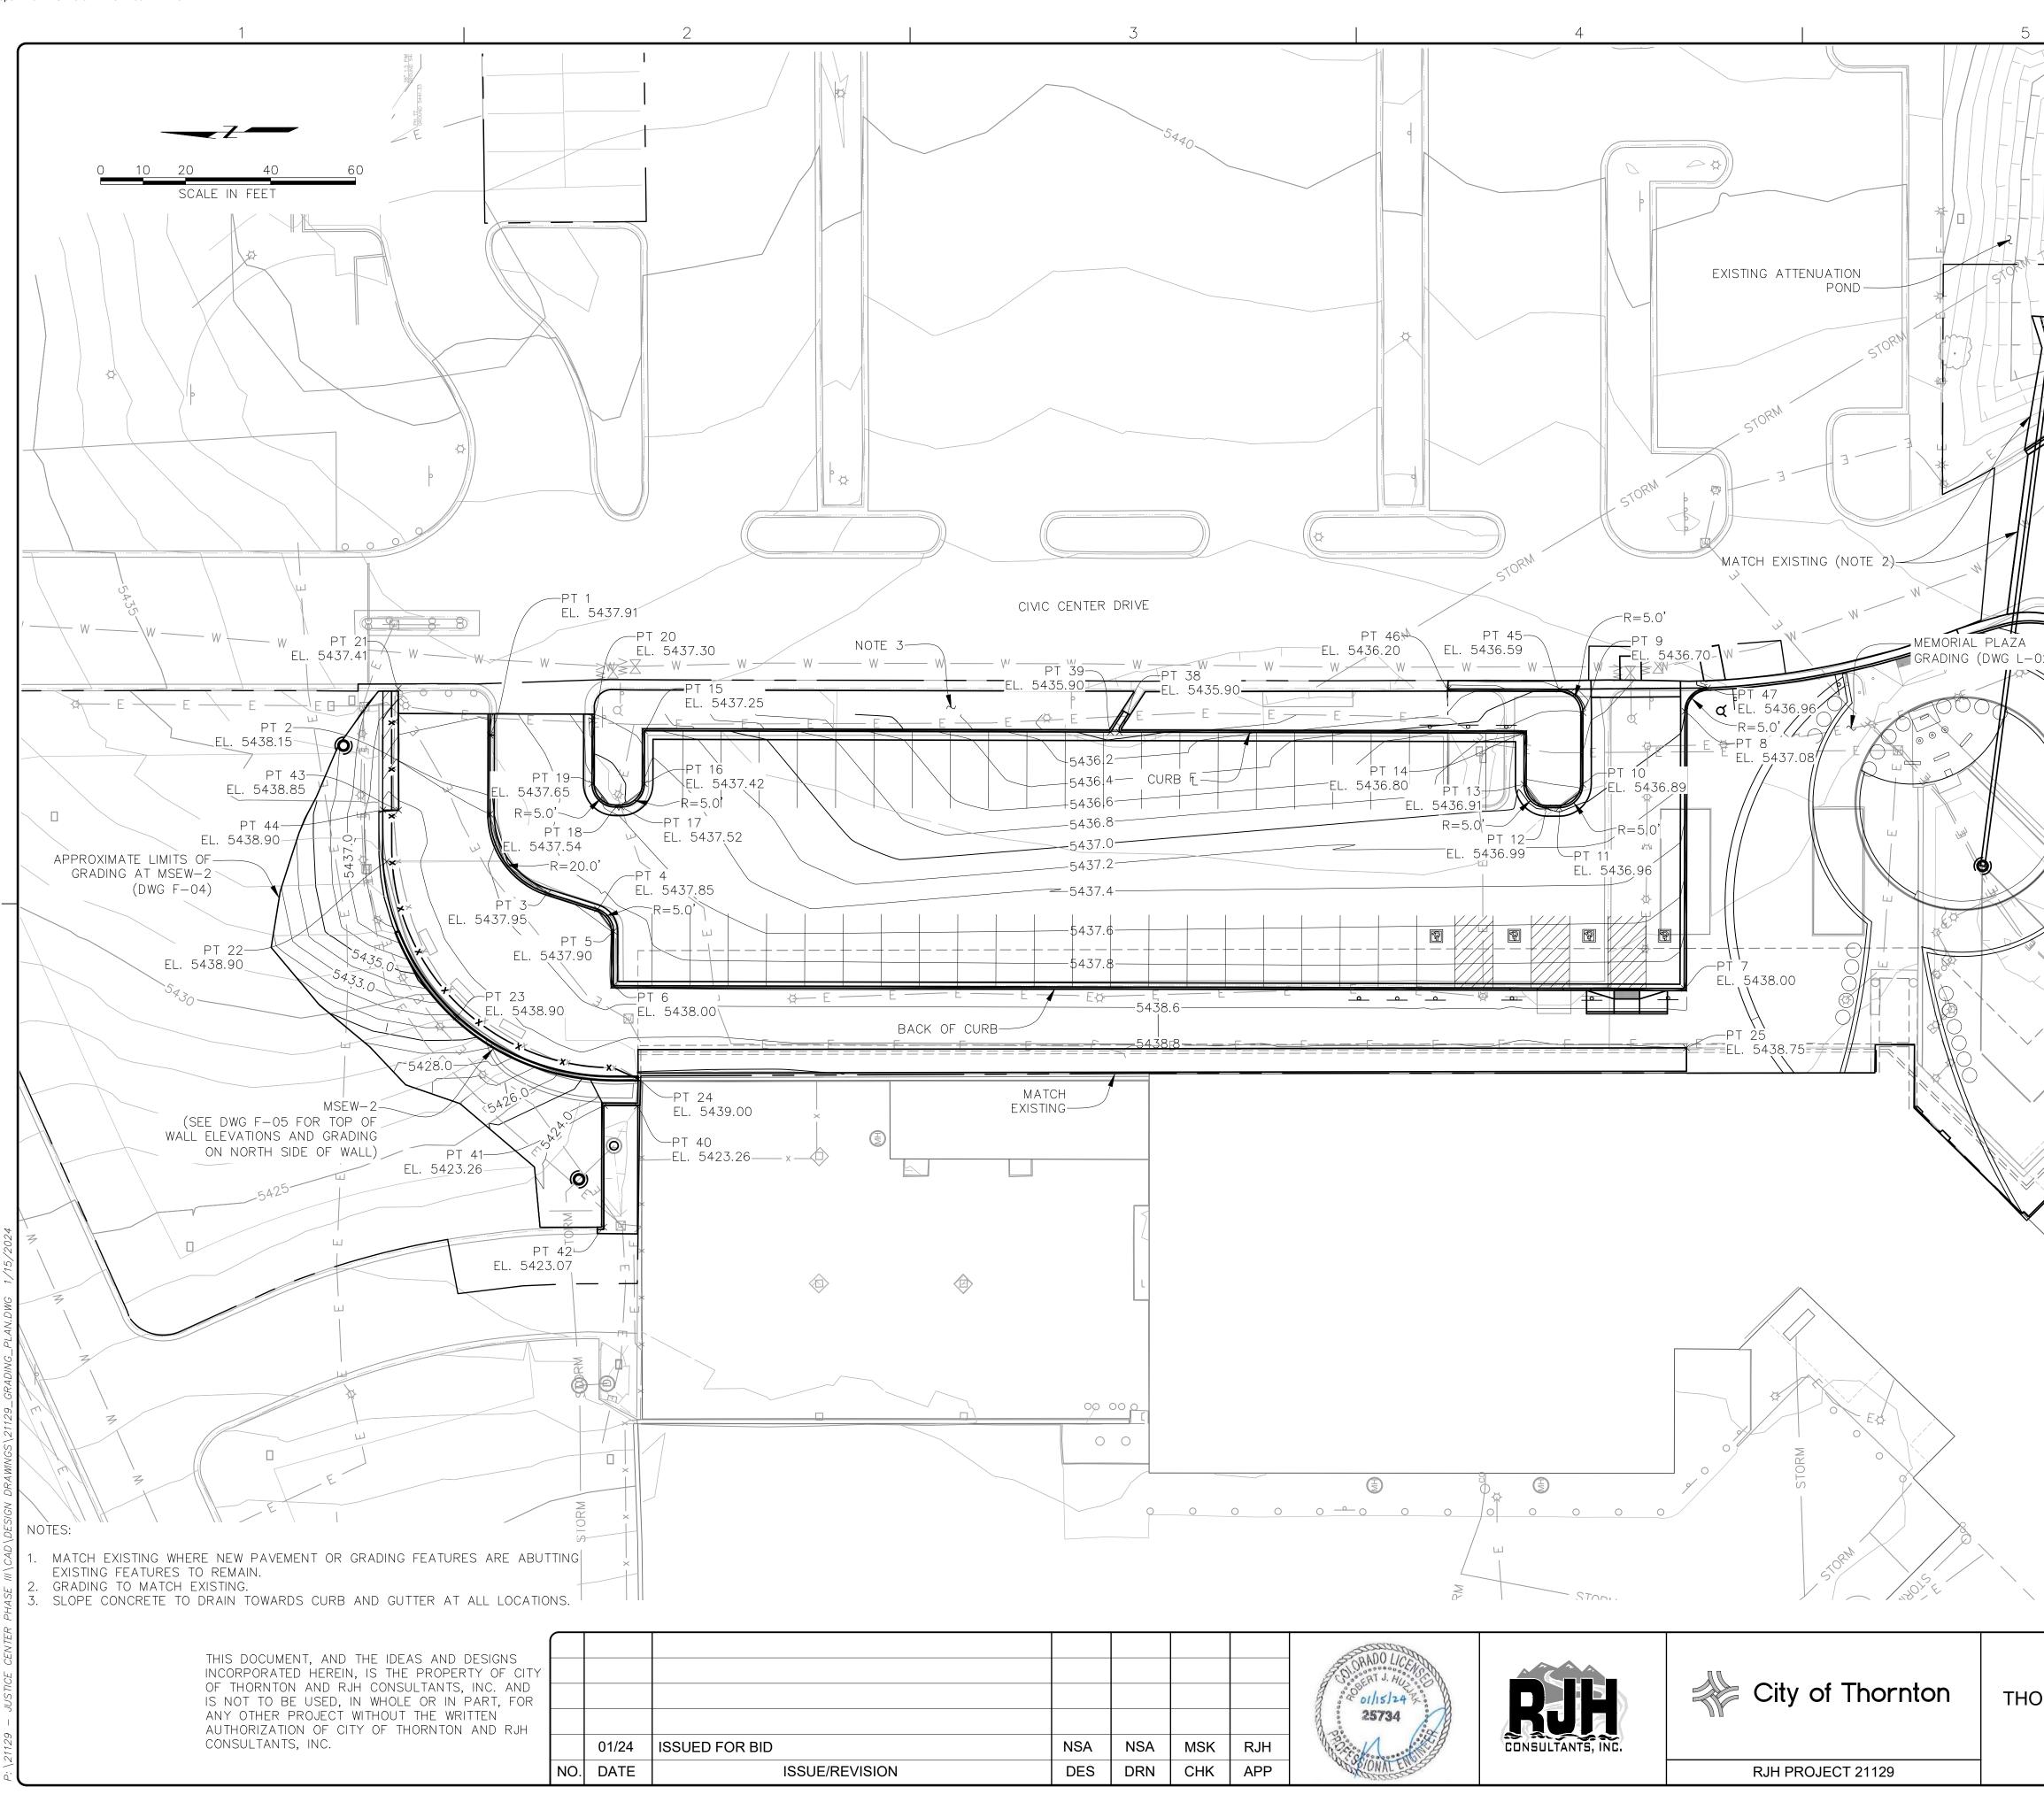

TORM		
	POINT	ELEVAT
	1	5437.
	2	5438.
	3	5437.9
	4	5437.8
	5	5437.9
N	6	5438.0
STOR	7	5438.0
N N	8	5437.0
	9	5436.
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	11	5436.9
	12	5436.9
C C C C C C C C C C C C C C C C C C C	13	5436.
	14	5436.8
02)	15	5437.3
	16	5437.4
	17	5437.
	18	5437.
	19	5437.6
	20	5437.
	21	5437.
	22	5438.9
	23	5438.9
	24	5439.0
	25	5438.
	38	5435.9
	39	5435.9
	40	5423.2
	41	5423.
	42	5423.0
	43	5438.8
	44	5438.9
	45	5436.
	46	5436.2
	47	5436.9
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	** M <i>A</i>	TCH EXI
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		POINT	TABLE	
POINT	ELEVATION	NORTHING	EASTING	DESCRIPTION
1	5437.91	1196446.66	3145248.29	Curb FL*
2	5438.15	1196446.69	3145229.70	Curb FL
3	5437.95	1196433.08	3145211.06	Curb FL
4	5437.85	1196421.44	3145207.36	Curb FL
5	5437.90	1196417.61	3145202.10	Curb FL
6	5438.00	1196417.64	3145189.33	Curb FL
7	5438.00	1196165.65	3145188.65	Curb FL
8	5437.08	1196165.48	3145253.90	Curb FL
9	5436.70	1196189.48	3145253.60	Curb FL
10	5436.89	1196189.53	3145236.71	Curb FL
11	5436.96	1196195.09	3145231.23	Curb FL
12	5436.99	1196197.82	3145231.23	Curb FL
13	5436.91	1196203.36	3145236.74	Curb FL
14	5436.80	1196203.32	3145248.75	Curb FL
15	5437.25	1196410.32	3145249.31	Curb FL
16	5437.42	1196410.34	3145236.85	Curb FL
17	5437.52	1196415.83	3145231.35	Curb FL
18	5437.54	1196416.94	3145231.35	Curb FL
19	5437.65	1196422.69	3145236.87	Curb FL
20	5437.30	1196422.64	3145251.74	Curb FL*
21	5437.41	1196468.27	3145259.31	Edge of Sidewalk*
22	5438.90	1196471.02	3145218.54	Edge of Sidewalk
23	5438.90	1196454.65	3145181.89	Edge of Sidewalk
24	5439.00	1196411.83	3145167.35	Edge of Sidewalk**
25	5438.75	1196165.12	3145174.70	Edge of Sidewalk
38	5435.90	1196298.59	3145249.01	Curb FL
39	5435.90	1196300.66	3145249.02	Curb FL
40	5423.26	1196412.05	3145160.97	Curb FL*
41	5423.26	1196419.73	3145161.08	Curb FL
42	5423.07	1196419.92	3145132.47	Curb FL*
43	5438.85	1196468.19	3145230.65	Edge of Sidewalk
44	5438.90	1196471.89	3145230.70	Edge of Sidewalk
45	5436.59	1196194.98	3145259.09	Curb FL
46	5436.20	1196221.24	3145259.17	Curb FL*
47	5436.96	1196160.15	3145259.38	Curb FL*


KISTING EXISTING ELEVATION AGAINST BRICK VENEER

THORNTON JUSTICE CENTER PHASE III

UPPER PARKING AREA **GRADING PLAN**


DWG. NO. D-02

SHEET NO. 23 of 46

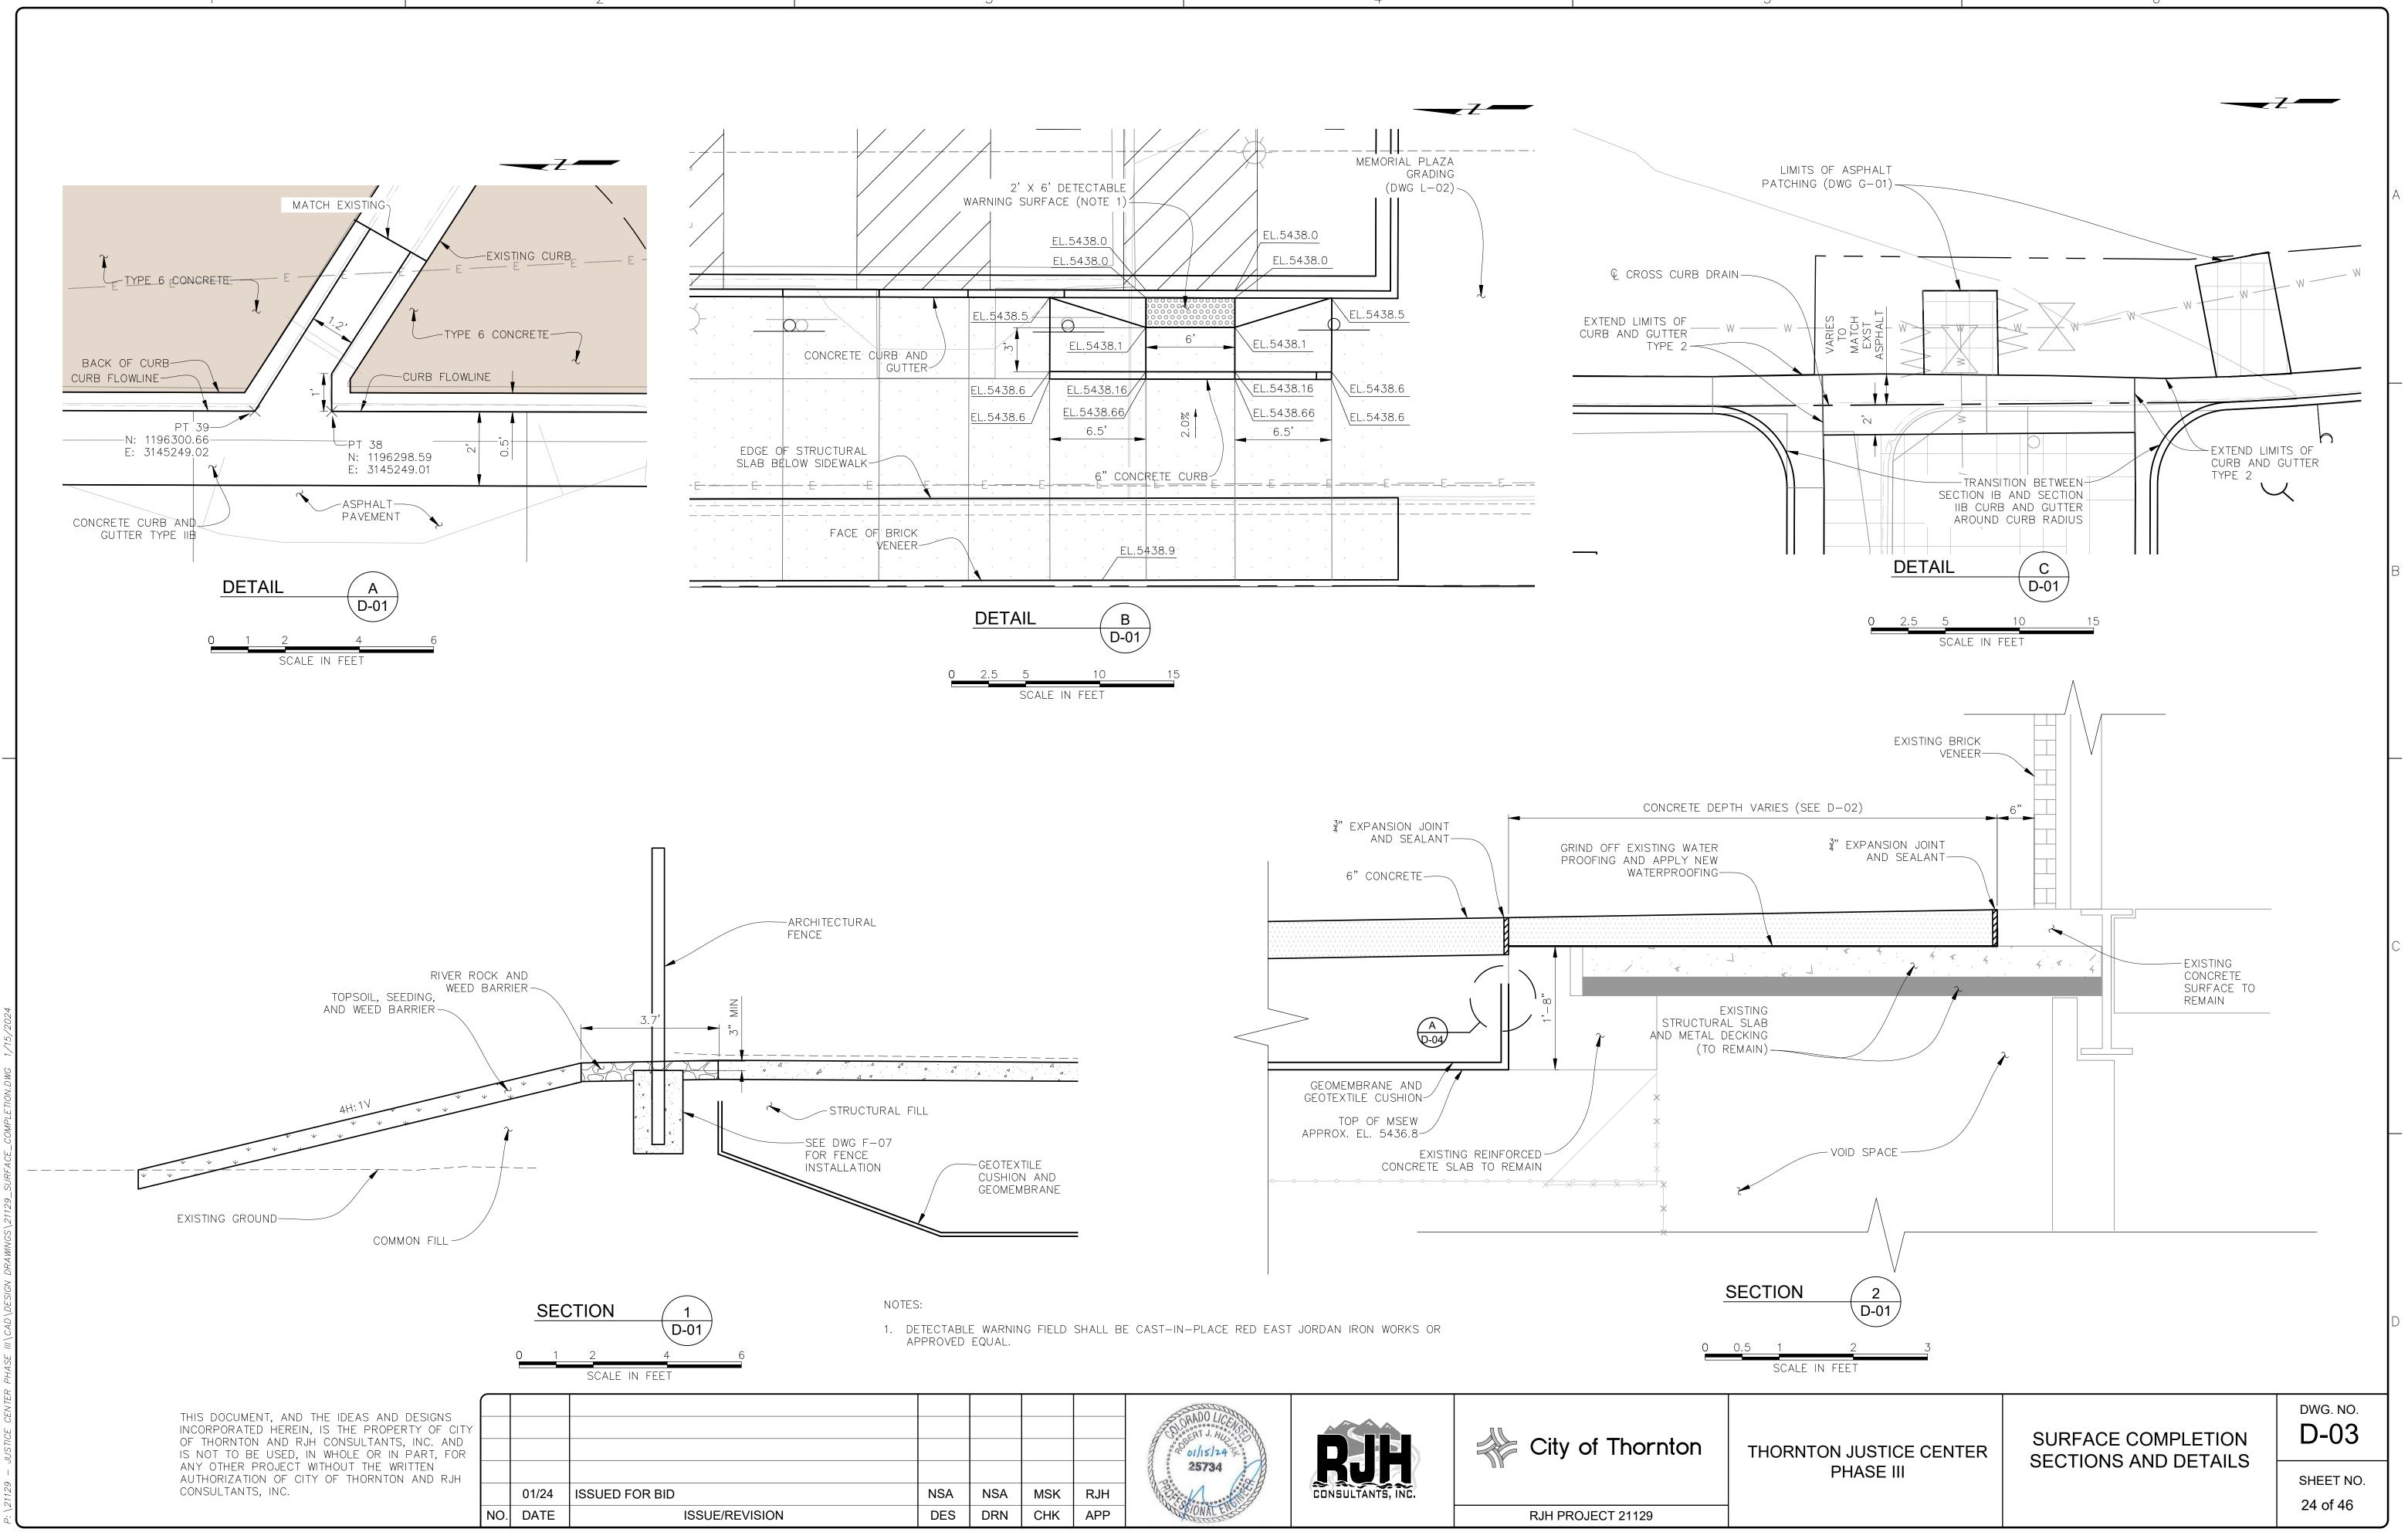





NSA DES	NSA	MSK CHK	RJH	SUDRADO LICENS SUBRTJ. AU 25734 25734	RUH consultants, inc.	City of Thornton	THOF

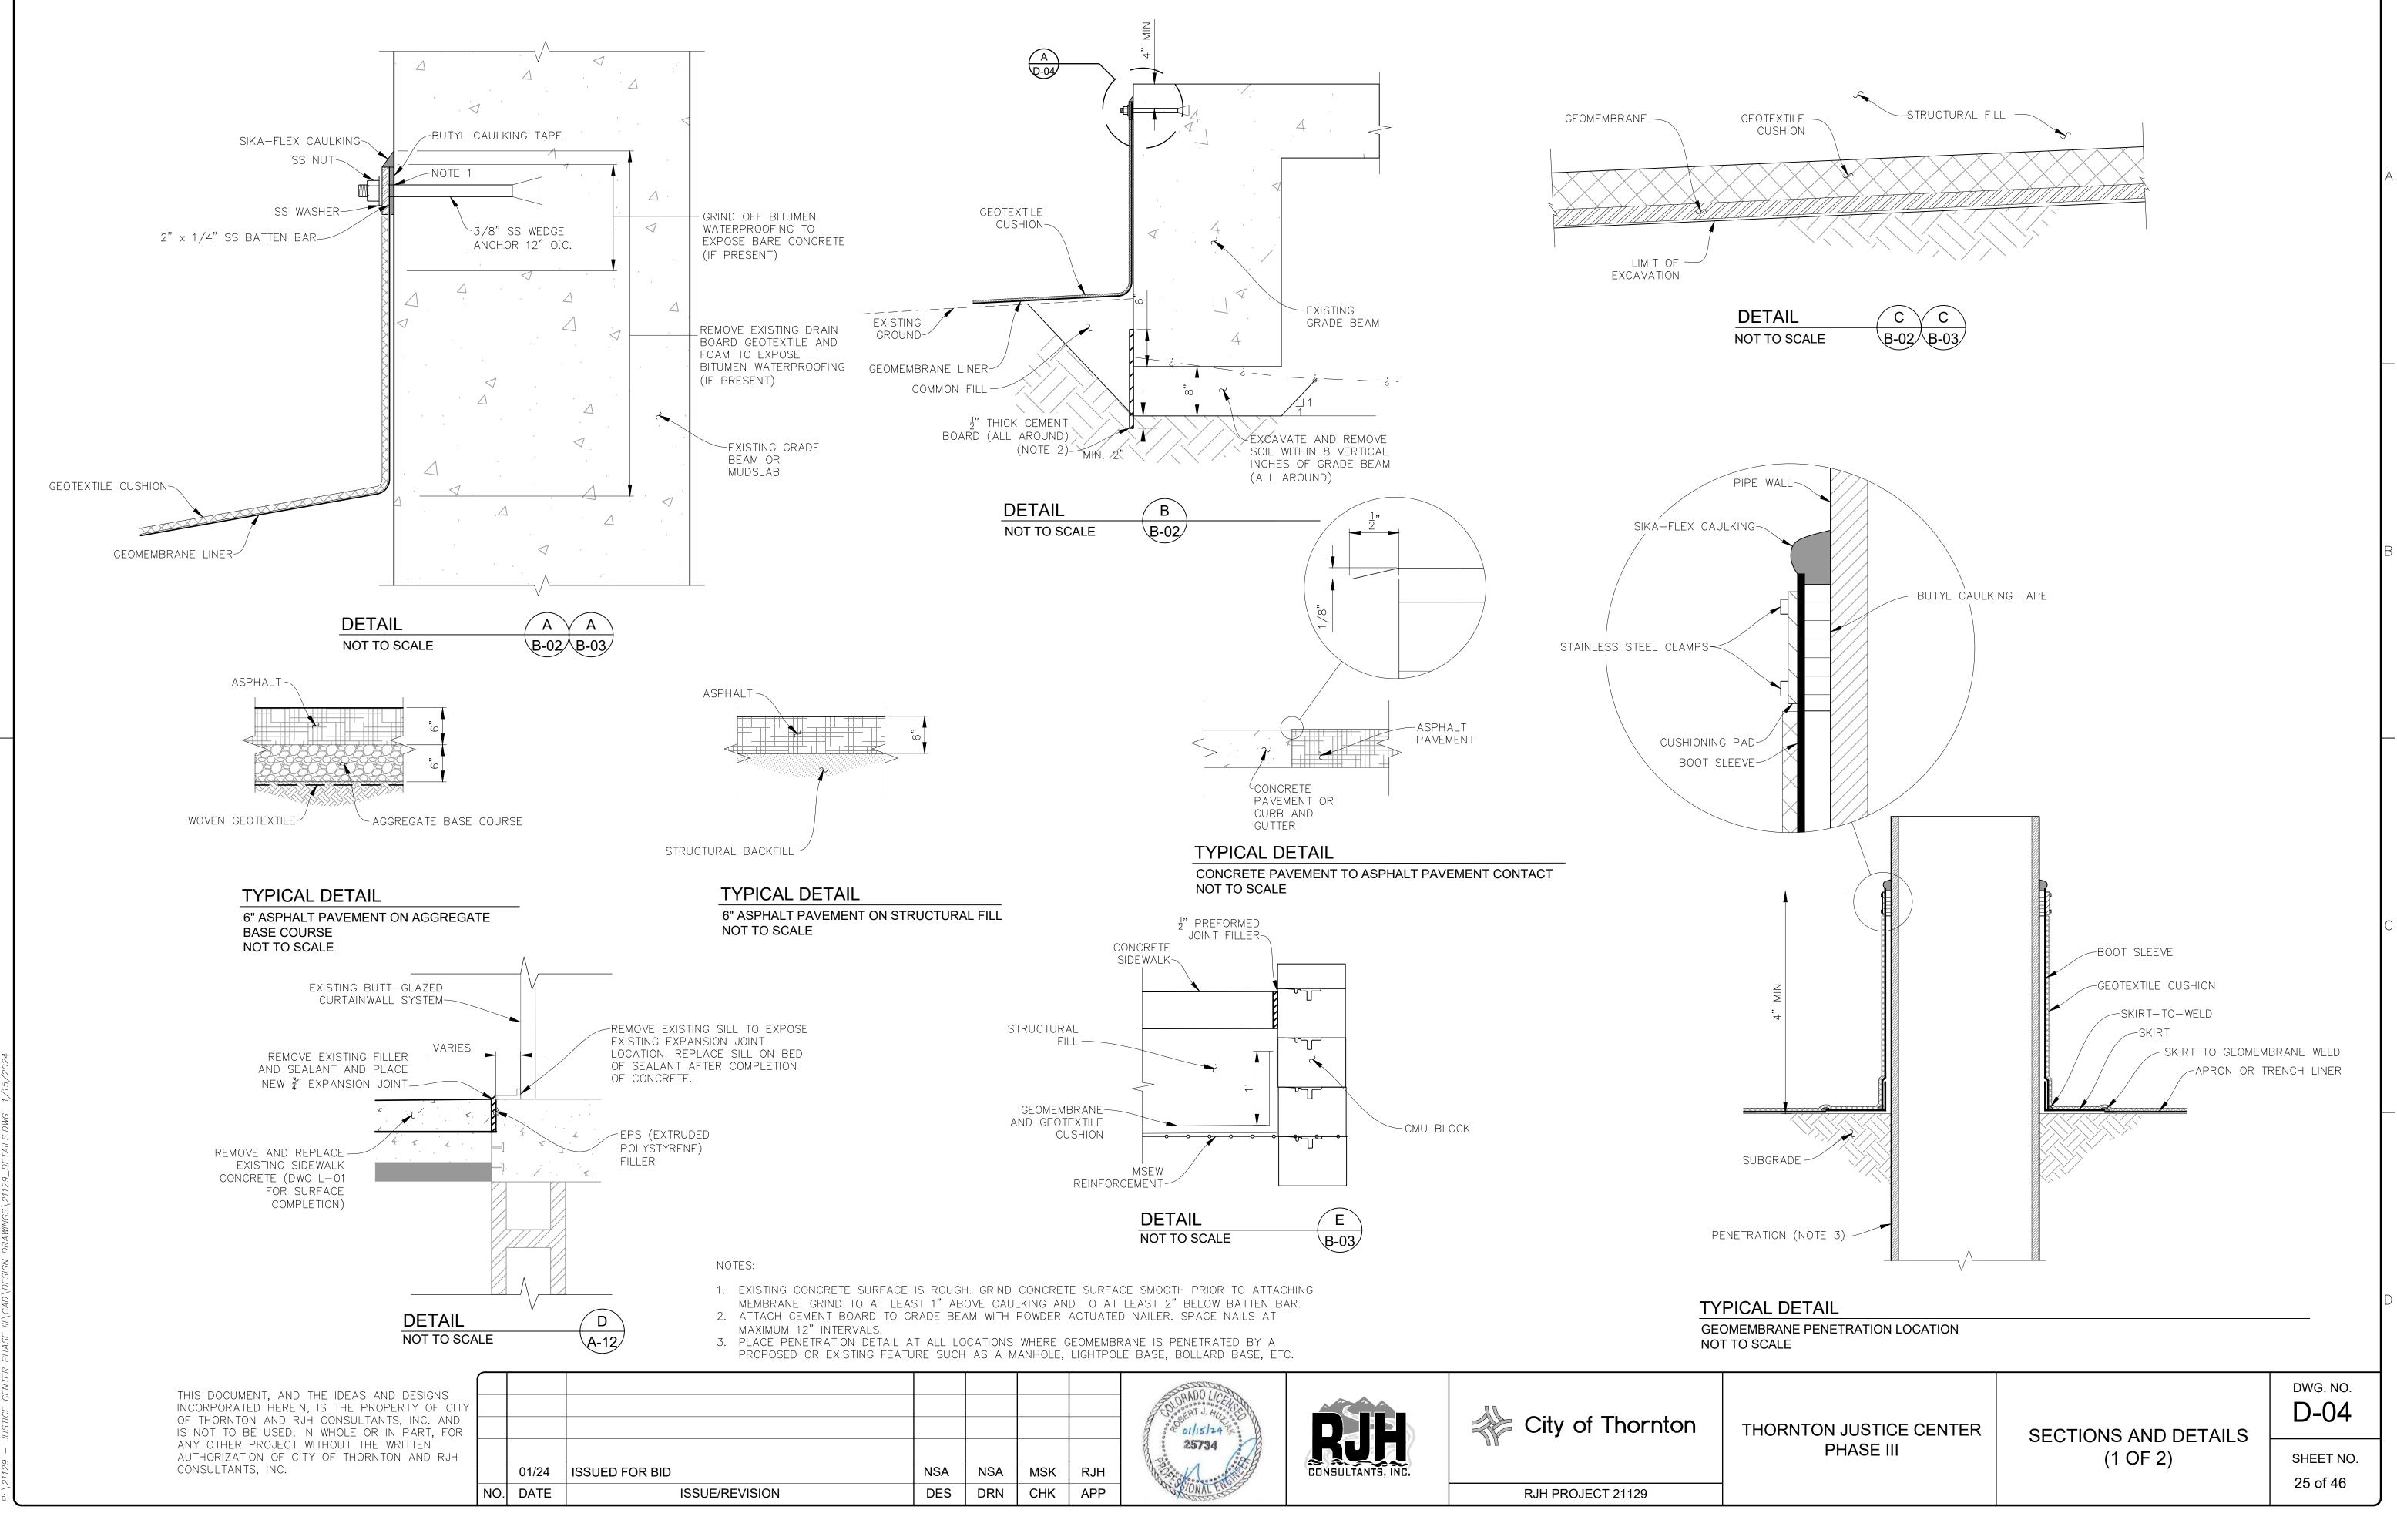



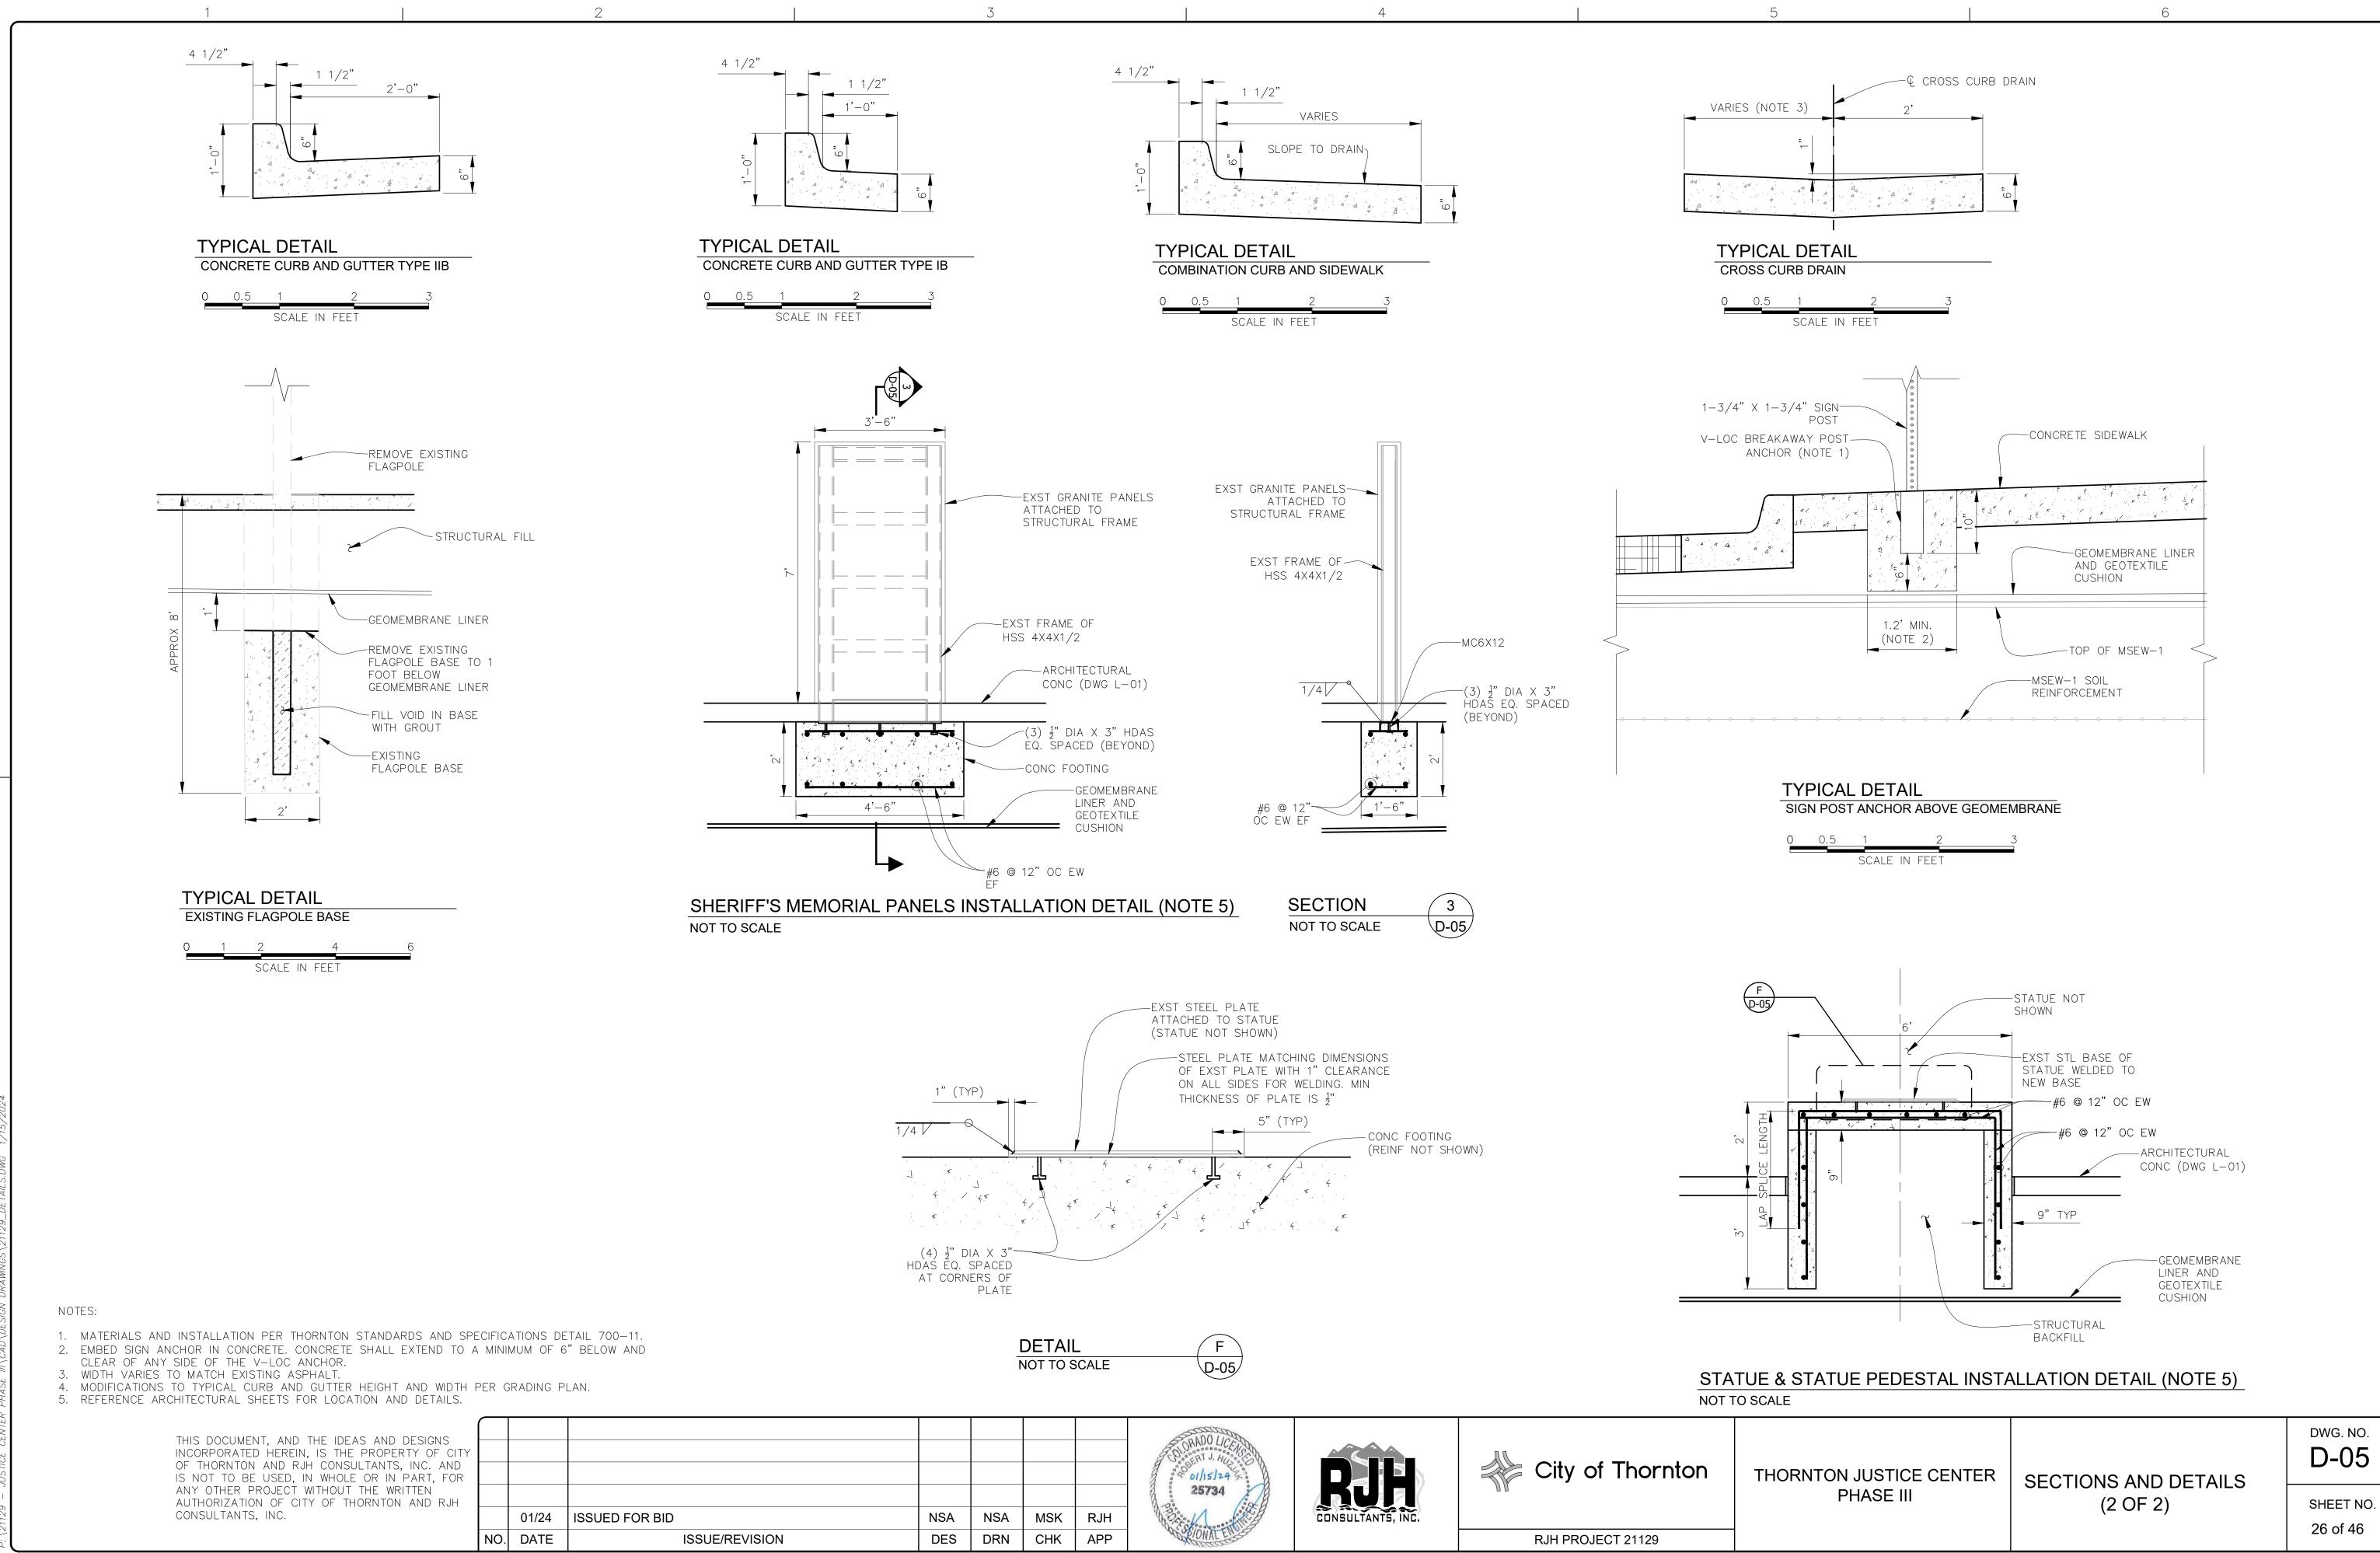

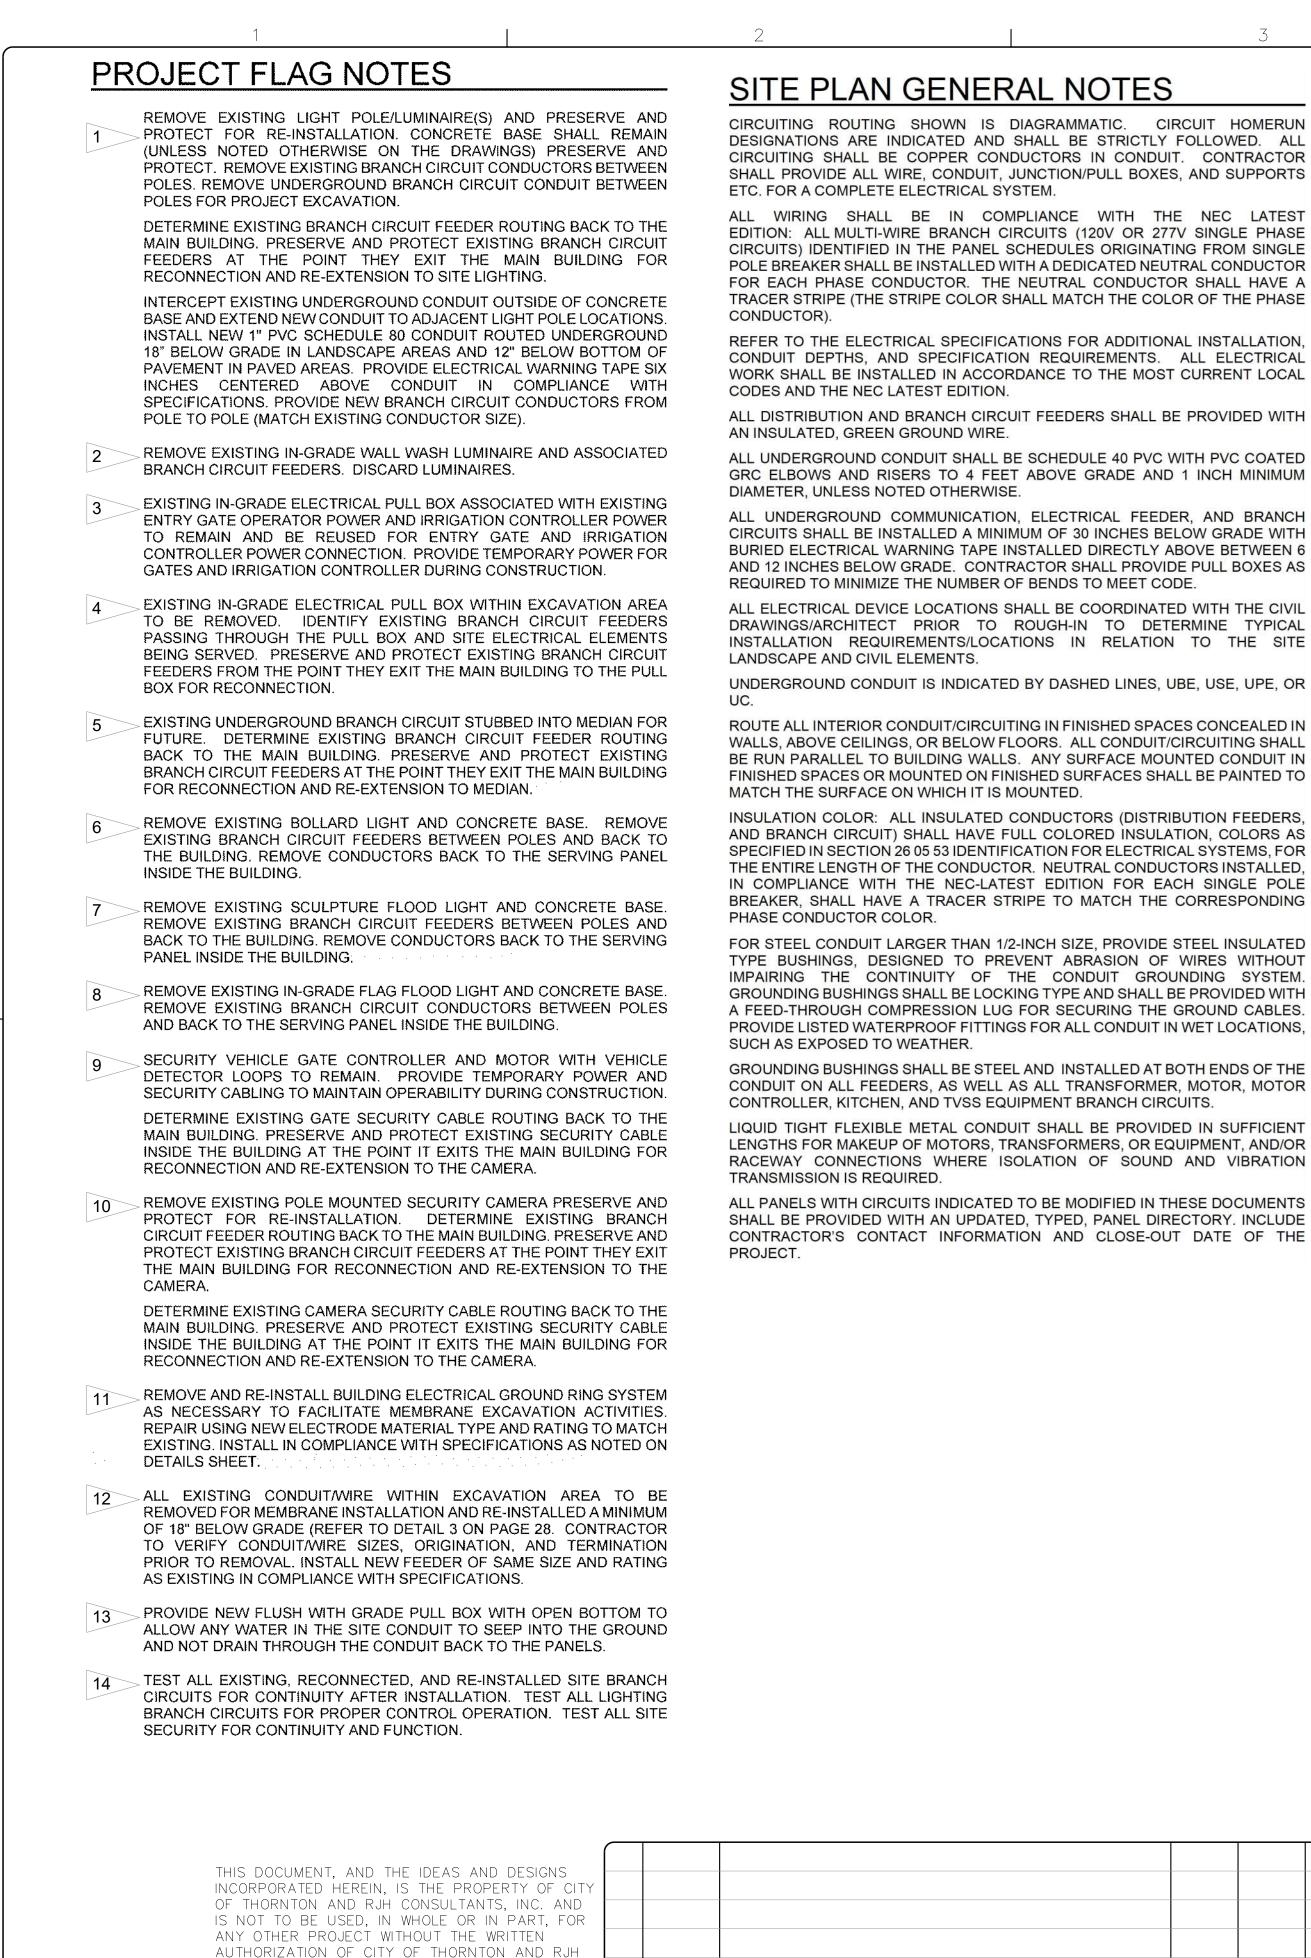

01/24

NO. DATE

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CONSULTANTS, INC.

DEMOLITION GENERAL NOTES

AS-BUILT CONDITIONS HAVE BEEN DETERMINED FROM RECORD DRAWINGS (IF THEY EXIST), FIELD INVESTIGATIONS (ACCESSIBLE AREAS AND EQUIPMENT), AND DISCUSSIONS WITH MAINTENANCE PERSONNEL (WHERE THEY ARE AVAILABLE). THE ENGINEER DOES NOT GUARANTEE THE ACCURACY OF THIS INFORMATION. THE CONTRACTOR IS RESPONSIBLE FOR INVESTIGATING AS-BUILT CONDITIONS PRIOR TO ANY DEMOLITION AND/OR MODIFICATIONS. SHOULD THERE BE ANY DISCREPANCIES BETWEEN THE EXISTING CONDITIONS AND THE DESIGN INTENT THE CONTRACTOR SHALL BE RESPONSIBLE FOR OBTAINING CLARIFICATION FROM THE ARCHITECT/ENGINEER.

COORDINATE ALL DEMOLITION WITH GENERAL DEMOLITION AS WELL AS MECHANICAL DEMOLITION. DISCONNECT ALL ELECTRICAL PRIOR TO DEMOLITION BY OTHER TRADES. REFER TO THE ARCHITECTURAL AND MECHANICAL PLANS FOR ADDITIONAL INFORMATION.

CONTRACTOR SHALL COORDINATE WITH THE OWNER OR THEIR AUTHORIZED REPRESENTATIVE, TO DETERMINE ALL EXISTING EQUIPMENT AND DEVICES TO BE RETAINED BY THE OWNER. CONTRACTOR SHALL CAREFULLY REMOVE ALL EQUIPMENT AND DEVICES TO BE RETAINED, PRESERVE AND STORE THE EQUIPMENT IN A LOCATION DESIGNATED BY THE OWNER. ALL OTHER DEVICES, EQUIPMENT, AND DEBRIS SHALL BE DISPOSED OF BY THE CONTRACTOR AT AN APPROPRIATE OFFSITE LOCATION.

CONTRACTOR SHALL BE RESPONSIBLE FOR REMOVAL. PRESERVATION. STORAGE, AND PROTECTION OF ALL EQUIPMENT AND DEVICES DESIGNATED TO BE REMOVED AND RE-INSTALLED.

ALL LUMINAIRES INDICATED TO BE REMOVED AND RE-INSTALLED SHALL BE CLEANED AND/OR REPAIRED PRIOR TO RE-INSTALLATION, INCLUDING RELAMPING TO REPLACE NON-WORKING LAMPS OR TO PROVIDE LAMPS WITH COLOR TEMPERATURE TO MATCH SPECIFICATIONS

ALL ABANDONED DEVICES, EQUIPMENT, CONDUIT, WIRE, CABLE, ETC. (WHETHER ABANDONED BY THIS PROJECT OR PREVIOUSLY ABANDONED) SHALL BE REMOVED.

POWER SYSTEMS: ALL FEEDERS AND BRANCH CIRCUITS CONDUIT AND CONDUCTORS SHALL BE REMOVED BACK TO THE SOURCE OR NEAREST REMAINING DEVICE AS APPLICABLE.

IT AND DATA SYSTEMS: ALL CONDUIT AND/OR CABLE ASSOCIATED WITH VOICE/DATA DEVICES SHALL BE REMOVED BACK TO THE SOURCE UNLESS DIRECTED OTHERWISE BY NOTE OR BY THE OWNER OR THEIR AUTHORIZED REPRESENTATIVE.

EXISTING ELECTRICAL EQUIPMENT, DEVICES, AND WIRING TO REMAIN WHERE INDICATED. RESTORE THE FUNCTION OF ANY REMAINING EQUIPMENT THAT IS AFFECTED BY MODIFICATIONS TO THE ELECTRICAL SYSTEM IN OTHER AREAS AS SOON AS POSSIBLE AND AT NO ADDITIONAL COST TO THE OWNER. ALL REPAIRS SHALL BE COORDINATED WITH THE ARCHITECT/ENGINEER. CONTRACTOR SHALL MAKE REASONABLE EFFORT TO LOCATE ALL AFFECTED DEVICES AND RESTORE FUNCTIONALITY.

EXISTING DEVICES INDICATED TO BE RECONNECTED TO NEW CIRCUITS AND/OR PANELS SHALL USE NEW CIRCUITS INDICATED. THE EXISTING BRANCH CIRCUIT SHALL BE INTERCEPTED NEAR THE FIRST REMAINING DEVICE AND NEW CONDUIT/WIRE INSTALLED FROM THAT POINT BACK TO THE NEW DESTINATION (I.E. PANEL).

ALL ELECTRICAL AND LIFE SAFETY SYSTEMS THAT EXTEND INTO OCCUPIED AREAS SHALL REMAIN OPERATIONAL. CONTRACTOR SHALL COORDINATE ALL OUTAGES A MINIMUM OF SEVEN DAYS PRIOR TO OUTAGE. CONTRACTOR SHALL BE RESPONSIBLE TO PROVIDE PERSONNEL FOR FIRE AND SECURITY WATCH DURING OUTAGES TO FIRE AND SECURITY SYSTEMS.

	ER, LIGHTING
&	TELECOM
0	J-BOX
(M) (M)	MOTOR CEILING RECEPTACLE
Ű	FLOOR RECEPTACLE
Φ	DUPLEX RECEPTACLE
₽	FOUR-PLEX RECEPTACLE
6=	BLANK FACE GFCI PROTEC
۲	SPECIAL NEMA RECEPTAC
Cr	HEAVY DUTY DISCONNEC
	SWITCH MOTOR STARTER
₩	HEAVY DUTY STARTER-
	DISCONNECT VFD MOTOR STARTER
—	VFD HEAVY DUTY STARTE
VFD	DISCONNECT
SPD	SURGE SUPPRESSION DEV
Sto	THERMAL OVERLOAD SW
_	BRANCH CIRCUIT PANEL
►	TELEPHONE OUTLET
	TELE-DATA OUTLET
	DATA OUTLET TELEPHONE OUTLET FLOO
	TELE-DATA OUTLET FLOO
₽	TV OUTLET
ť	EMERGENCY BATTERY LIC
⊗	WALL MOUNTED EXIT SIGN CEILING MOUNT EXIT SIGN
	CLG MNT EX/EM LT COMBO
Q	SURFACE WALL LUMINAIR
0	SURFACE CEILING LUMINA
® D	KEYLESS LAMP HOLDER RECESSED DOWNLIGHT
	RECESSED WALL WASHEF
	LUMINAIRE STRIP
	SURFACE OR WALL LUMIN
	RECESSED LUMINAIRE
	TRACK LIGHTING
ě	PARKING LOT POLE LIGHT PEDESTRIAN POLE LUMIN
چ ک	FLOOD LUMINAIRE
S	SWITCH
S ₃	3-WAY SWITCH OCCUPANCY SENSOR SW
05	OCC. SENSOR DIMMER SV
	LOW VOLTAGE SWITCH
D	DIMMER SWITCH
回 國 @	PHOTOCELL OCCUPANCY SENSOR
e e P	OCC. SEN. POWER PACK
RC	ROOM CONTROLLER
D	TIME CLOCK
	CLOCK-WALL MOUNT CLOCK/SPEAKER
ଅ	IN COMBINATION BACK-BC
-S	SPEAKER-WALL MOUNT
-©⊲ [3]	SPEAKER HORN-WALL MO SPEAKER-RECESSED CEIL
	(HARD CEILING)
S	SPEAKER-RECESSED CEIL (LAYIN GRID CEILING)
S	SPEAKER-SURFACE OR
С	PENDANT MOUNT CEILING CALL STATION
	PUSH BUTTON STATION

AEI	AEI	DJA	DJA	ackerman engineering, inc.	CONSULTANTS, INC.	City of Thornton	тнс
DES	DRN	CHK	APP			RJH PROJECT 21129	

, ⊾	▲GENERAL ▲
	SECTION BUBBLE * SECTION LETTER # REFERENCE DWG NUMBER
	REFERENCE BUBBLE * SECTION NUMBER
	# REFERENCE NUMBER
	# EQUIPMENT TAG
E	DRAWING NOTE
	# FLAG NOTE
	~ BREAKLINE
	MATCHLINE
₹-	-OPE - OVERHEAD PRIMARY ELECTRIC
	-OSE - OVERHEAD SECONDARY ELECTRIC
ICE	-UPE UNDERGROUND PRIMARY ELECTRIC
	-USE UNDERGROUND SECONDARY ELECTRIC
	-UBE UNDERGROUND BRANCH ELECTRIC
	-OBE - OVERHEAD BRANCH ELECTRIC
	— uc — UNDERGROUND COMMUNICATION
R	BOLD LINEWEIGHT AND/OR "N" INDICATES NEW DEVICE OR EQUIPMENT
HT	BOLD LINEWEIGHT AND/OR "R" INDICATES DEVICE OR EQUIPMENT TO BE REPLACED
	LIGHT LINEWEIGHT AND/OR "E" INDICATES EXISTING DEVICE TO REMAIN
RE	DASHED LINETYPE AND/OR "D" INDICATES DEVICE TO BE REMOVED / DEMOLISHED
AIRE	LECTRONIC SAFETY
	& SECURITY
IRE	■ MAGNETIC DOOR HOLD ② SMOKE DETECTOR
	O _T THERMAL DETECTOR
	DUCT SMOKE DETECTOR MANUAL PULL STATION
гсн	S B COMBO SPEAKER/STROBE
ТСН	X CEILING ALARM STROBE LIGHT X WALL ALARM STROBE LIGHT
	S B ALARM SPEAKER OR HORN
	REMOTE INDICATOR LIGHT
	FS FLOW SWITCH
	MONITOR MODULE
<	BR BEAM DETECTION RECEIVER
	Image: Construction of the sector
NG	
NG	
	GLASS BREAK DETECTOR
	DOOR POSITION SWITCH
	KP SECURITY CONTROL KEYPAD
	Contraction of the second seco
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DEFINITONS

INDICATES ABOVE COUNTER, AC COORDINATE EXACT HEIGHT INDICATES BELOW COUNTER. BC COORDINATE EXACT HEIGHT ABOVE FINISHED FLOOR ABOVE FINISHED GRADE AFG INDICATES GROUND FAULT GFL CIRCUIT INTERRUPT DEVICE INDICATES EXISTING DEVICE TO D BE REMOVED INDICATES EXISTING DEVICE TO REMAIN AS IS INDICATES EXISTING DEVICE TO BE REPLACED INDICATES EXISTING DEVICE TO RL BE RELOCATED TO POSITION SHOWN SPD INDICATES SURGE SUPRESSION DEVICE USB INDICATES UNIVERSAL SERIAL BUS DEVICE VFD INDICATES VARIABLE FREQUENCY MOTOR DRIVE INDICATES WEATHERPROOF WP EQUIPMENT/DEVICE EMT ELECTRICAL METALLIC CONDUIT FMC FLEXIBLE METALLIC CONDUIT LIQUIDTIGHT FLEXIBLE CONDUIT LFC PVC POLYVINYL CHLORIDE CONDUIT RIGID NONMETALLIC CONDUIT RNC RSC RIGID STEEL CONDUIT CT CURRENT TRANSFORMER HVAC HEATING, VENTILATION AIR CONDITIONING LED LIGHT EMITTING DIODE AIC AMPS INTERRUPTING CAPACITY Isc SHORT CIRCUIT CURRENT FLA FULL LOAD AMPS MCA MINIMUM CIRCUIT AMPS MCCB MOLDED-CASE CIRCUIT BREAKER MCP MOTOR CIRCUIT PROTECTOR MOCP MAXIMUM OVERCURRENT PROTECTION OCPD OVERCURRENT PROTECTIVE DEVICE N.C. NORMALLY CLOSED N.O. NORMALLY OPEN NEC NATIONAL ELECTRICAL CODE NFPA 70 NEMA NATIONAL ELECTRICAL MANUFACTURERS ASSOCIATION NFPA NATIONAL FIRE PROTECTION ASSOCIATION UL UNDERWRITERS LABORATORY ACS ACCESS CONTROL SYSTEM SDS SECURITY DETECTION SYSTEM VSS VIDEO SURVEILLANCE SYSTEM FIRE ALARM ANNUNCIATOR ANN PANEL DACT DIGITAL ALARM COMMUNICATOR TRANSMITTER EOL END-OF-LINE FACP FIRE ALARM CONTROL PANEL NAC NOTIFICATION APPLIANCE CIRCUIT SLC SIGNALING LOOP CIRCUIT A/V AUDIO/VISUAL MDF MAIN DISTRIBUTION FRAME INTERMEDIATE DISTRIBUTION IDF FRAME LAN LOCAL AREA NETWORK WAN WIDE AREA NETWORK TBB TELECOMMUNICATIONS BONDING BACKBONE TGB TELECOMMUNICATIONS GROUND BUS BAR UNINTERRUPTIBLE POWER UPS SUPPLY





ELECTRICAL LEGEND AND DRAWING NOTES

SHEET NO. 27 of 46

DWG. NO.

E-01

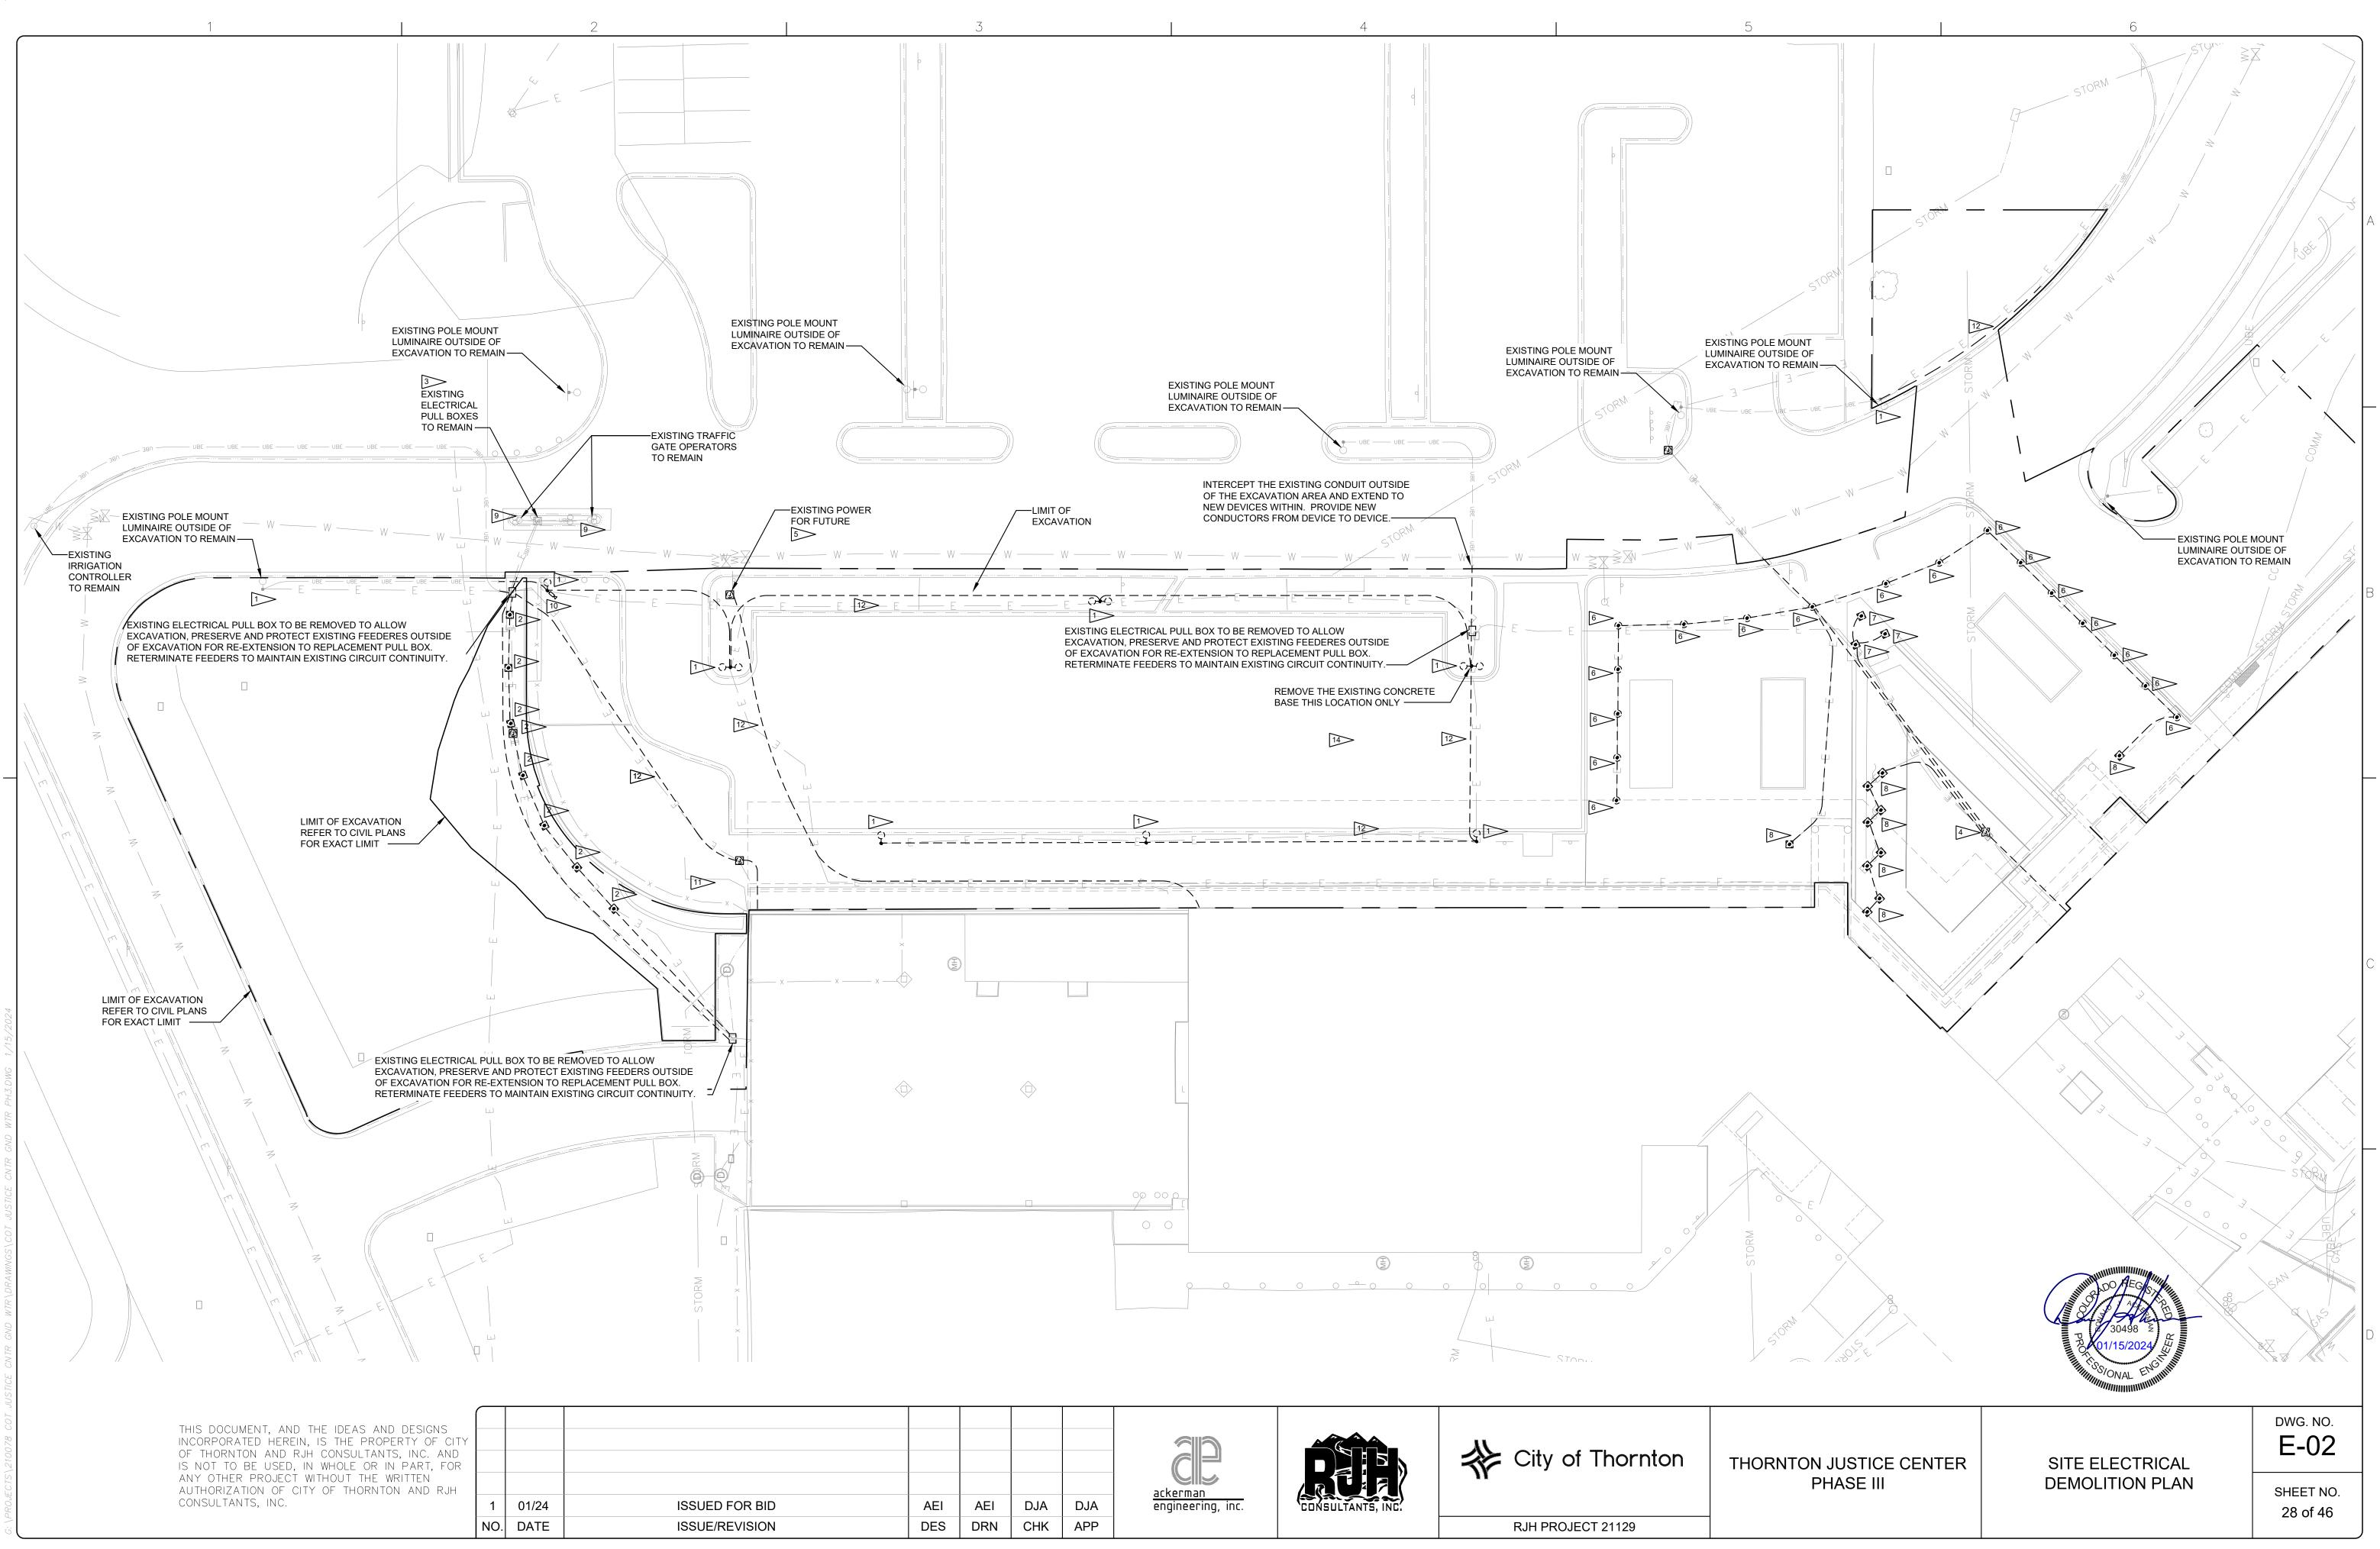

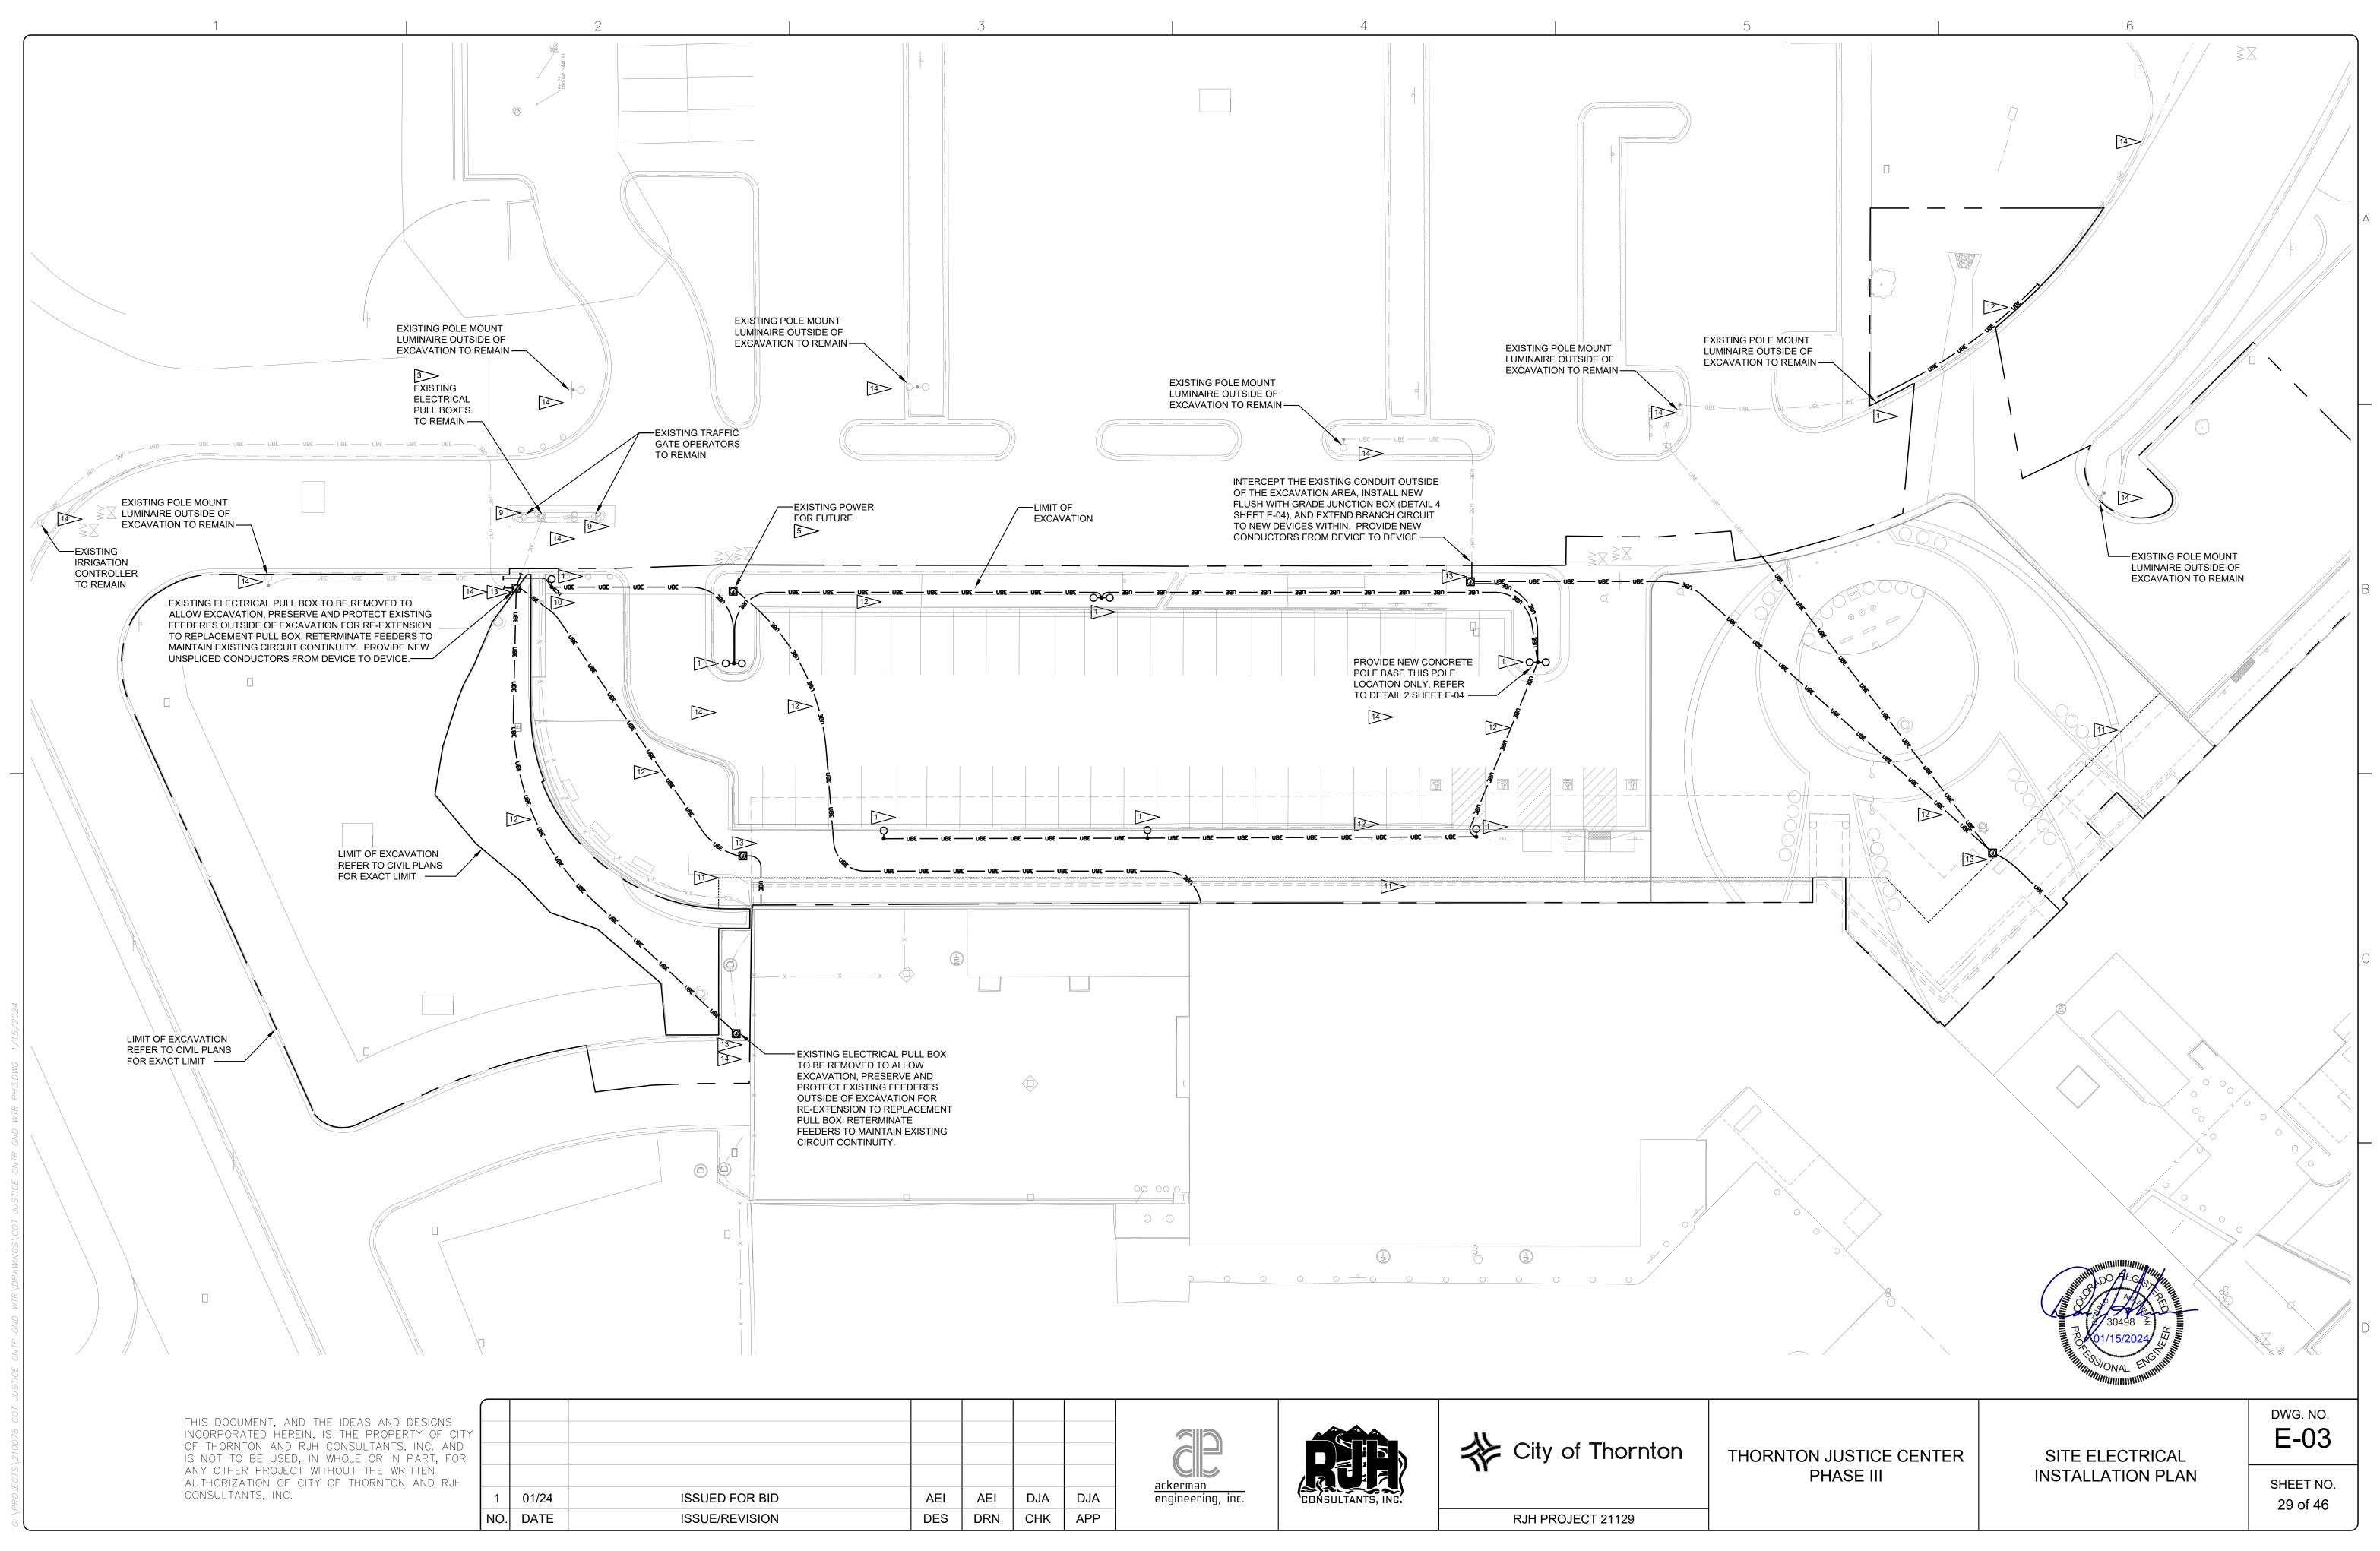


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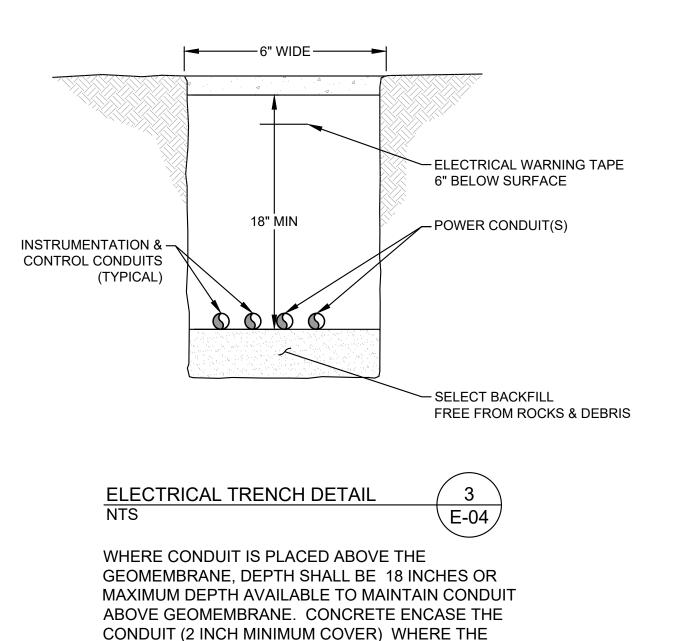
4D-2EE6E4A2BE1D 1		2	
	·		
			
			ANCHOR BOLTS PATTERN PER POLE MANUFACTURER
			(1#6) 3/4"C
			(1#6) 3/4"C BONDED TO POLE BASE REBAR
			RE-BAR SHALL HAVE MINIMUM 3" CONCRETE COVER
			4" GRAVEL
			FLUSH POLE BA
			NTS

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\int		
1	01/24	ISSUED FOR BID
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CONDUIT IS LESS THAN 18 INCHES DEEP AND

INSTALLED IN LANDSCAPE AREAS.

AEI	AEI	DJA	DJA
DES	DRN	CHK	APP



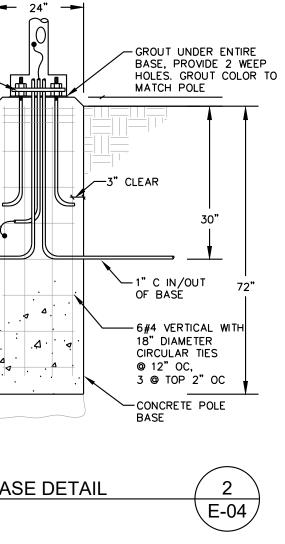



HEAVY TRAFFIC COVER WITH STAINLESS STEEL BOLTS AND NON-SKID SURFACE FINISH CONDUIT IN AND OUT NON-CONTINUOUSLY CONDUIT IN AND OUT NON-CONTINUOUSLY OVER EXCAVATE MINIMUM OF 18" BELOW BOX AND BACKFILL WITH GRAVEL DRAINAGE MATERIAL FLUSH WITH GRADE PULL BOX 4 NTS ∖E-04 ∕ TYPICAL POWER AND COMMUNICATION FEEDER PULLBOX (24"x36"x42"DEEP) QUAZITE PG STYLE SERVICE BOX WITH HEAVY DUTY BOLT ON COVER AS MANUFACTURED BY STRONGWELL




THORNTON JUSTICE CENTER PHASE III

ELECTRICAL DETAILS & DIAGRAMS


E-04

DWG. NO.


SHEET NO. 30 of 46

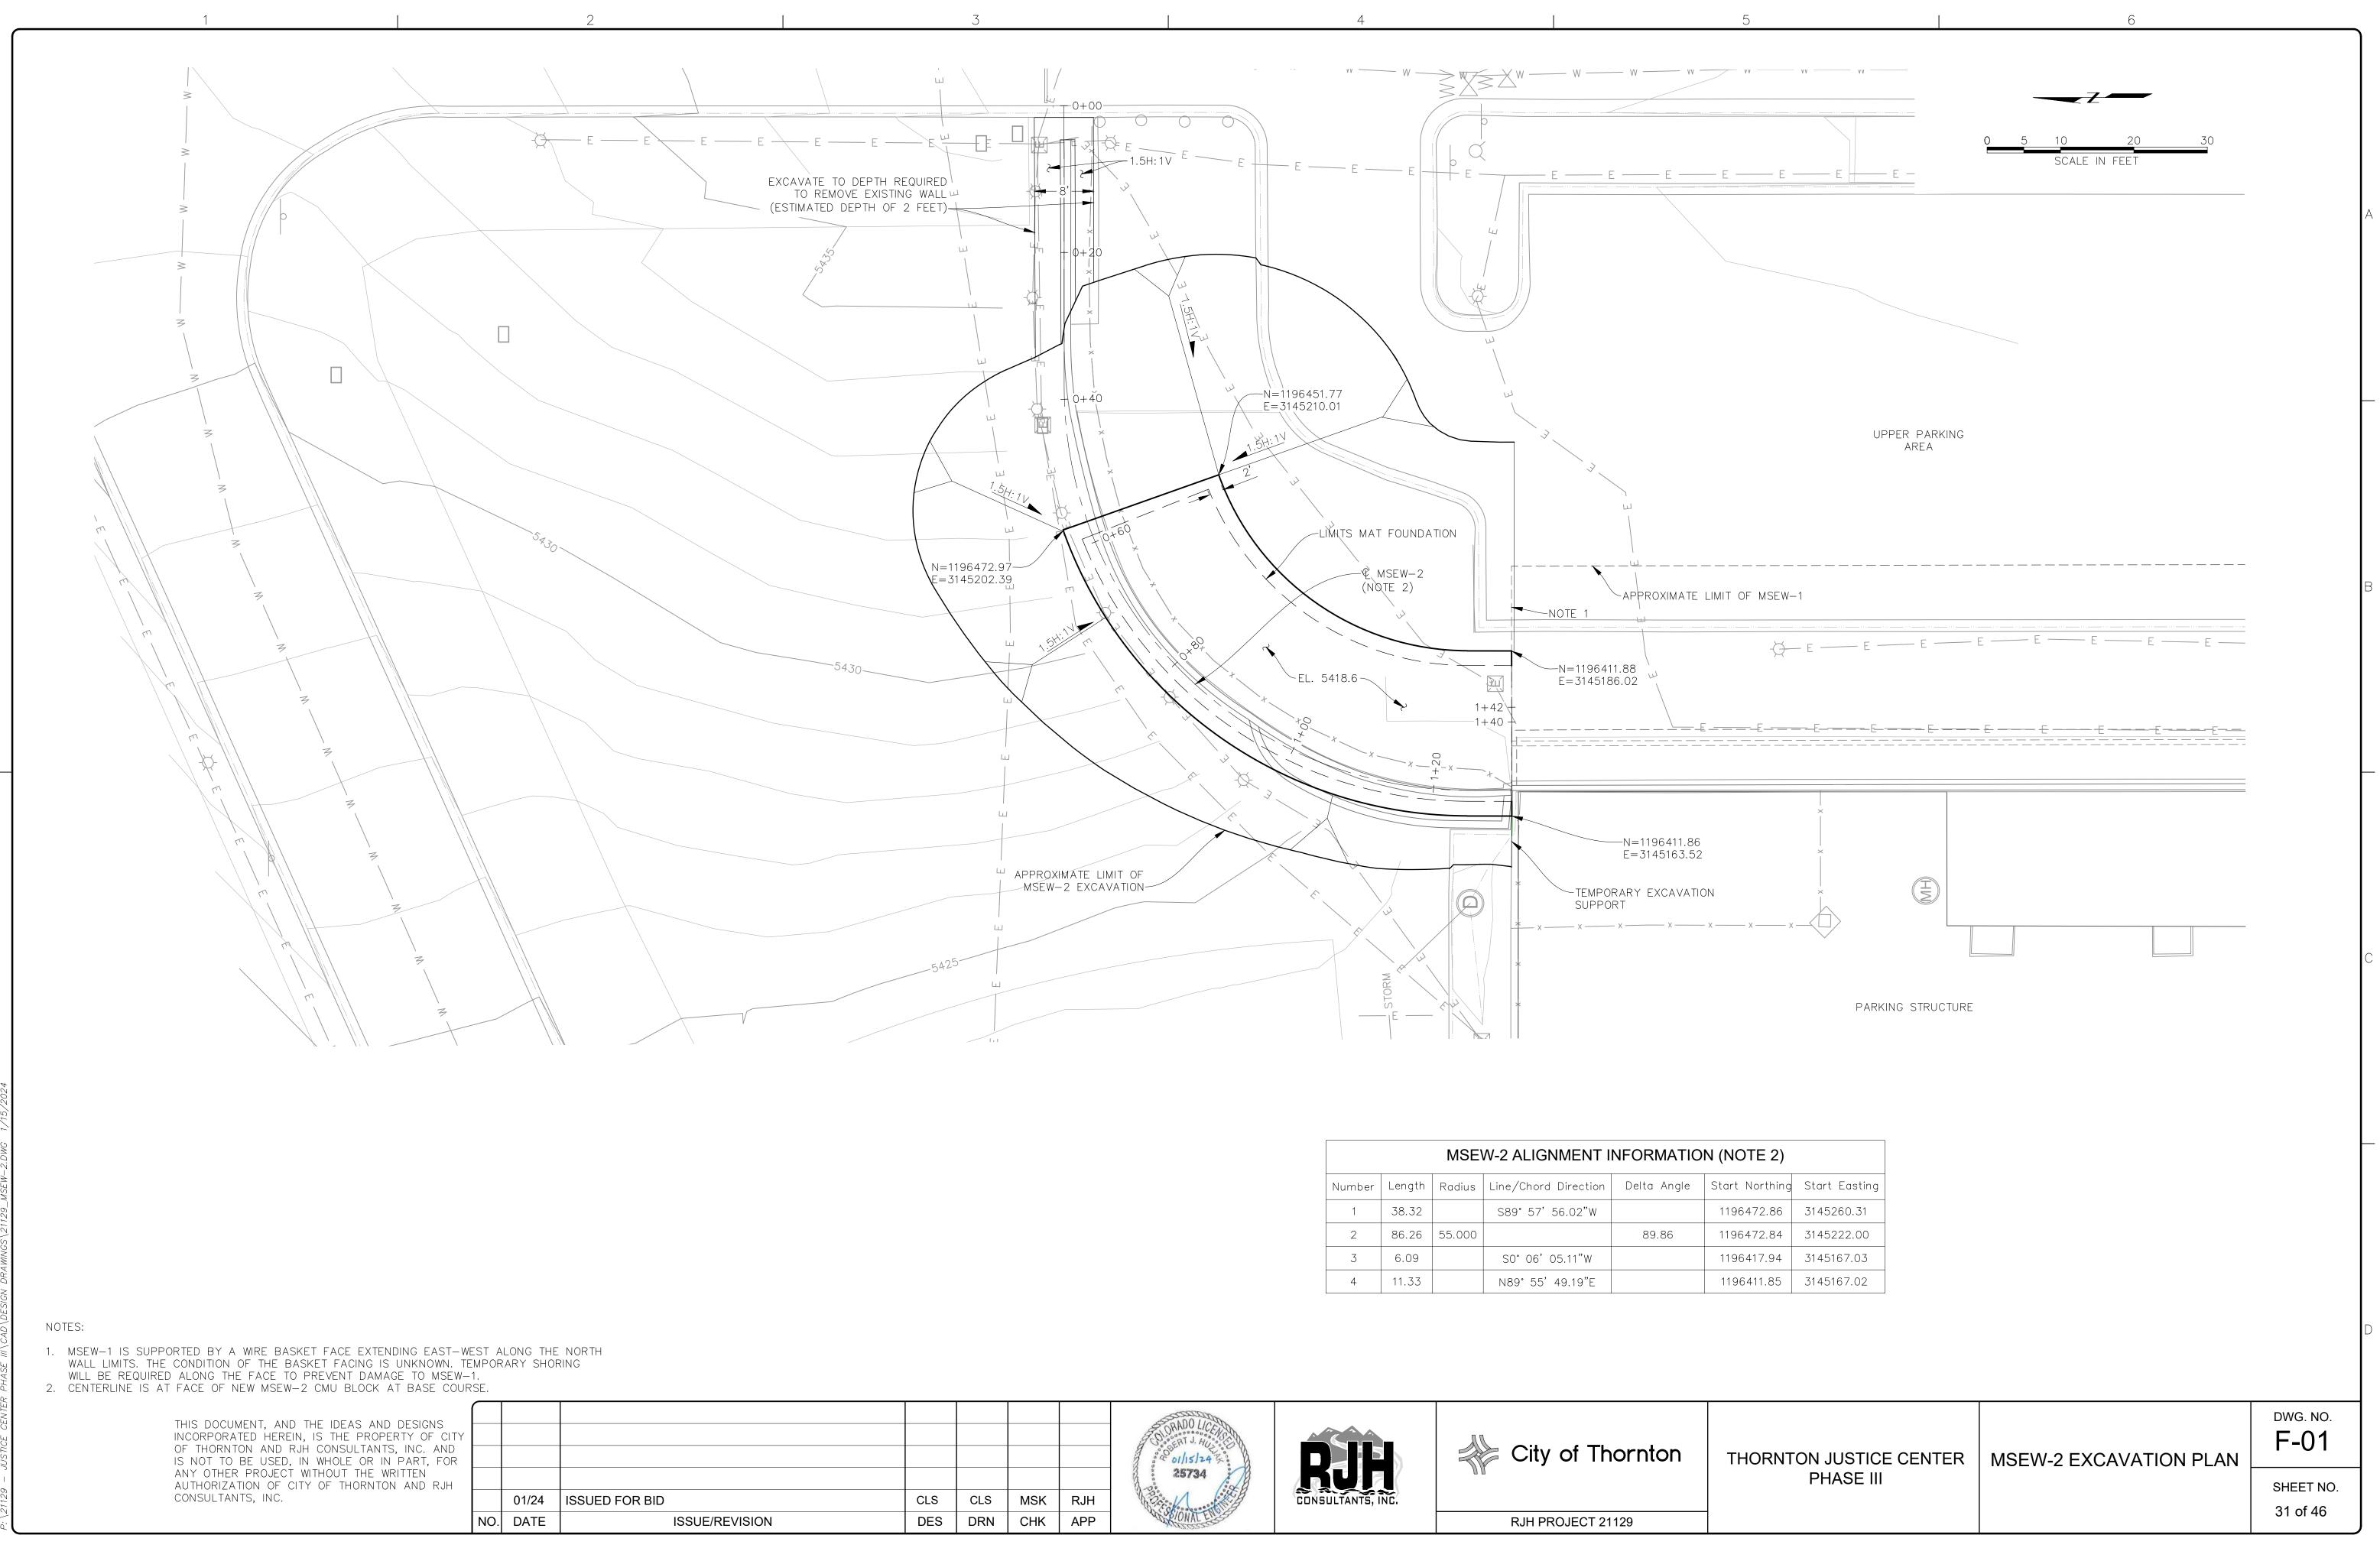

MSEW-2 ALIGNMENT INFORMATION (NOTE									
Number	Length	Radius	Line/Chord Direction	Delta Angle	Start No				
1	38.32		S89° 57' 56.02"W		119647:				
2	86.26	55.000		89.86	1196472				
3	6.09		S0°06'05.11"W		1196417				
4	11.33		N89°55'49.19"E		119641				

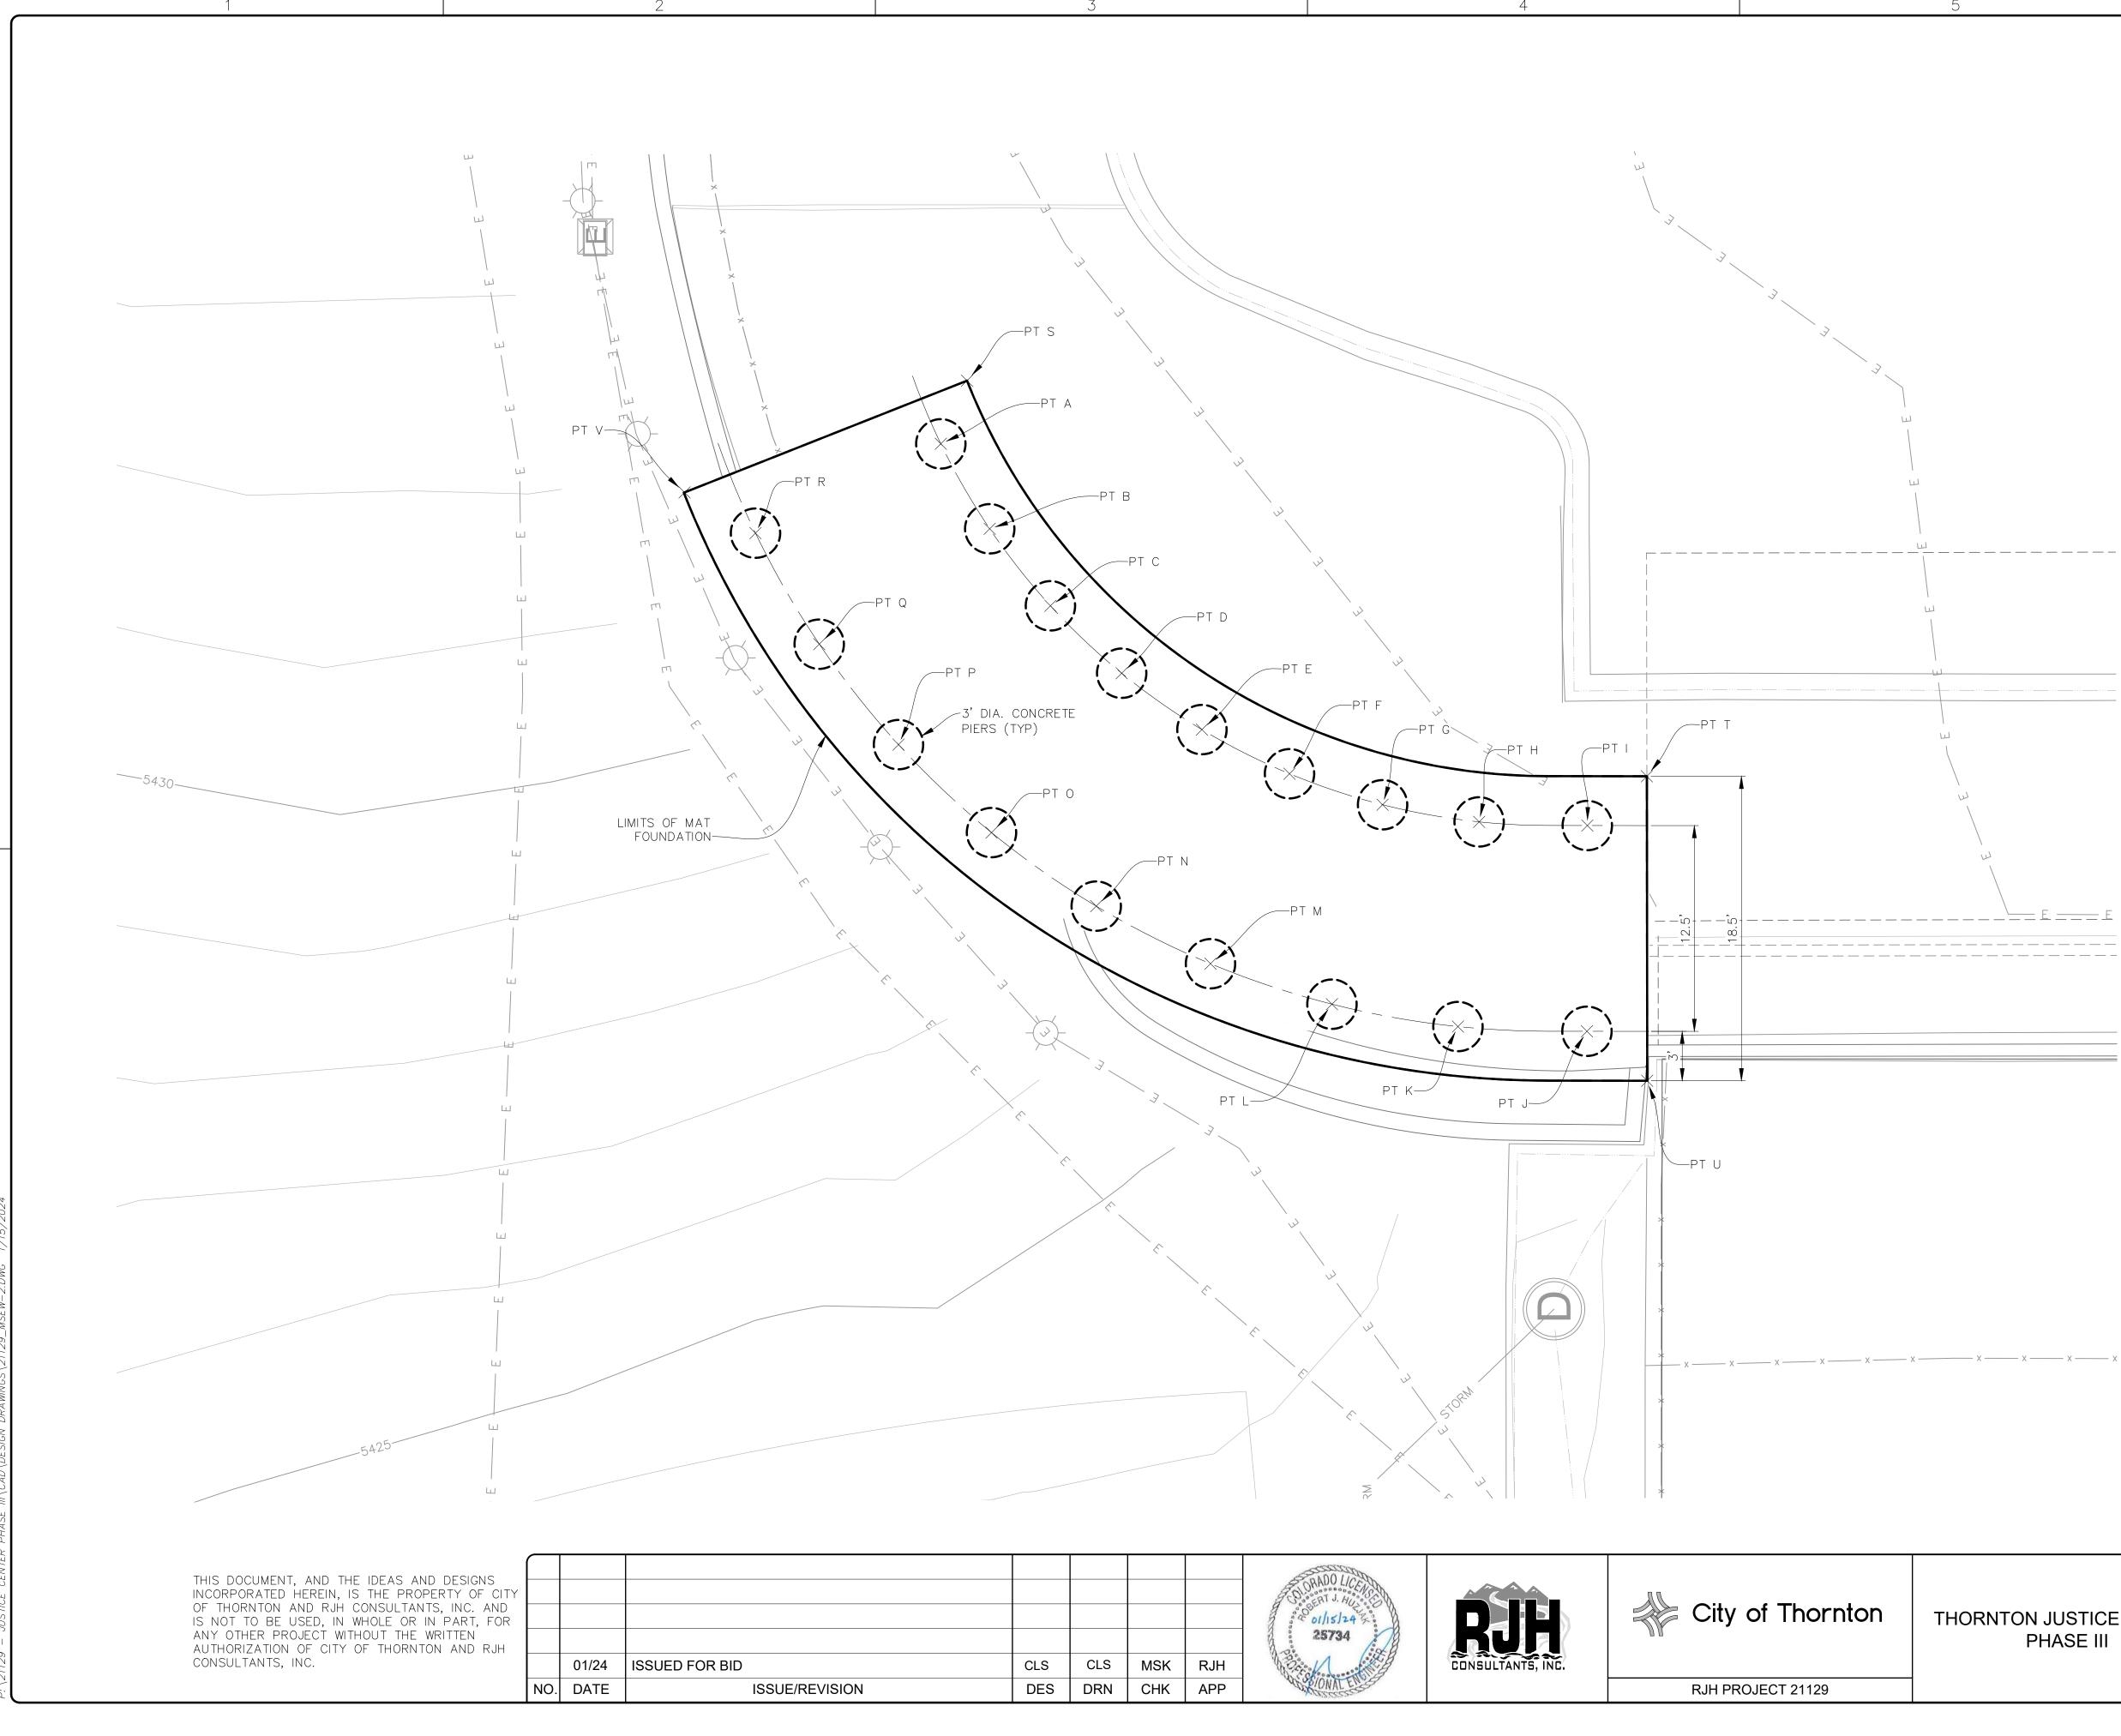



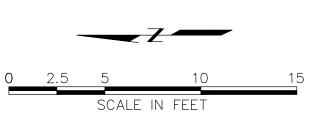

MSEW-2 POINT TABLE					
DESCRIPTION	NORTHING	EASTING			
PT A	1196454.77	3145204.22			
PT B	1196451.80	3145199.05			
PT C	1196448.11	3145194.37			
PT D	1196443.78	3145190.28			
PT E	1196438.90	3145186.85			
PT F	1196433.58	3145184.17			
PT G	1196427.93	3145182.29			
PT H	1196422.06	3145181.25			
PT I	1196415.49	3145181.03			
PT J	1196415.51	3145168.53			
PT K	1196423.35	3145168.81			
PT L	1196431.01	3145170.18			
PT M	1196438.38	3145172.63			
PT N	1196445.33	3145176.13			
PT O	1196451.69	3145180.60			
PT P	1196457.34	3145185.94			
PT Q	1196462.15	3145192.05			
PT R	1196466.03	3145198.79			
PT S	1196453.18	3145208.05			
PT T	1196411.87	3145184.02			
PT U	1196411.85	3145165.52			
PT V	1196470.33	3145201.27			


PHASE III

THORNTON JUSTICE CENTER | MSEW-2 FOUNDATION PLAN


SHEET NO. 32 of 46

DWG. NO.


F-02

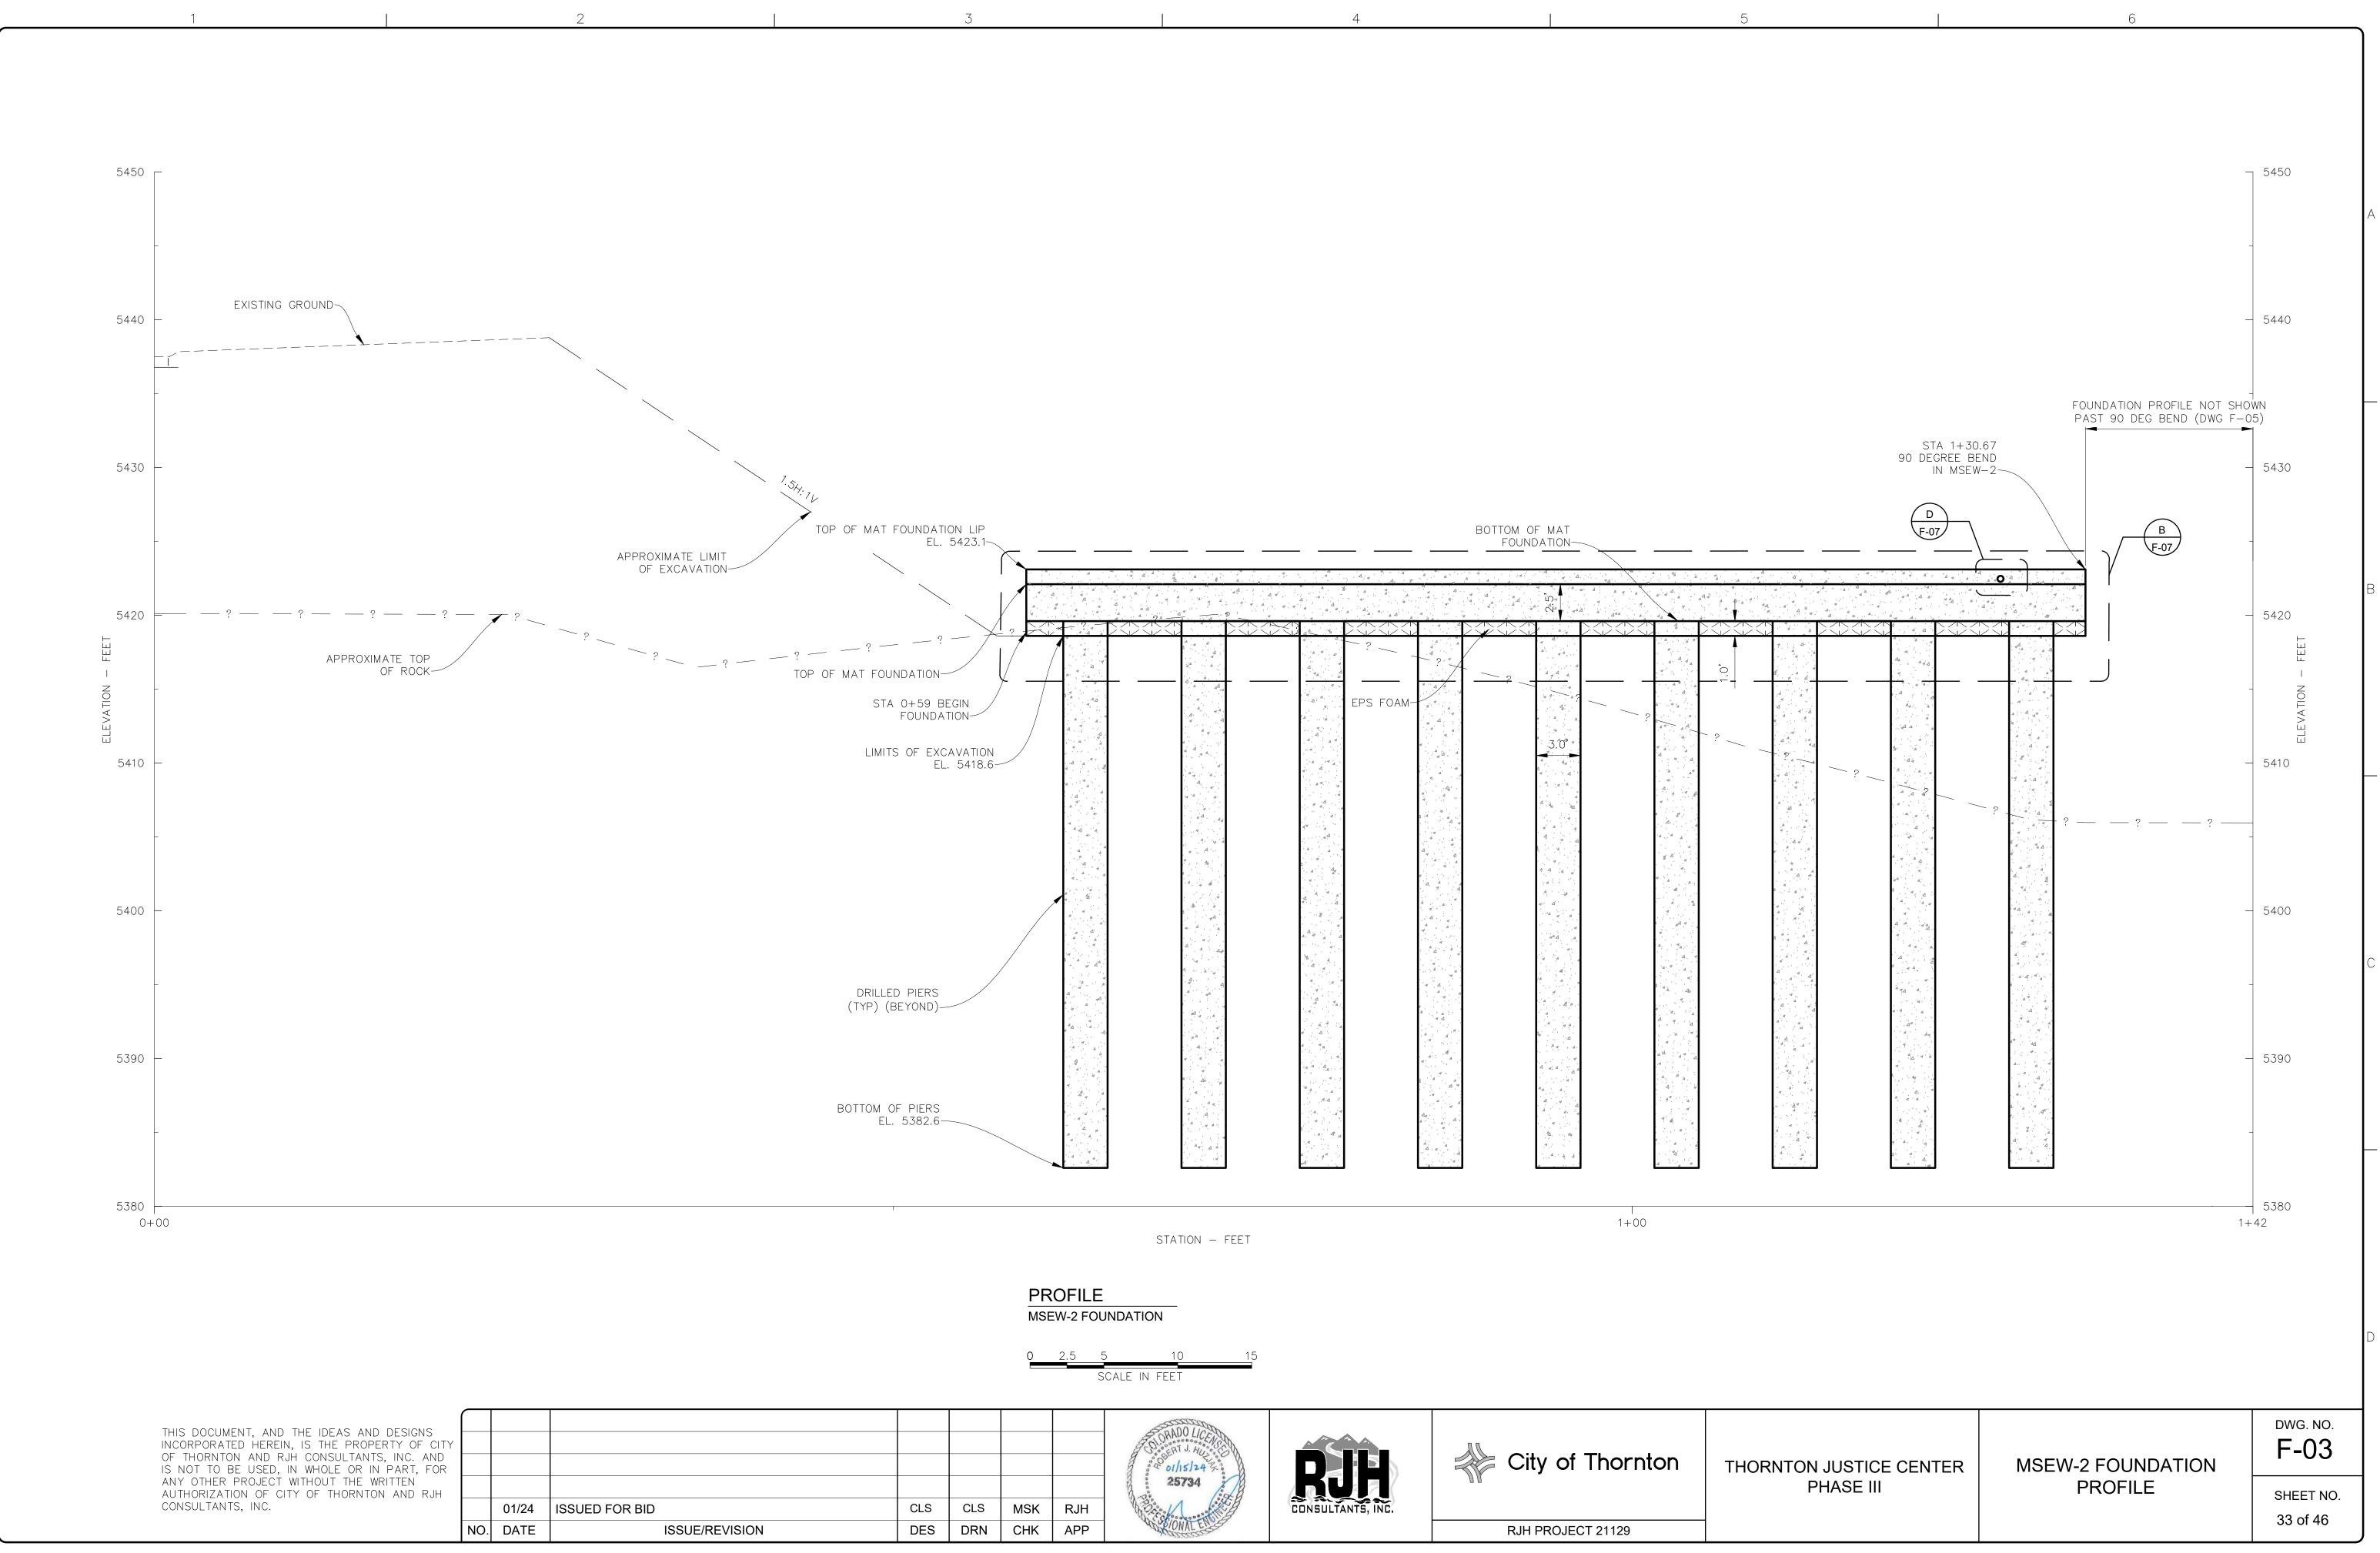


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 CLS	CLS	MSK	RJH	ORADO LICENS ORADO LICENS OI/ISJ24 25734	RUH CONSULTANTS, INC.	City of Thornton	THO
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XIMATE LIMIT OF MSEW-1			В
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ORNTON JUSTICE CENTER PHASE III	MSEW-2 WALL RECONSTRUCTION PLAN	DWG. NO. F-04 SHEET NO. 34 of 46	
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PHASE III	

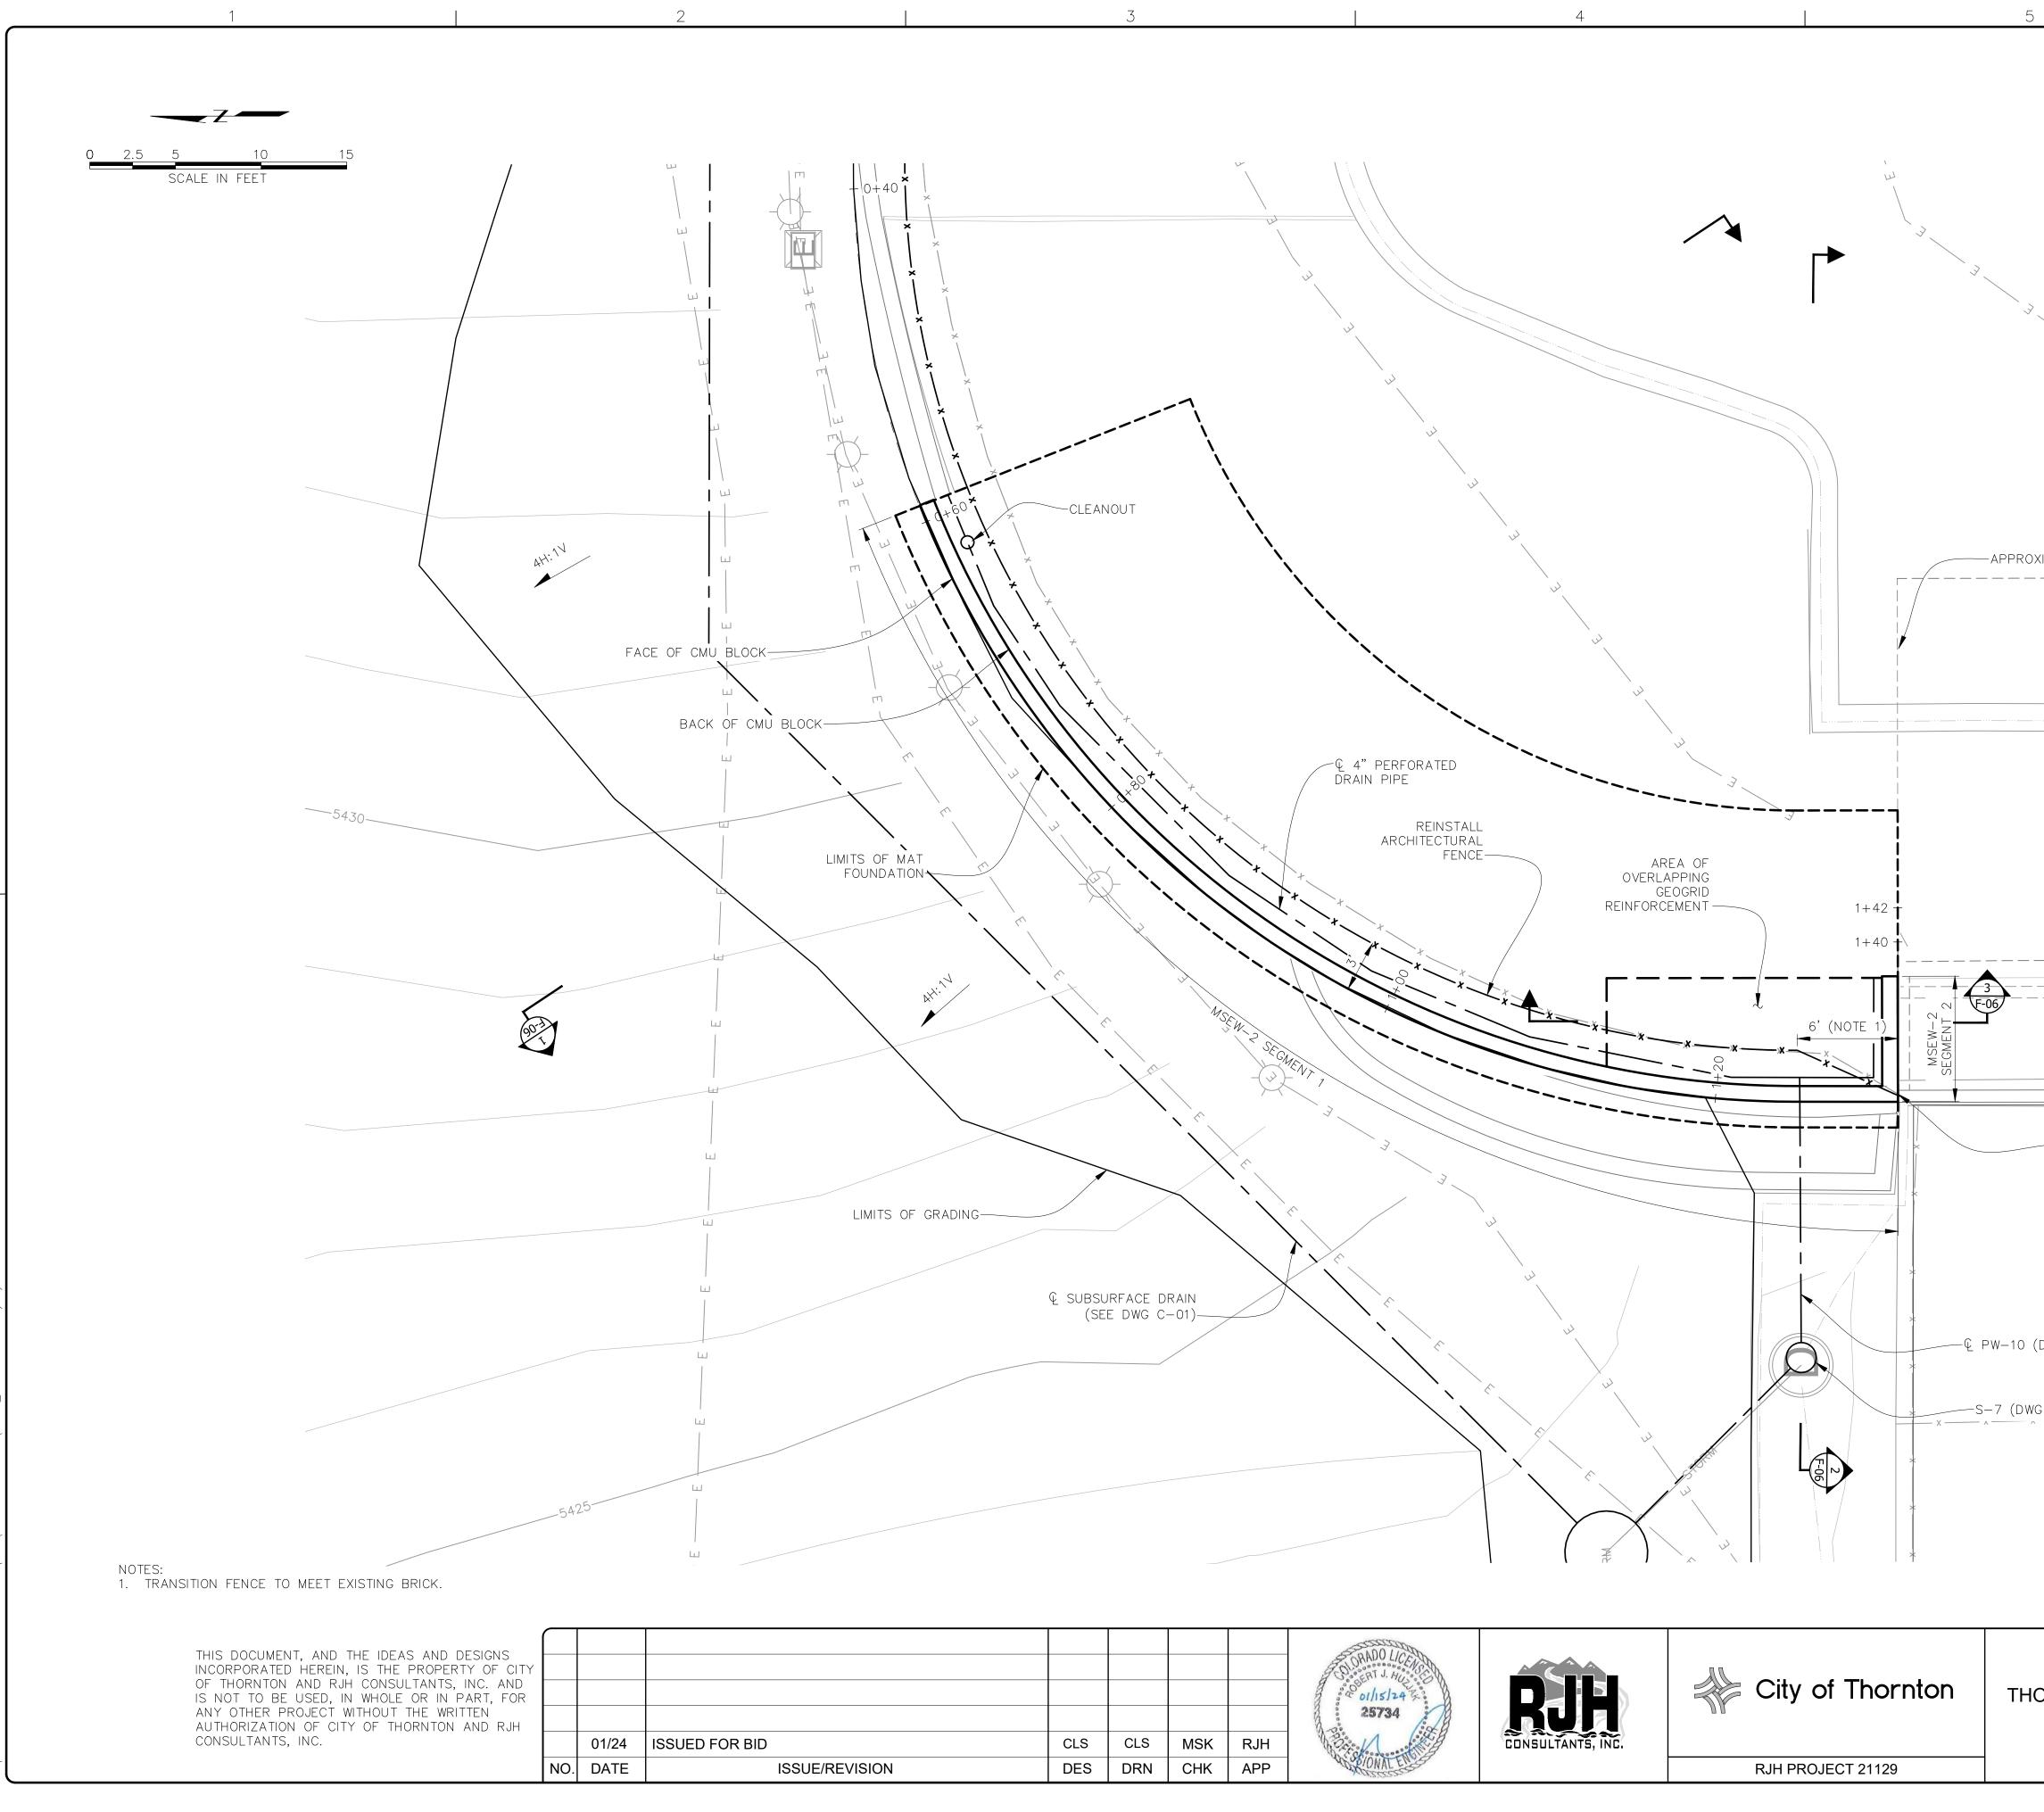
SHEET NO. 36 of 46


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F-06
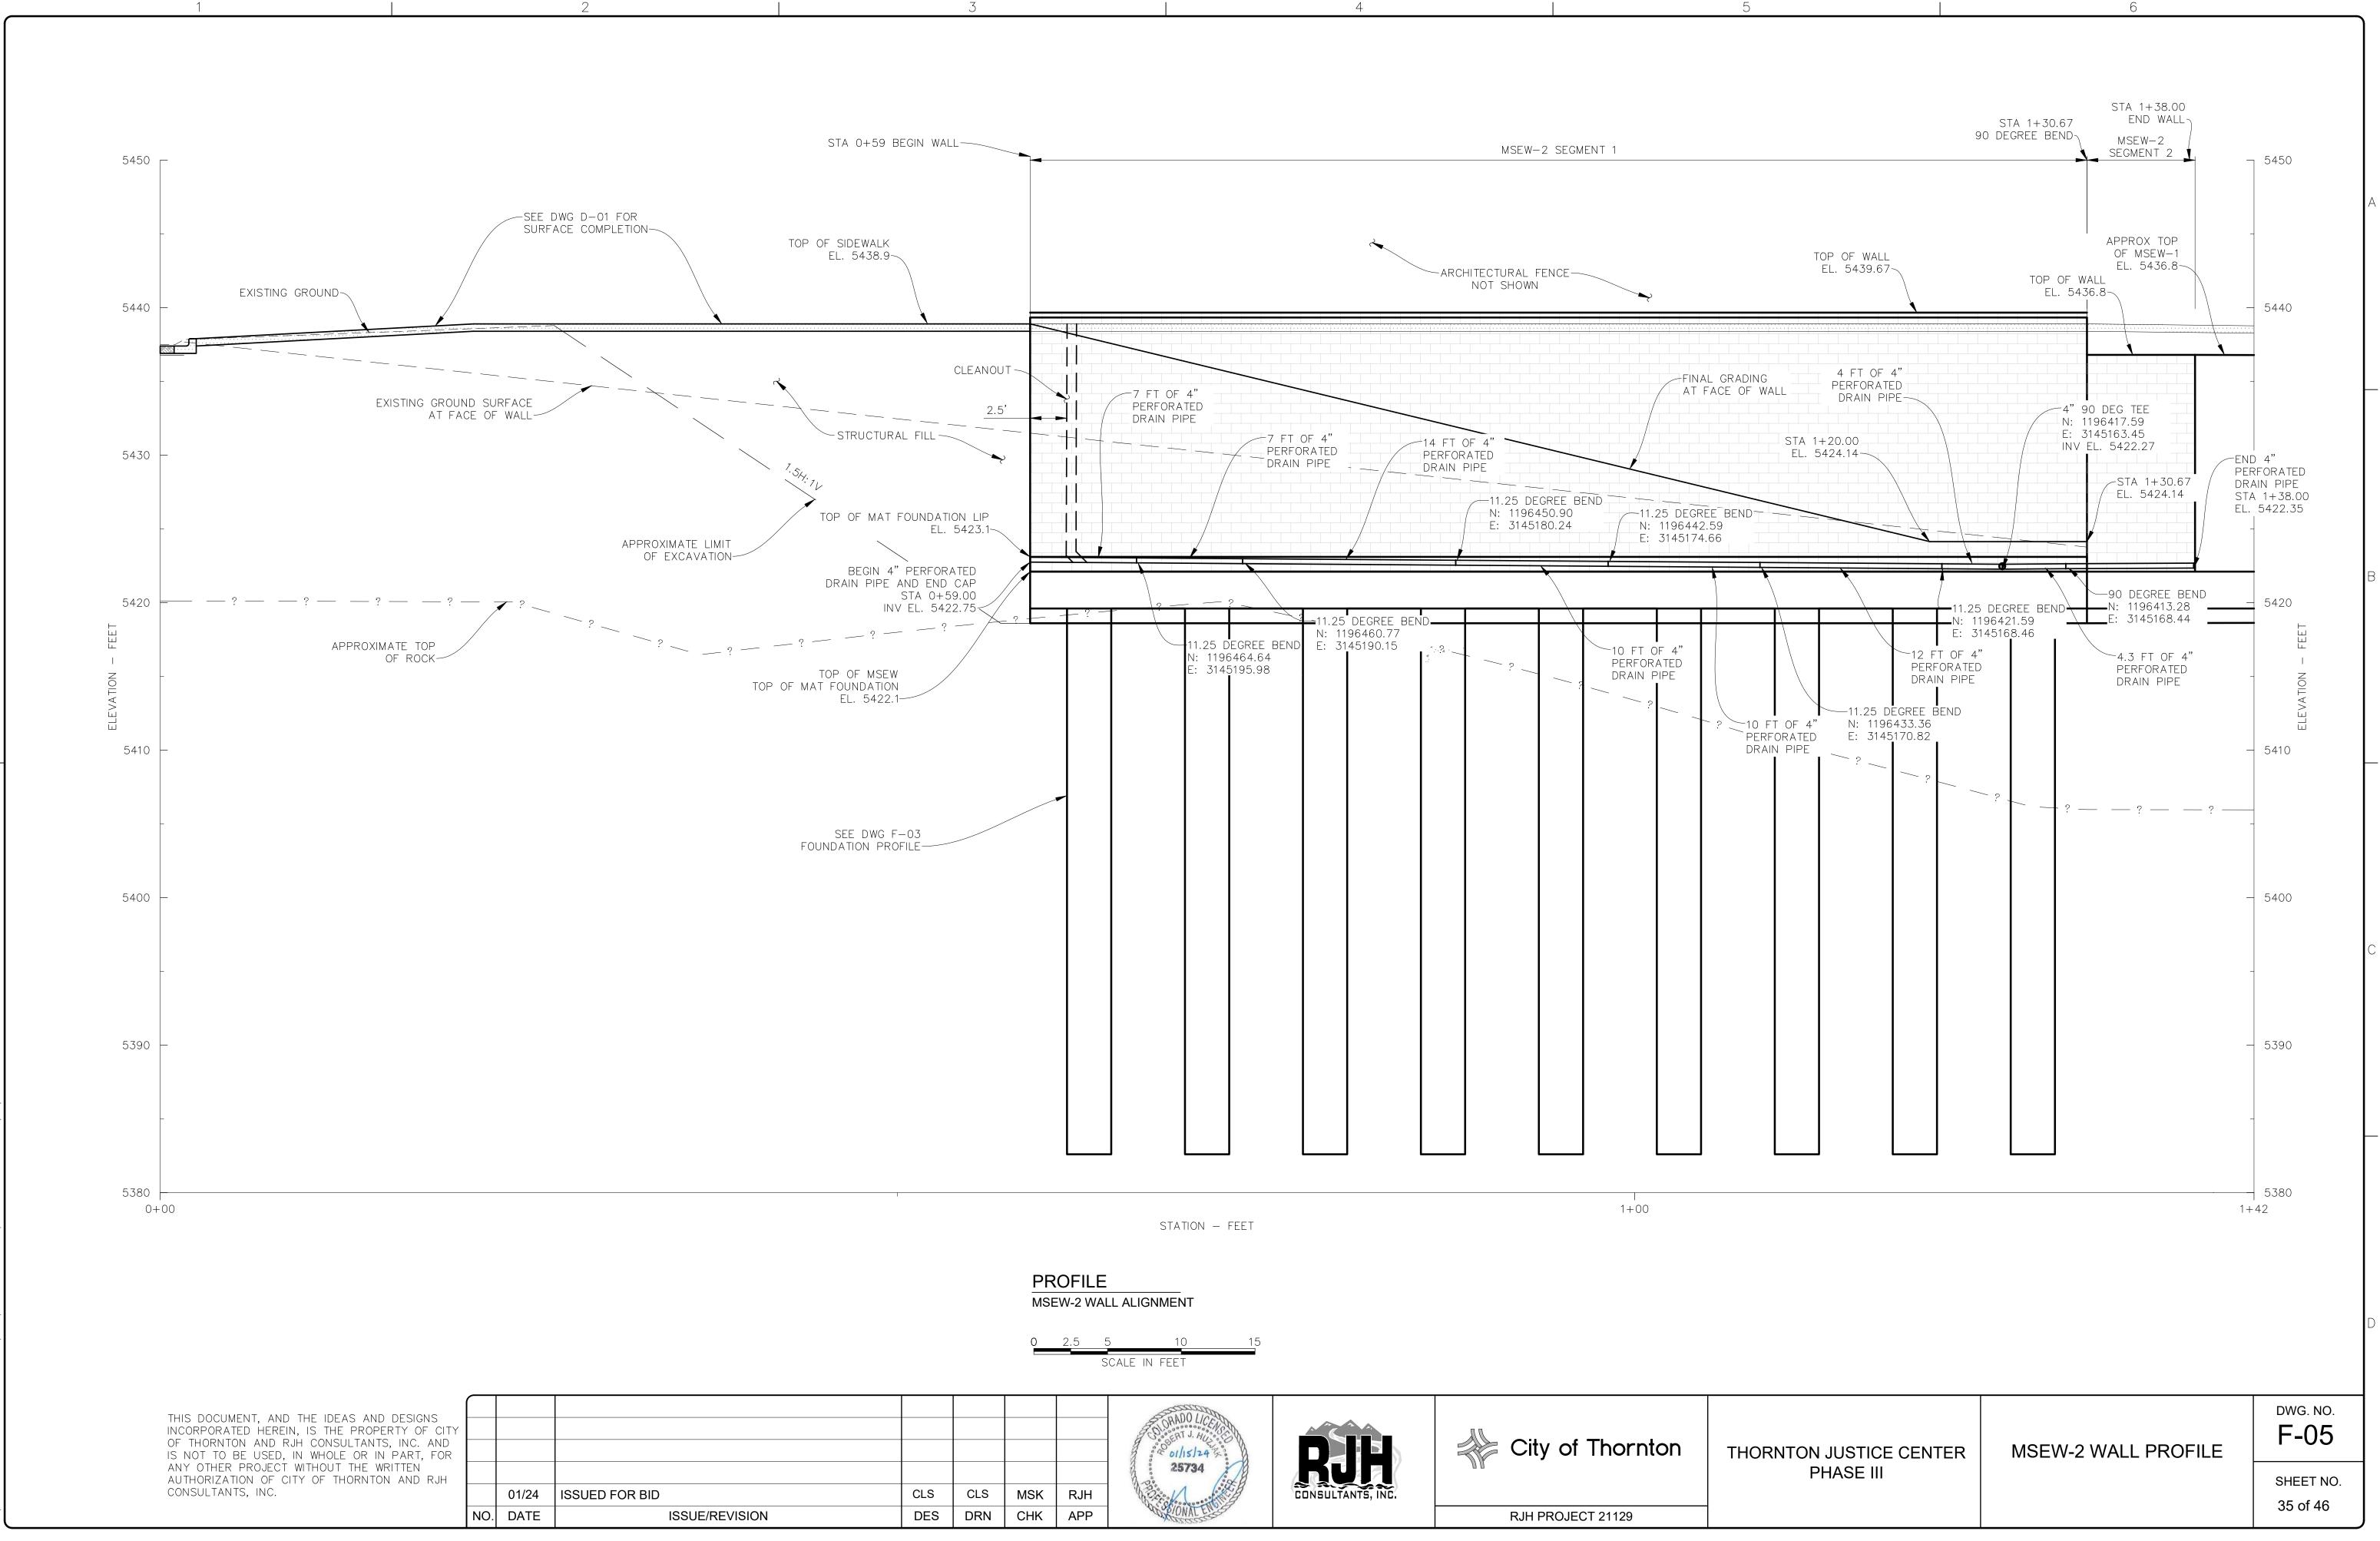
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OF 4"	PIPE.	DRAIN VARIES.					DRAIN	ON BOTH	SIDES
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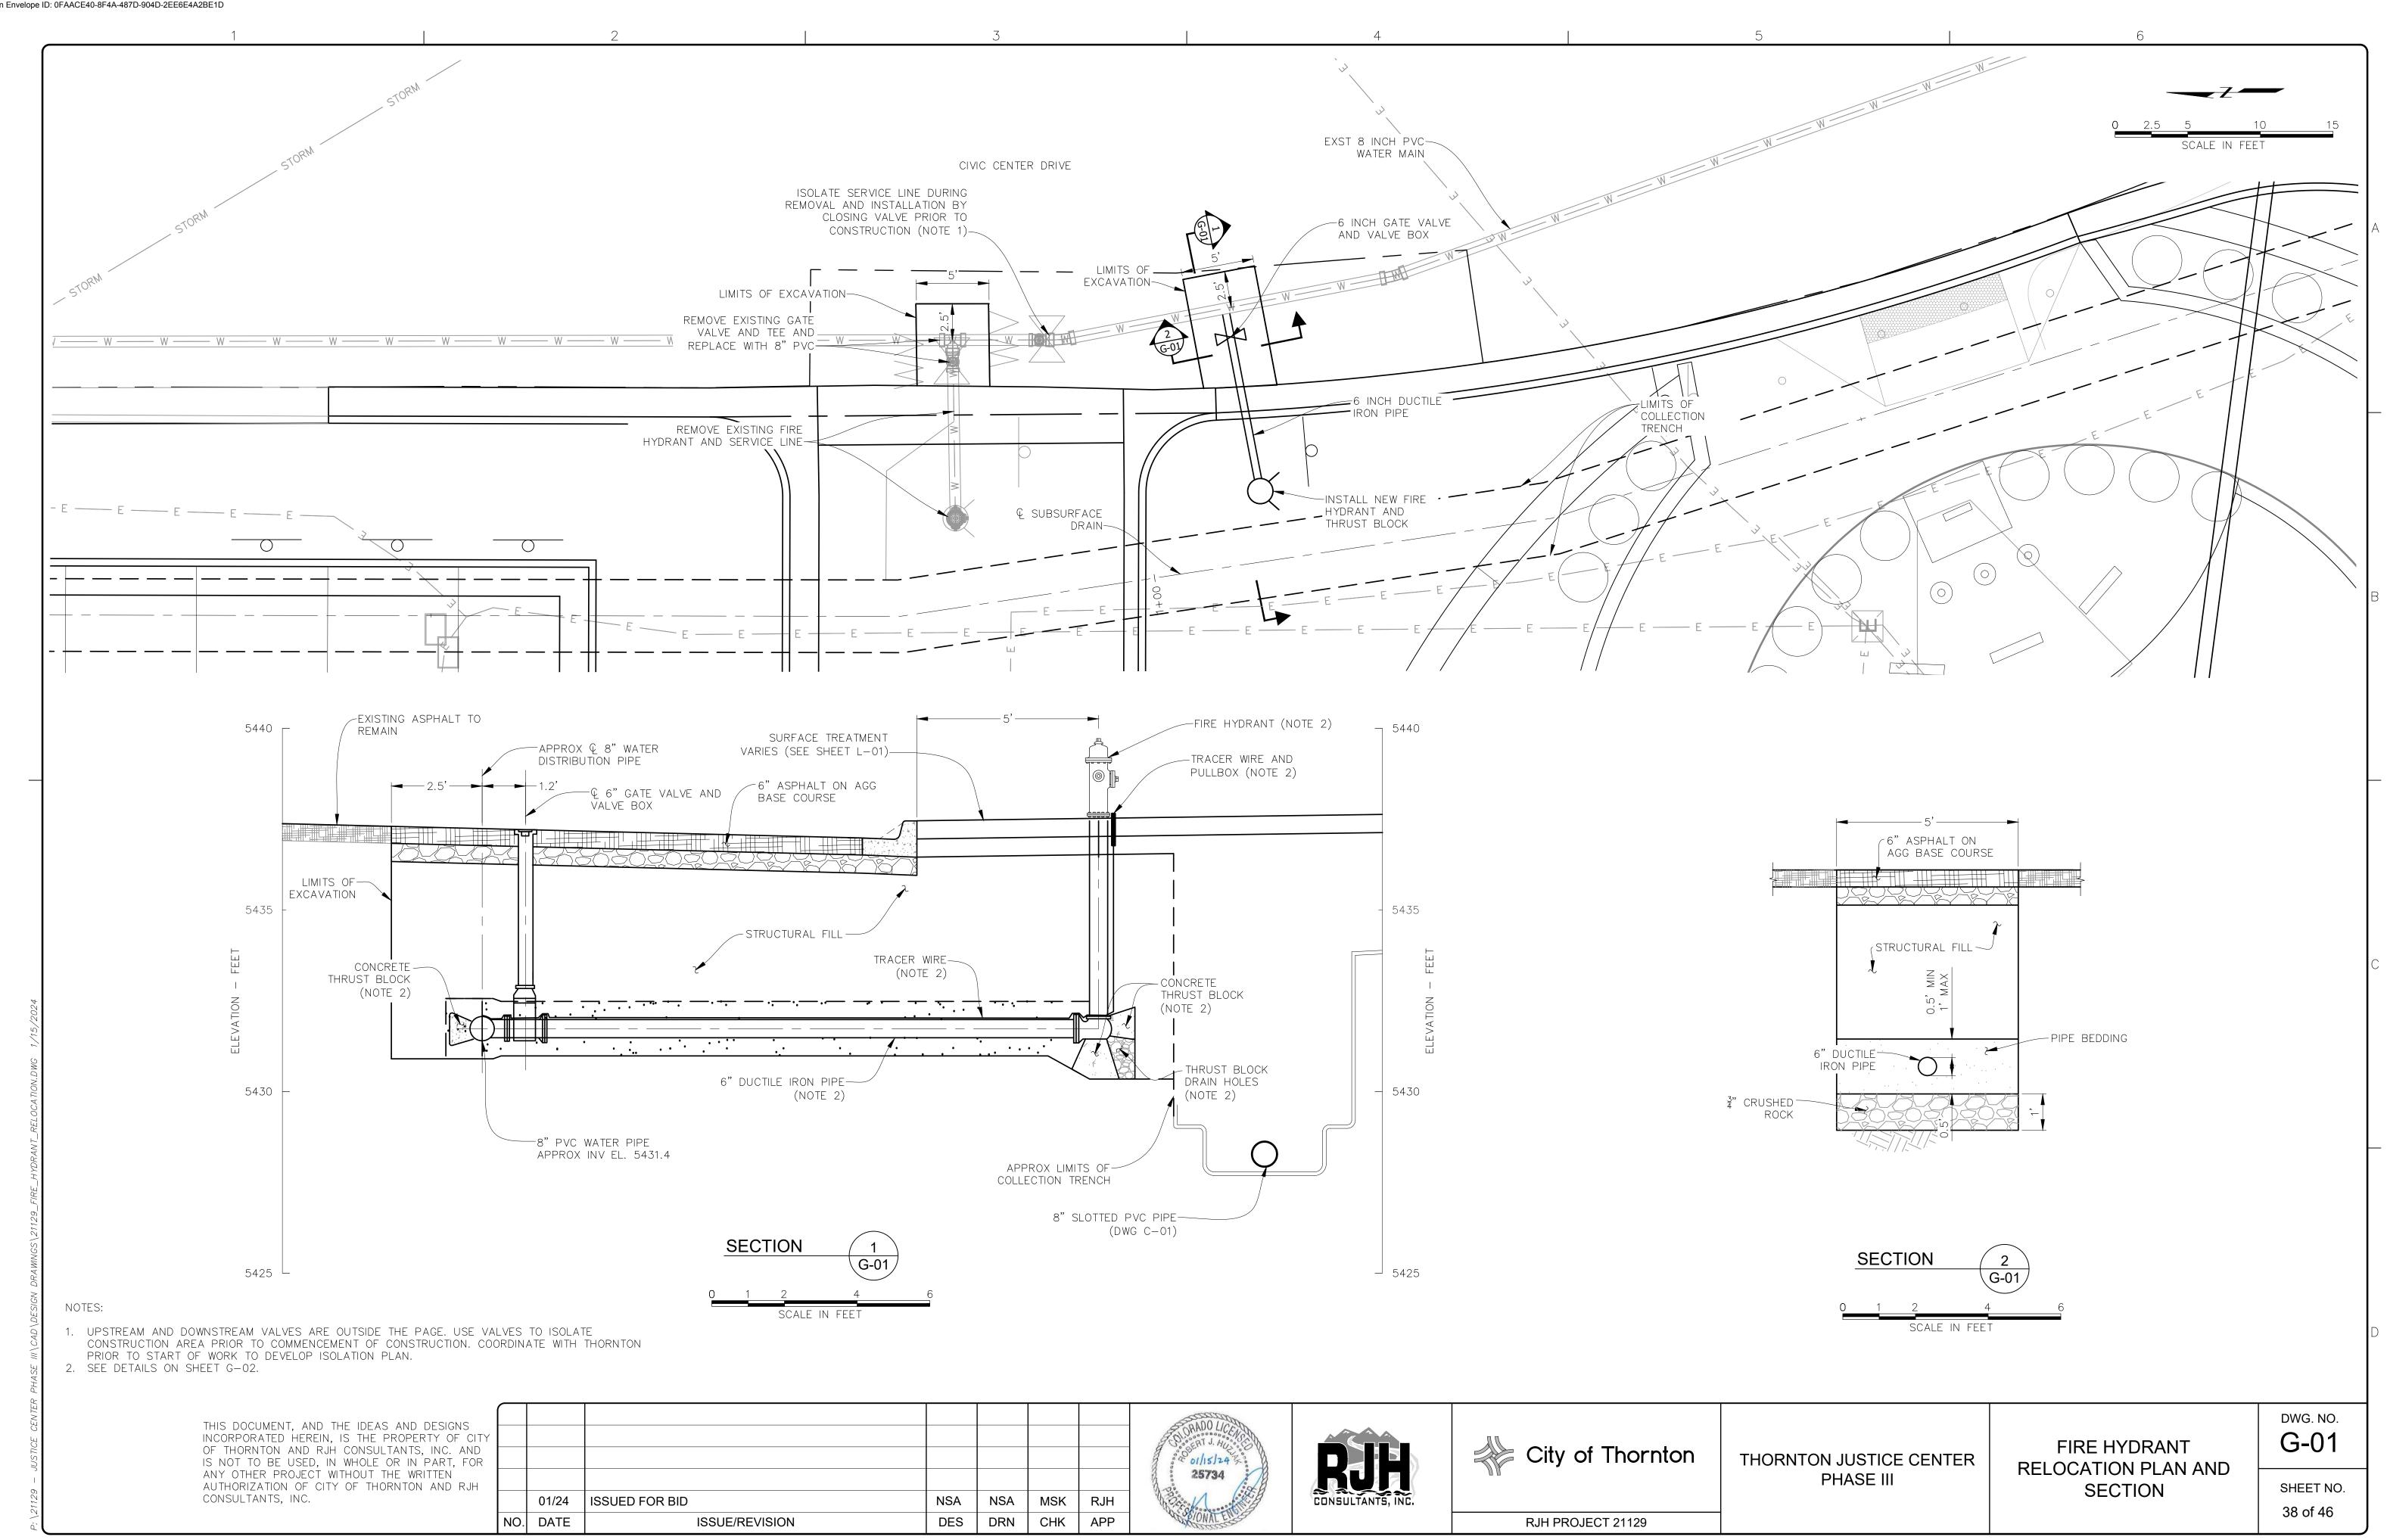


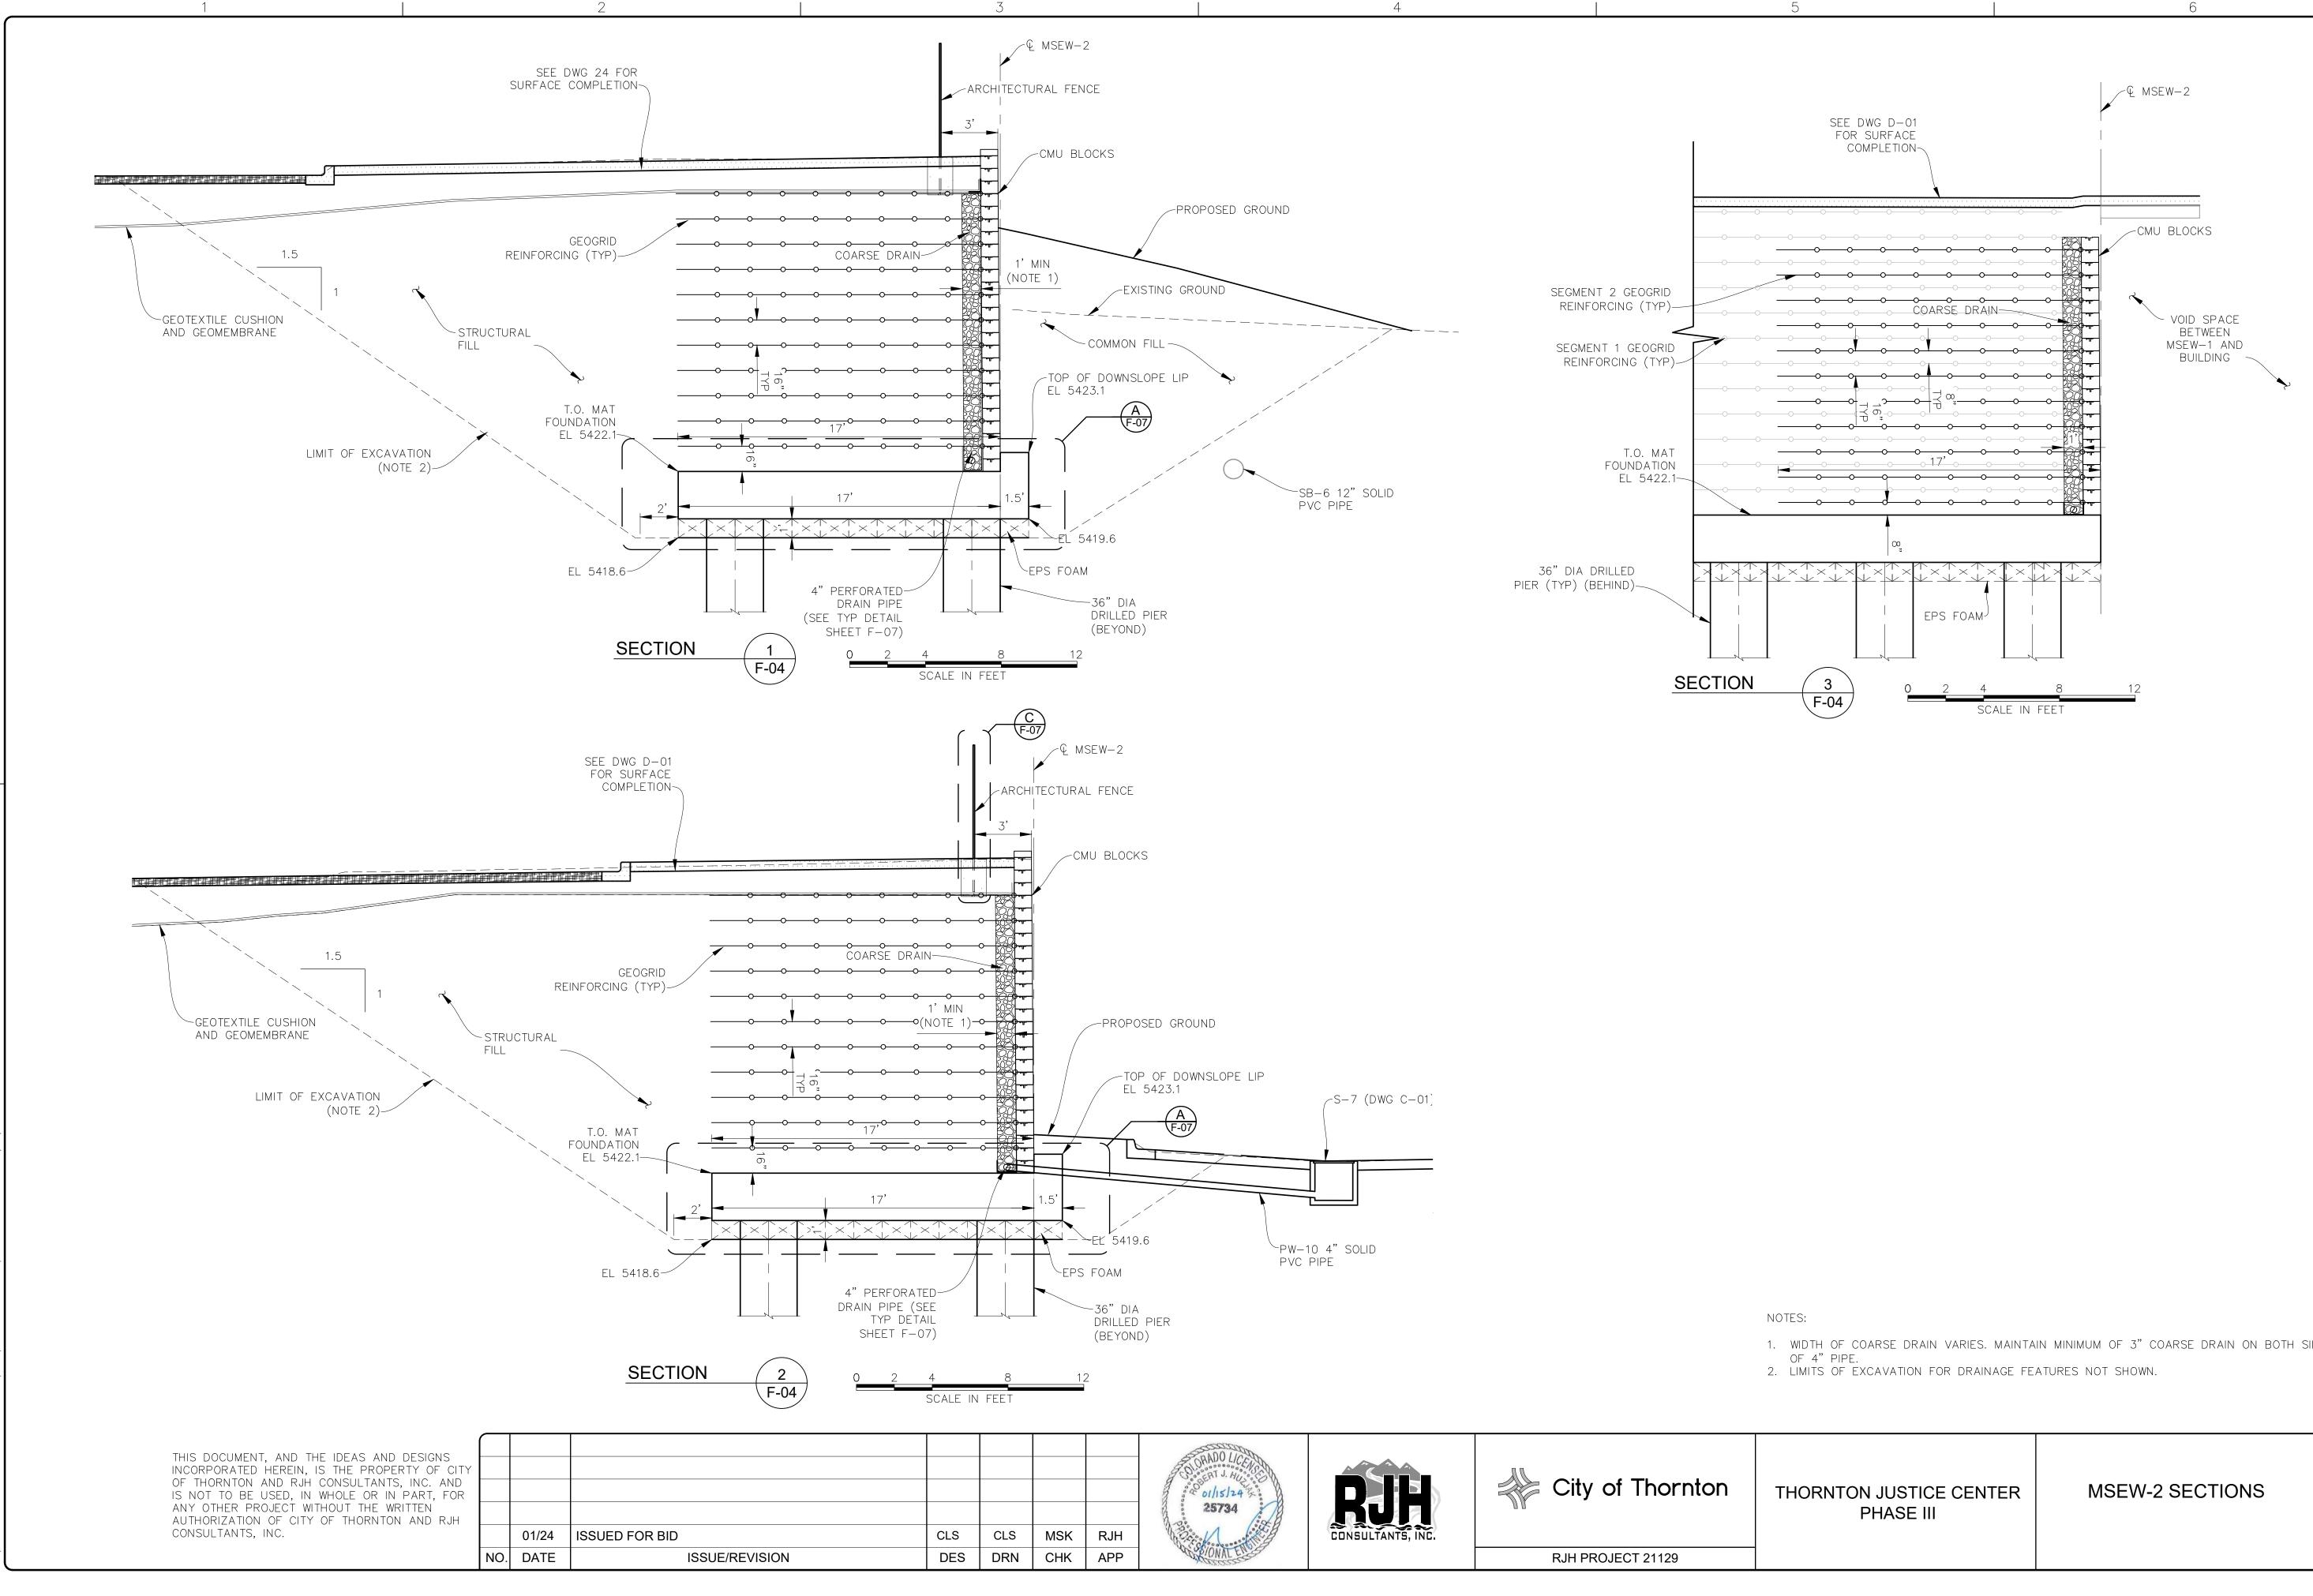



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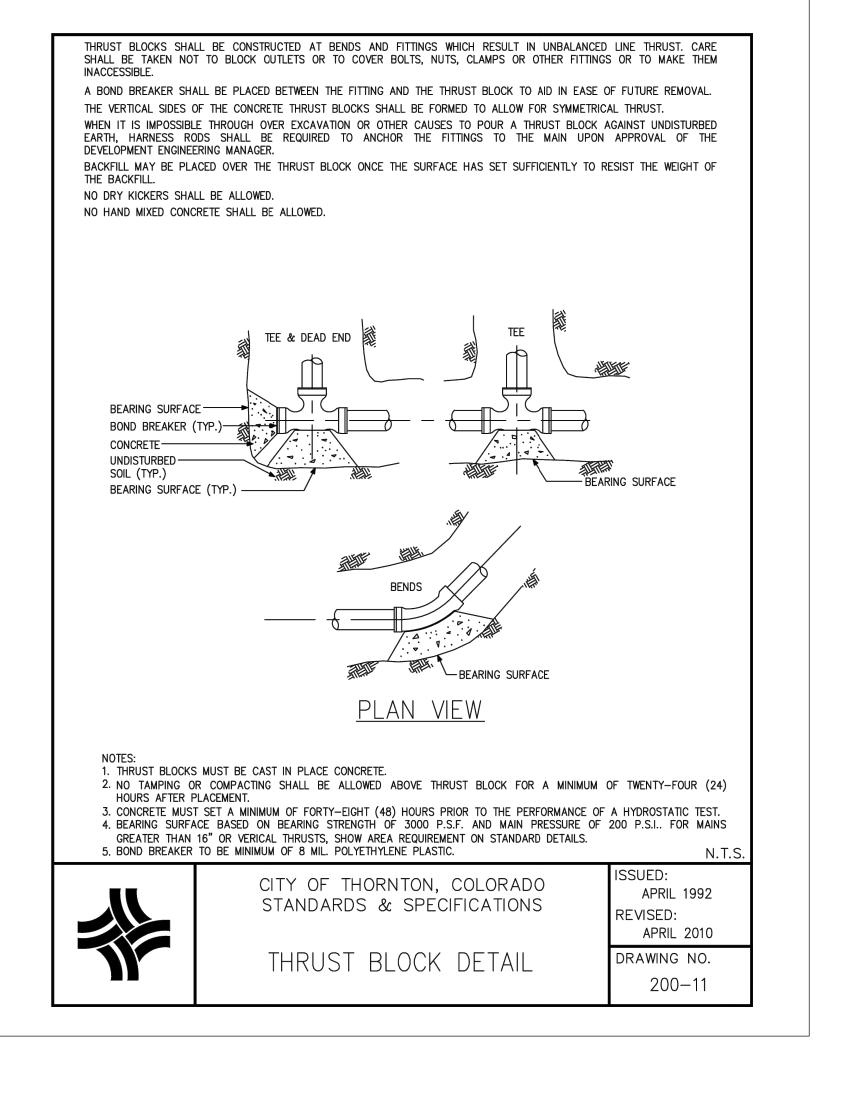
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RJH PROJECT 21129

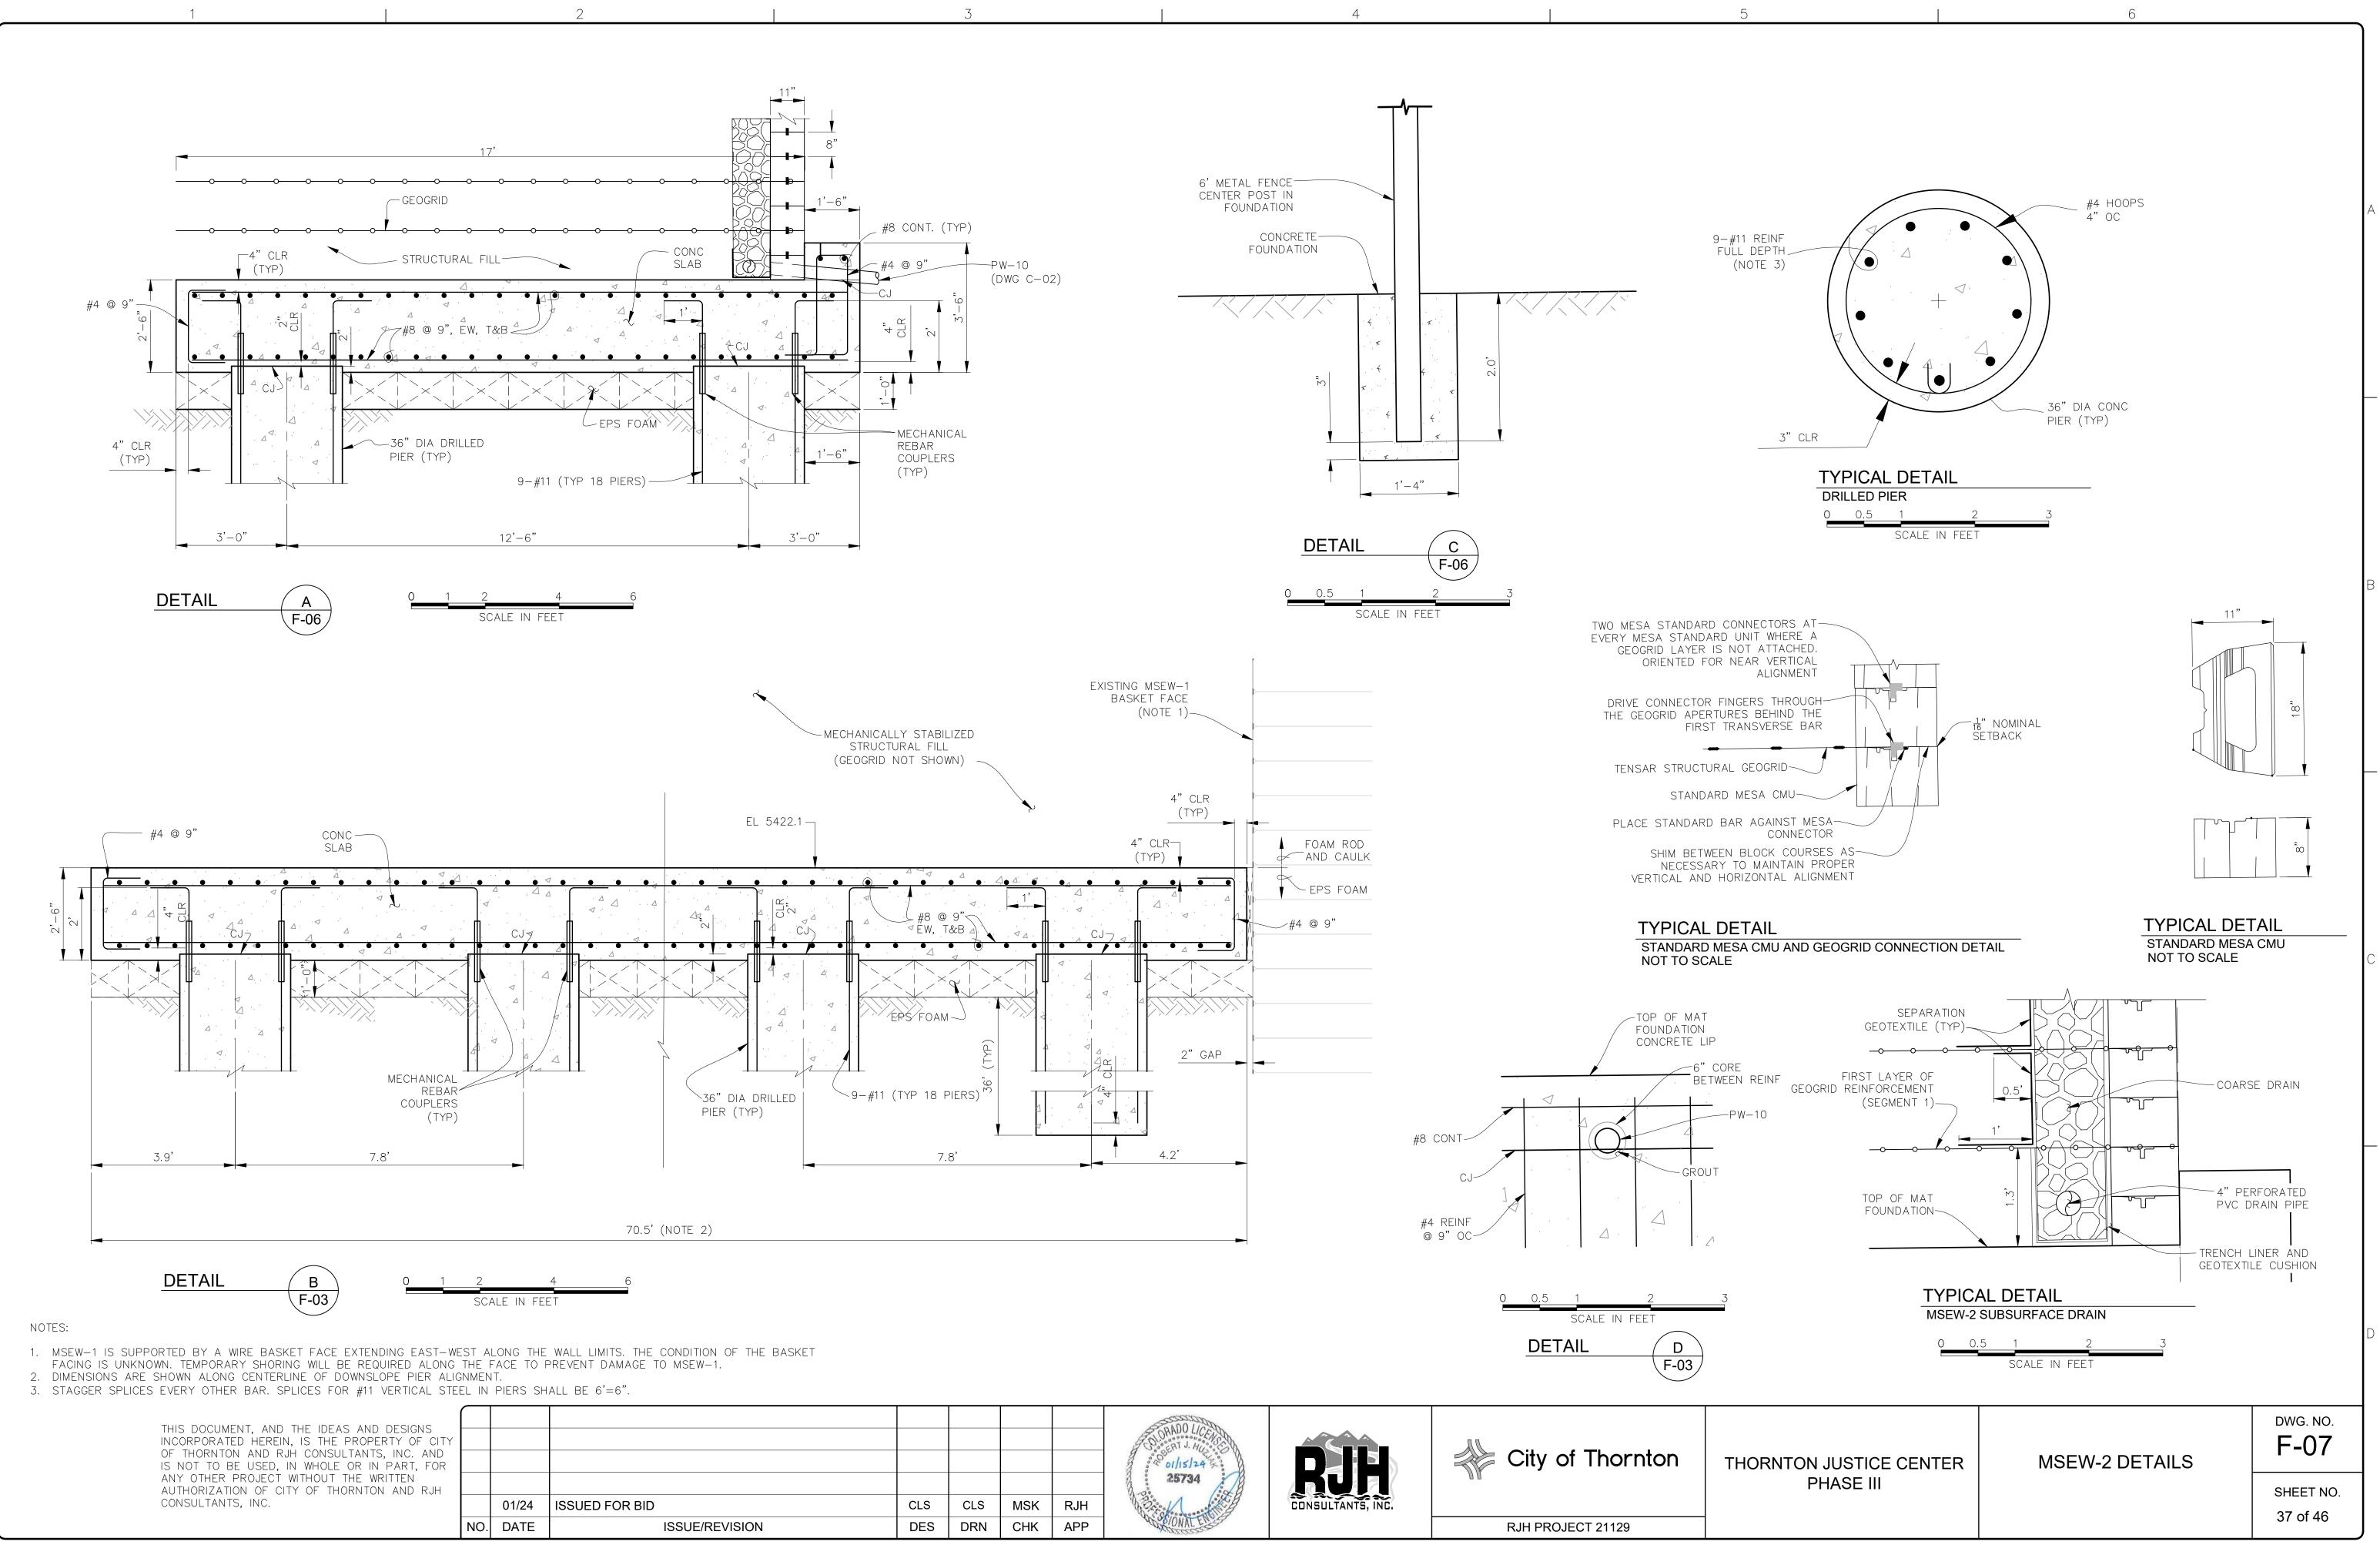

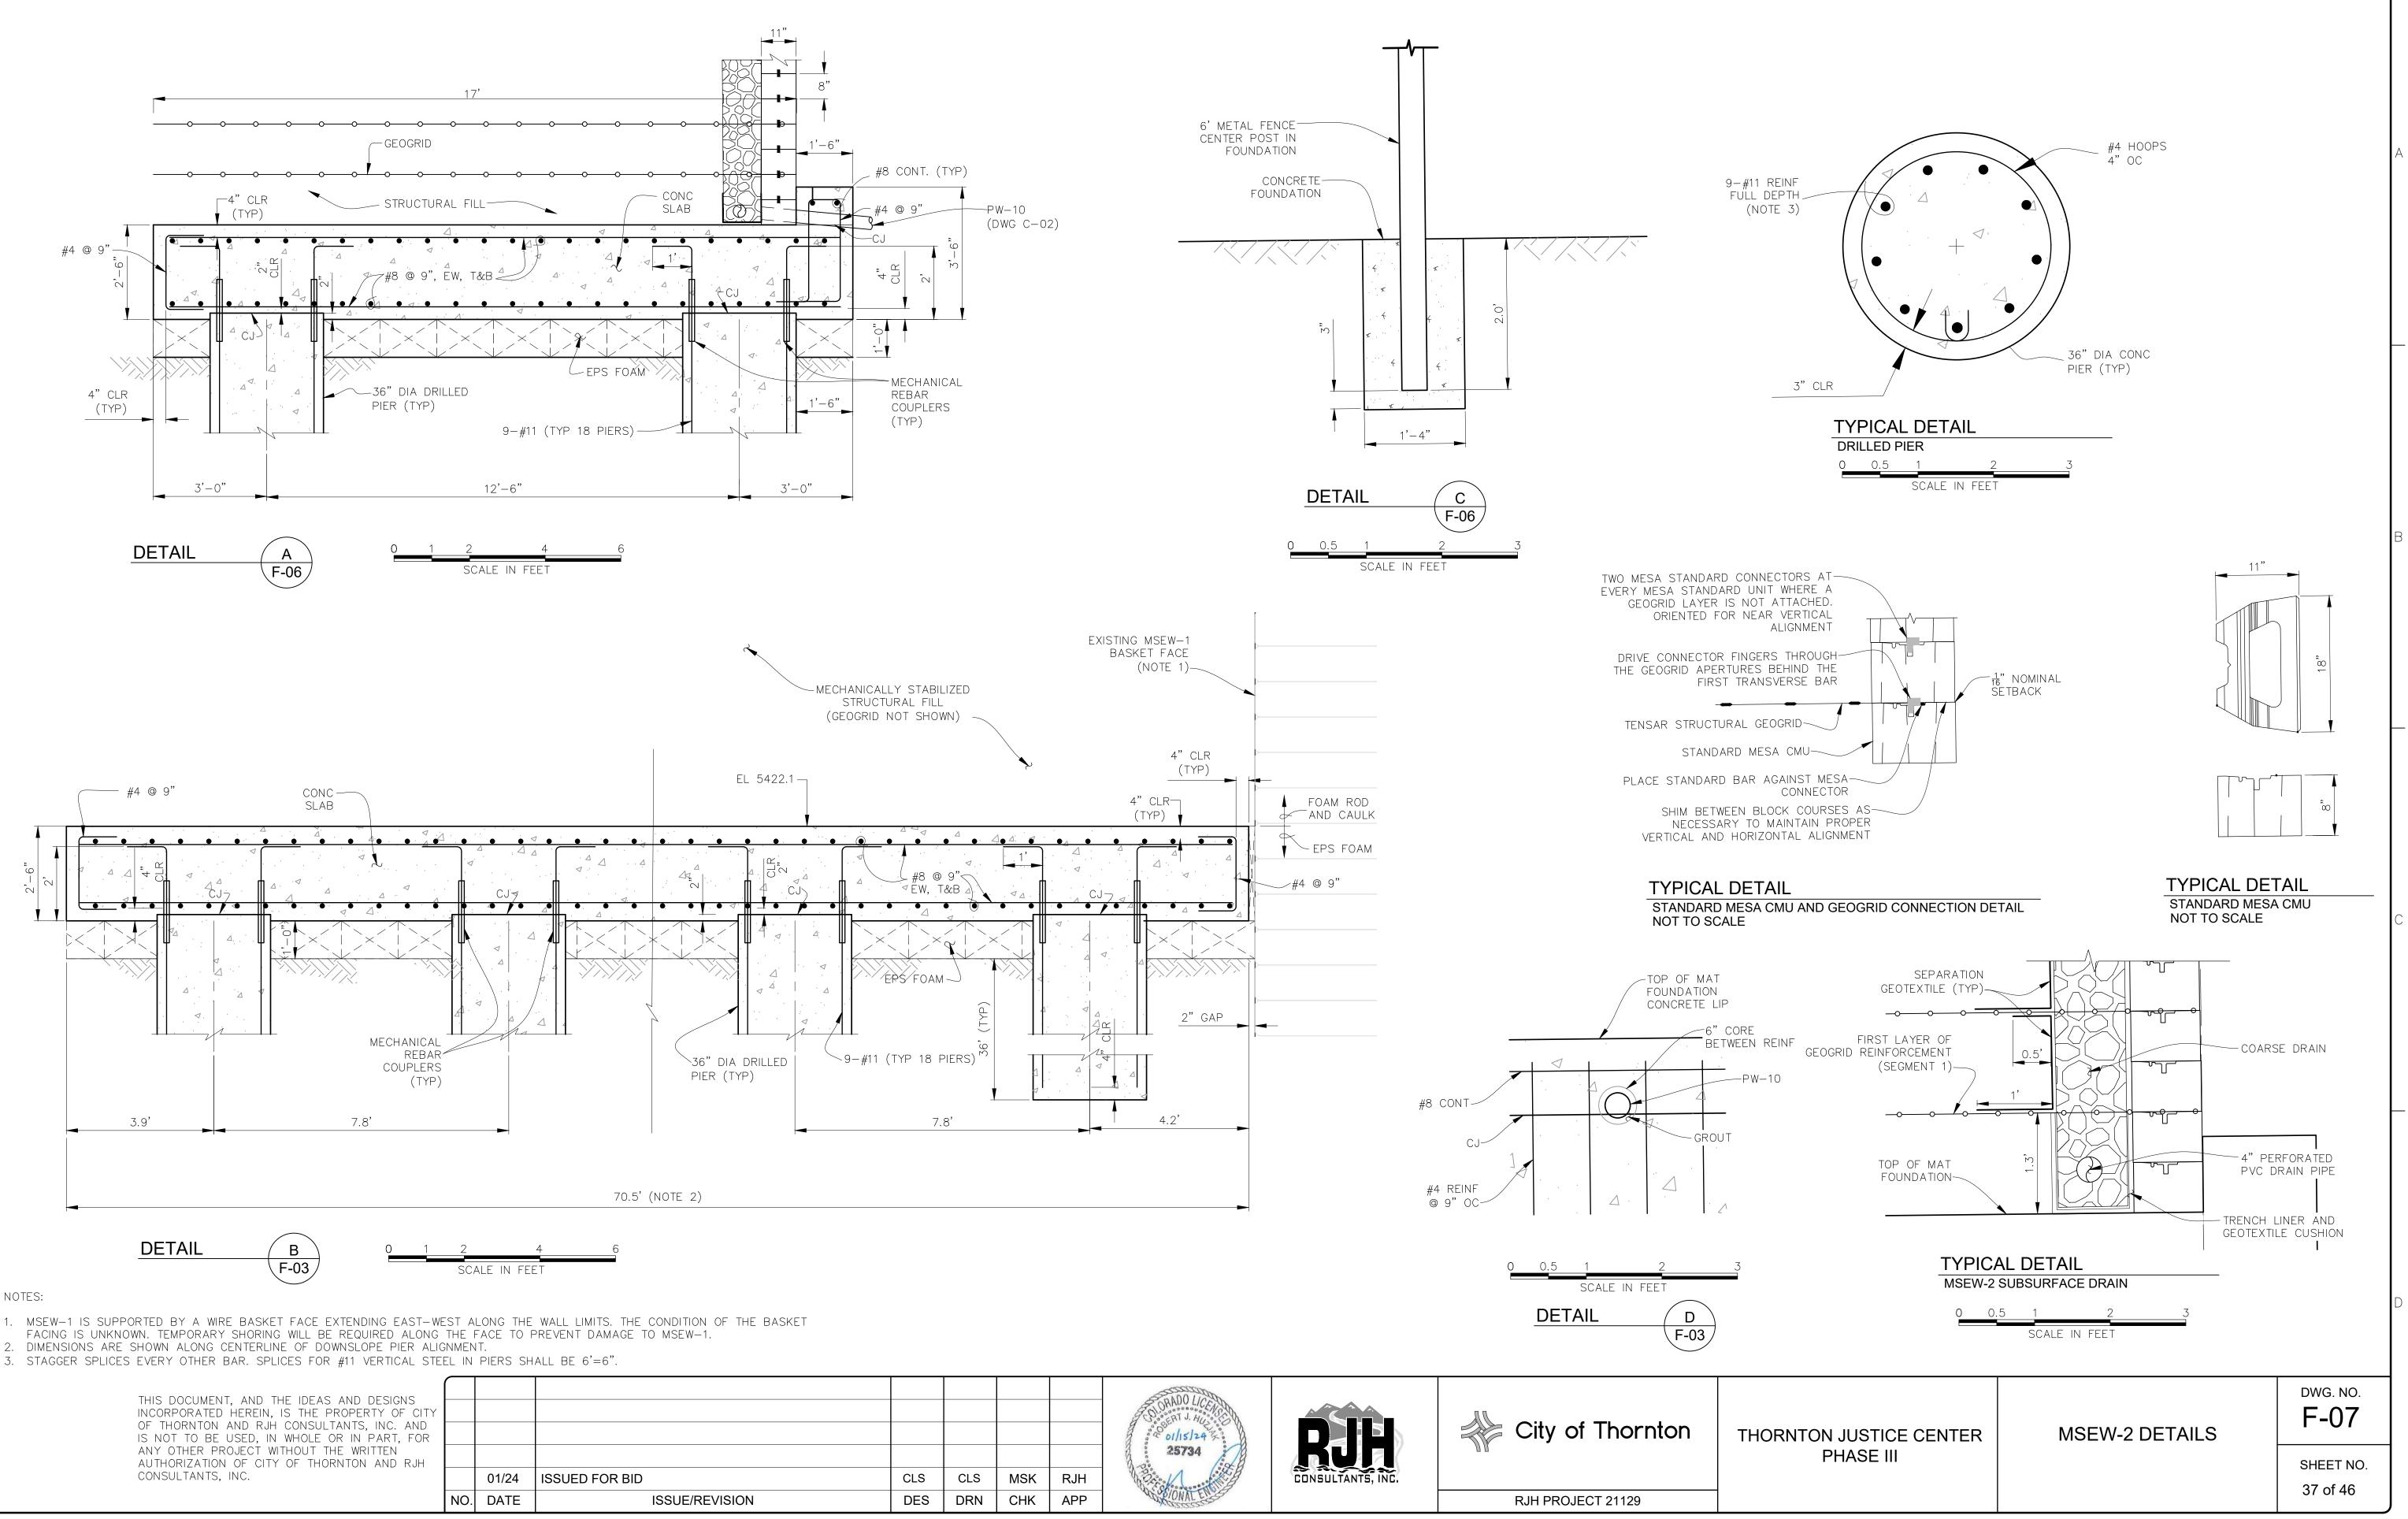
THORNTON JUSTICE CENTER PHASE III

FIRE HYDRANT **RELOCATION DETAILS**

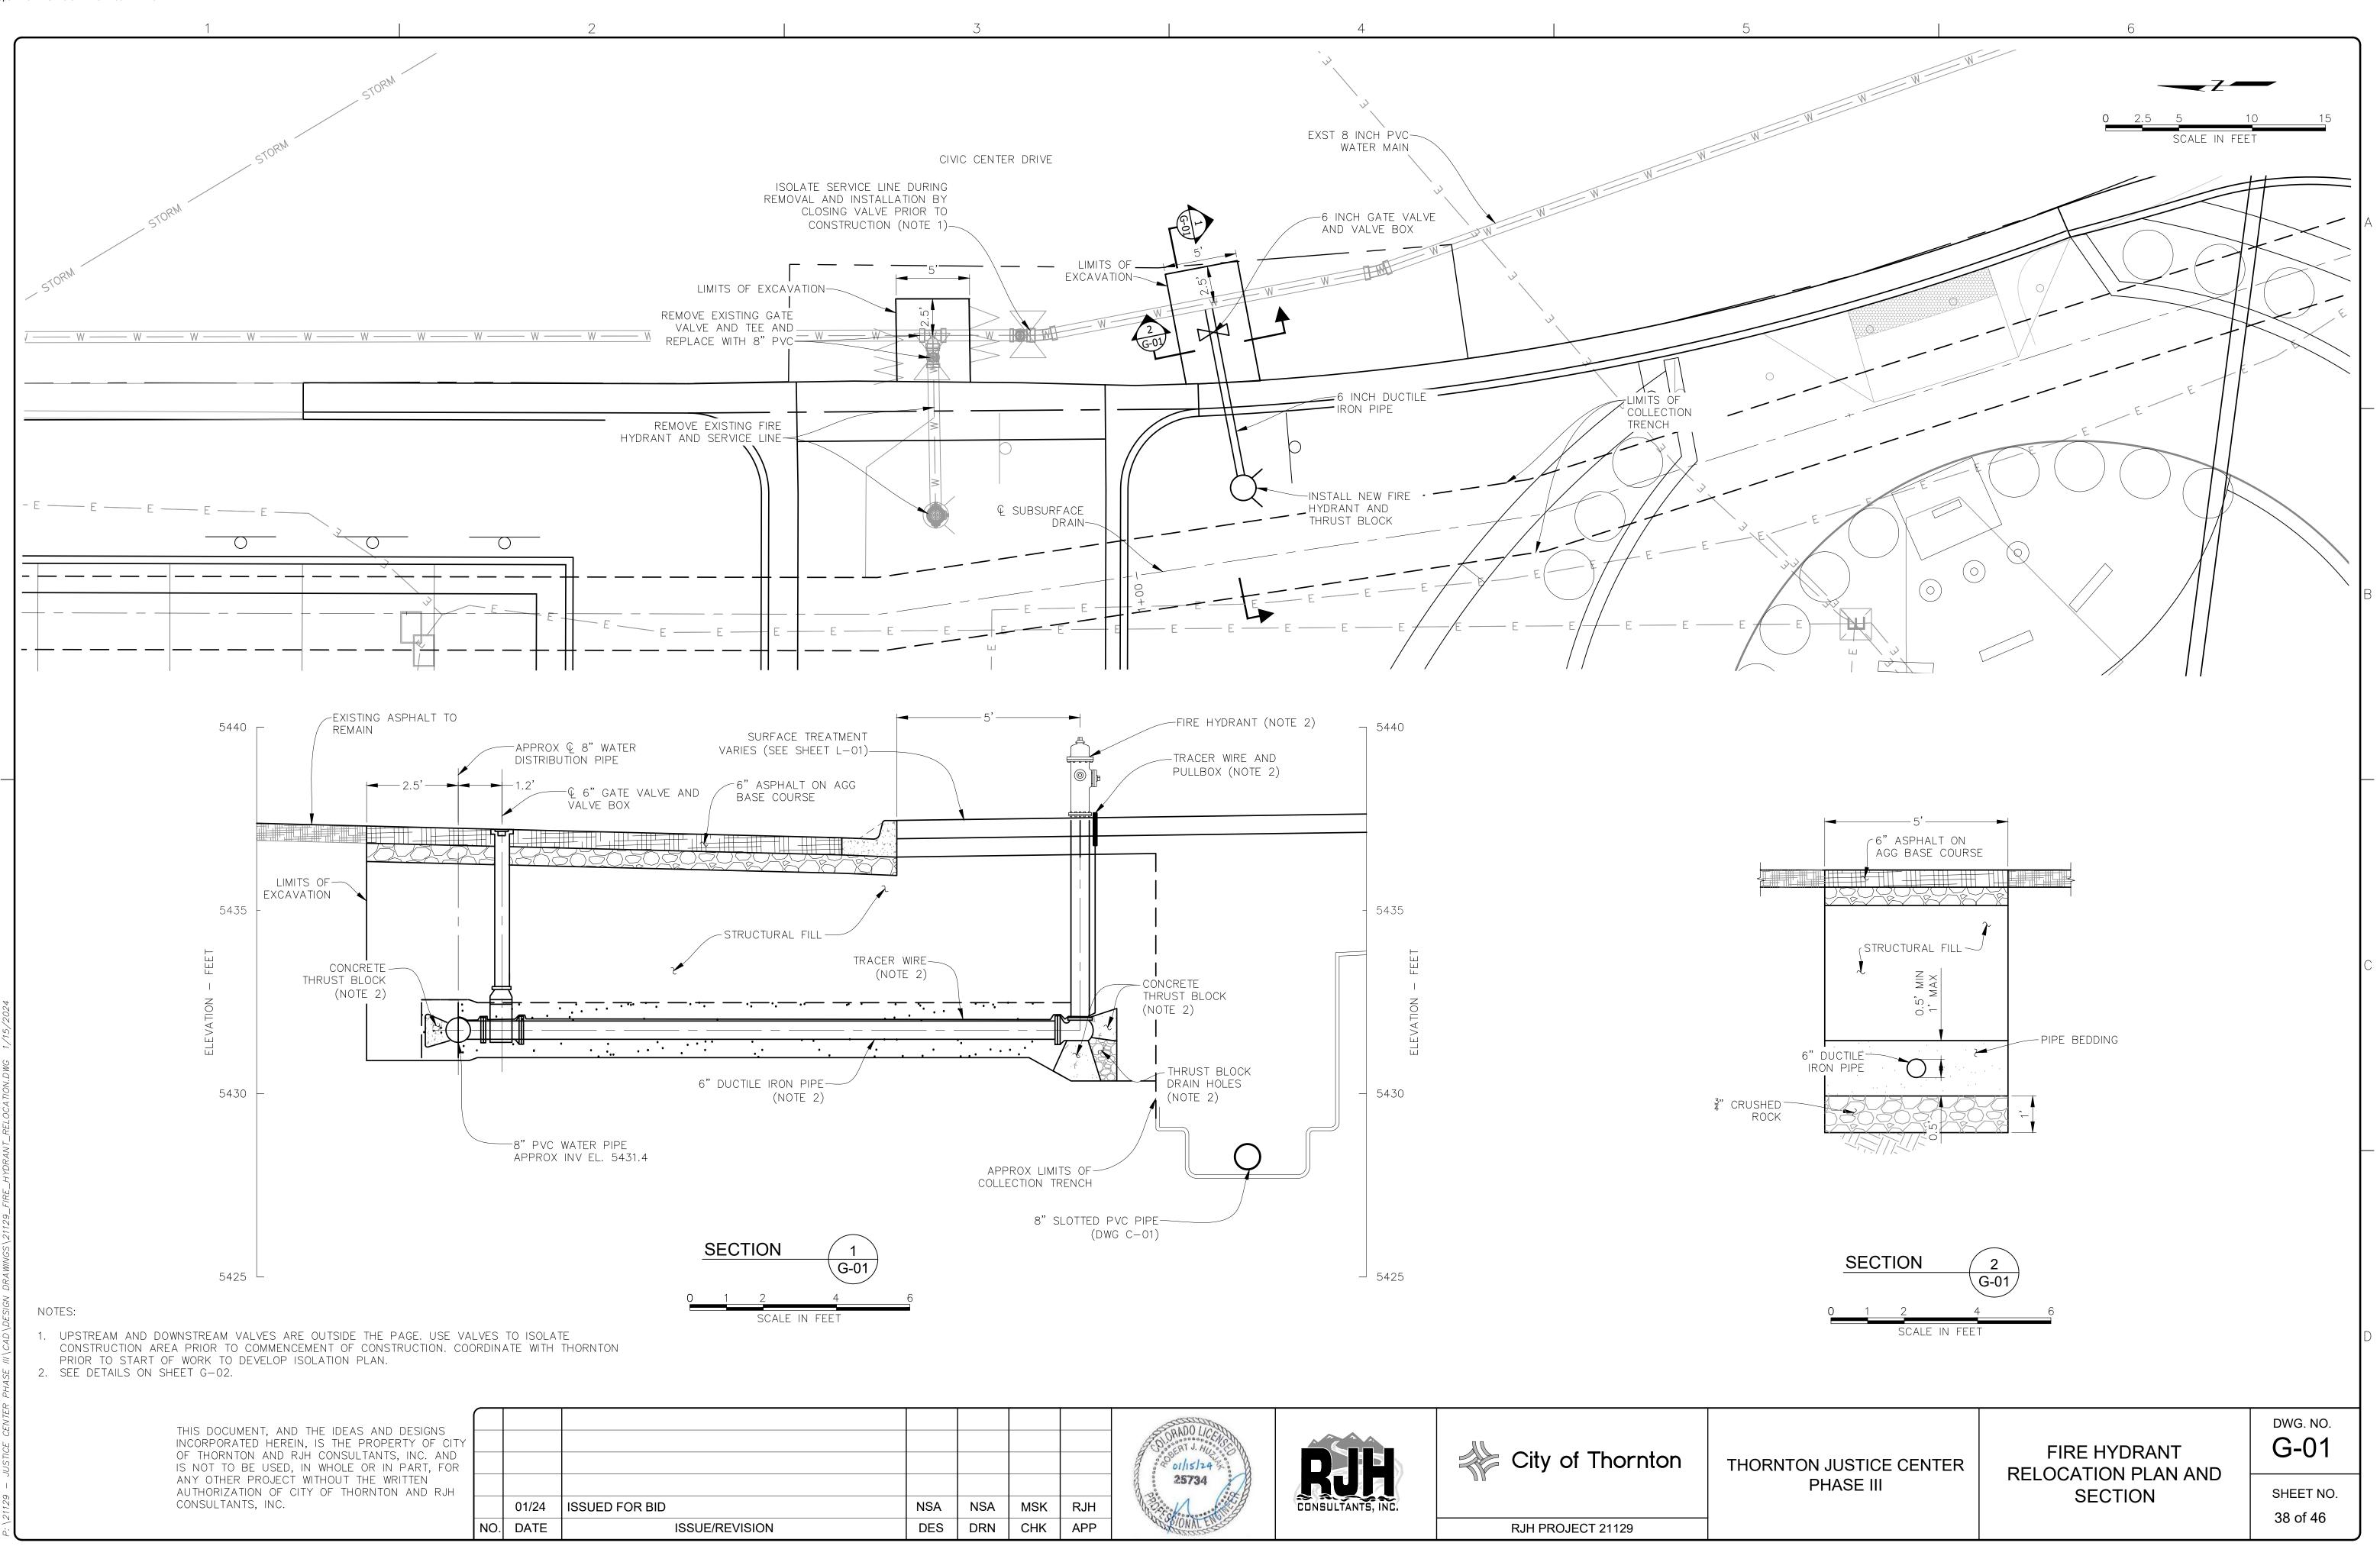
SHEET NO. 39 of 46

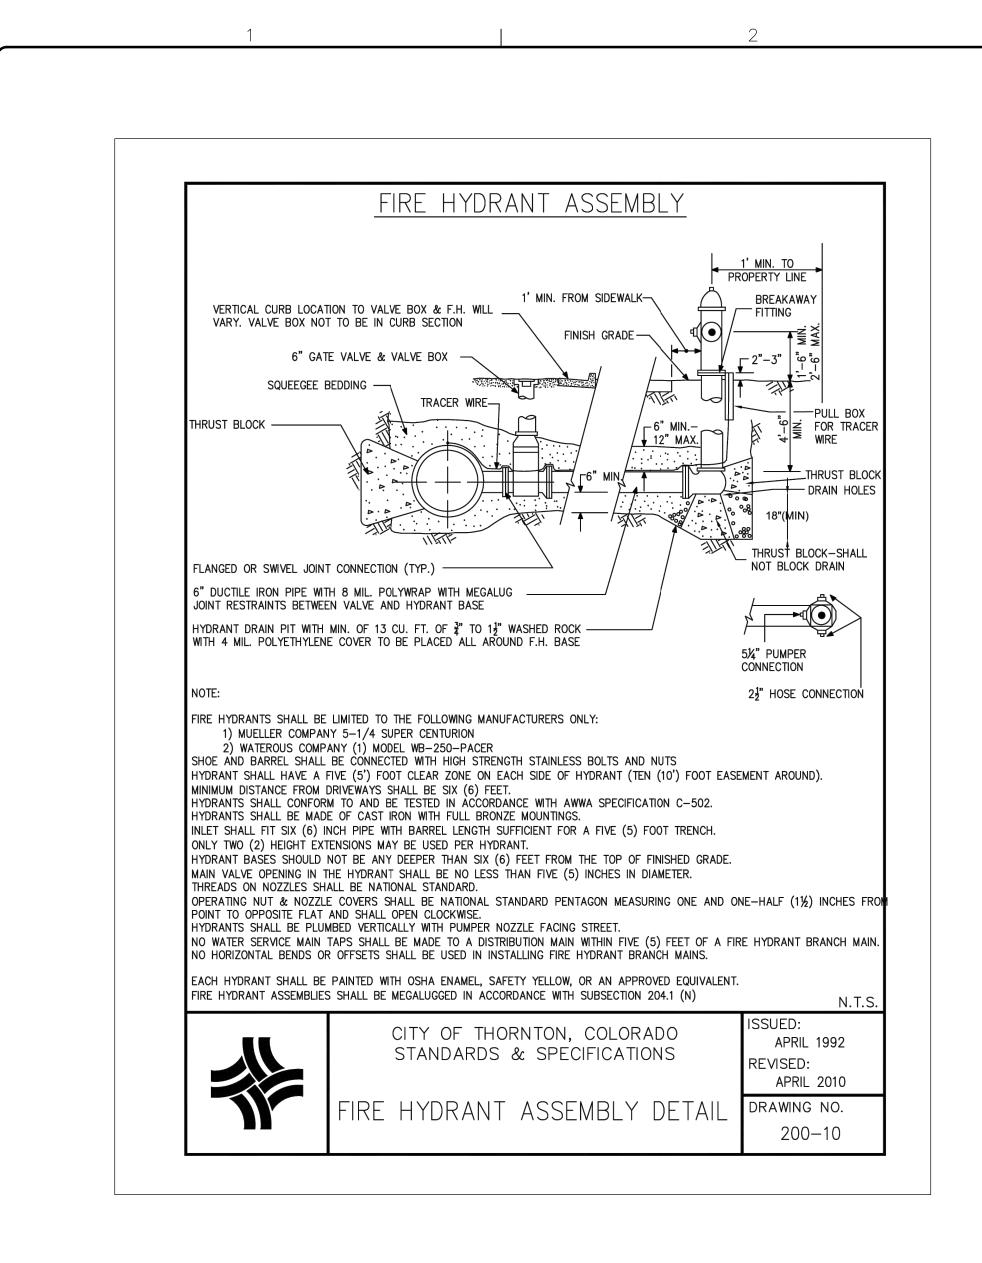DWG. NO.


G-02

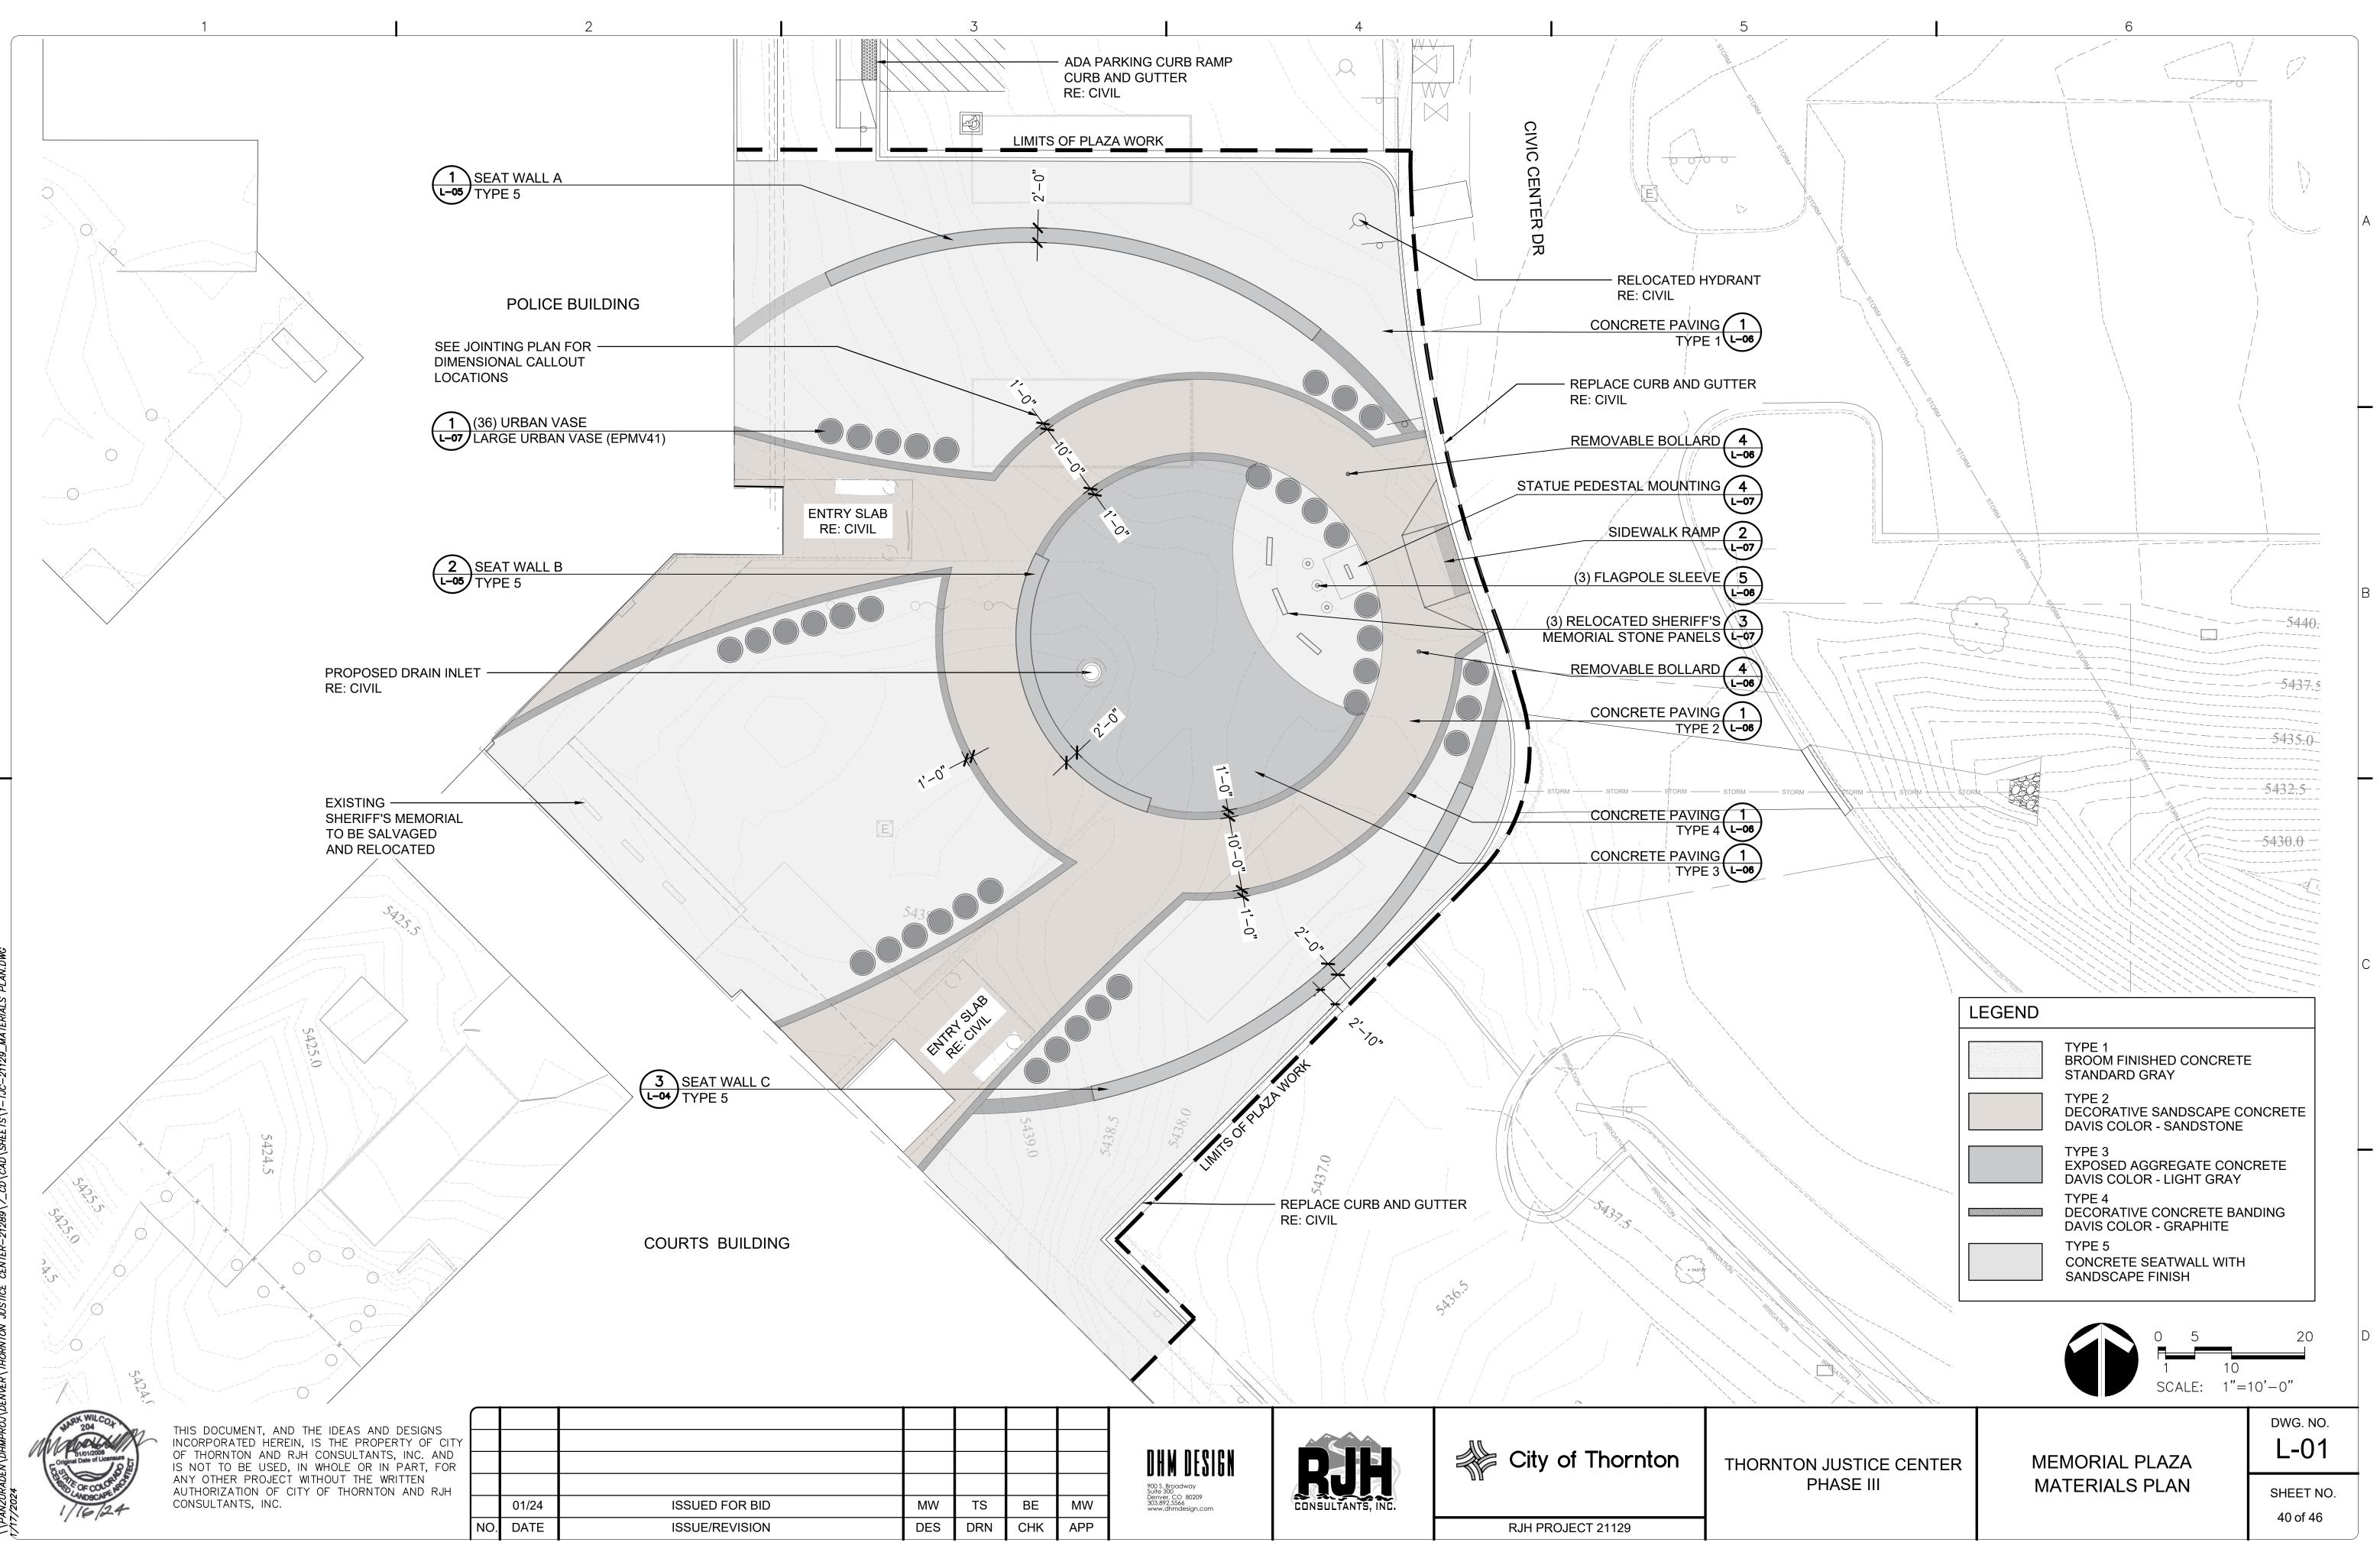

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		SPOT ELE	VATIONS		
POINT	NORTHING	EASTING	POINT	NORTHING	EASTING
P1:38.75	1196165.1211	3145174.3535	P57:38.10	1196079.2441	3145245.2148
P2:FL 38.00	1196166.6399	3145189.6542	P58:38.26	1196076.7017	3145240.3698
P3:TC 38.25	1196165.1002	3145205.5558	P59:38.42	1196074.8758	3145231.4498
P4:TC 38.09	1196165.0696	3145217.8224	P60:38.39	1196074.0713	3145208.4650
P5:TC 37.68	1196164.9972	3145246.7951	P61:38.35	1196080.6034	3145202.5722
P6:TC 37.58	1196164.9800	3145253.6133	P62:38.68	1196067.0635	3145205.3100
P7:FL 36.90	1196159.7032	3145259.6055	P63:38.86	1196065.7969	3145208.2458
P8:37.91	1196160.8405	3145228.0648	P64:38.73	1196060.2230	3145214.7793
P9:TC 38.50	1196165.1437	3145188.1479	P65:38.22	1196064.6215	3145233.0575
P10:38.97	1196154.9518	3145169.5234	P 66:38.00	1196065.9563	3145242.9010
P11:38.77	1196149.1297	3145181.5460	P67:37.91	1196069.0492	3145250.5256
P12:FL 37.10	1196148.4702	3145260.3965	P68:PC 37.94	1196067.0510	3145267.5508
P13:FL 37.20	1196138.2219	3145261.4653	P69:38.16	1196077.4174	3145259.9681
P14:38.11	1196135.2356	3145224.5982	P70:TC 38.14	1196075.1349	3145272.9021
P15:37.99	1196133.0677	3145245.9713	P71:FL 37.64	1196074.2232	3145273.7509
P16:37.60	1196128.6627	3145262.1792	P72:TC 37.64	1196056.2685	3145256.7754
P17:37.30	1196127.8199	3145263.4881	P73:FL 37.17	1196054.8422	3145256.1823
P18:37.77	1196126.8265	3145256.2291	P74:TC 37.61	1196054.3430	3145254.8576
P19:38.00	1196123.7454	3145239.2781	P75:FL 37.54	1196048.3142	3145249.4956
P20:38.16	1196124.2602	3145226.1734	P76:38.61	1196055.9013	3145218.7952
P21:38.67	1196122.3794	3145204.1003	P77:39.04	1196055.4950	3145199.9137
P22:38.97	1196121.1531	3145192.7006	P78:39.01	1196051.3375	3145204.1211
P23:39.24	1196120.6946	3145175.4661	P79:38.95	1196046.4763	3145208.6291
P24:39.31	1196122.7685	3145169.6785	P80:39.28	1196052.3716	3145168.3508
P25:39.35	1196110.5067	3145161.1419	P81:39.26	1196044.8308	3145190.4808
P26:39.4	1196112.4825	3145176.6477	P82:39.28	1196040.7012	3145194.5746
P27:39.01	1196111.2475	3145192.5170	P83:39.26	1196036.6979	3145198.1288
P28:38.68	1196108.9562	3145197.7169	P84:38.86	1196035.5216	3145216.2382
P29:38.45	1196110.7364	3145210.3957	P85:38.62	1196037.9985	3145217.5535
P30:38.31	1196120.9239	3145216.9196	P86:37.75	1196040.4918	3145240.8478
P31:TC 37.89	1196121.6684	3145264.5320	P87:37.9	1196036.6033	3145238.5117
P32:TC 38.02	1196118.2921	3145265.2276	P88:TC 37.95	1196034.4145	3145235.0486
P33:FL 37.39	1196121.7507	3145265.0269	P89:FL 37.4	1196032.6804	3145235.3266
P34:FL 37.52	1196118.0370	3145265.9023	P90:39.17	1196030.7690	3145206.3869
P35:FL 37.48	1196115.9927	3145266.5725	P91:39.36	1196029.2421	3145193.2634
P36:37.98	1196114.0919	3145259.8355	P92:39.37	1196022.4805	3145199.2063
P37:FL 37.63	1196106.4355	3145269.4893	P93:39.1	1196024.5712	3145212.5445
P38:38.13	1196104.2281	3145262.9242	P94:38.88	1196028.5083	3145214.7807
P39:HP. 38.16	1196108.7940	3145253.1236	P95:38.58	1196026.0520	3145221.6785
P40:HP 38.48	1196103.6618	3145241.4746	P96:38.22	1196026.6992	3145227.9857
P41:38.21	1196099.4638	3145207.8872	P97:TC 38.44	1196024.7374	3145225.3281
P42:38.52	1196100.7366	3145196.4898	P98:FL 37.5	1196022.7423	3145225.4628
P43:38.35	1196091.7428	3145197.7358	P99:TC 38.6	1196019.9254	3145220.5283
P44:38.17	1196093.0616	3145209.3520	P100:FL 37.5	1196018.0995	3145220.8260
P45:37.99	1196095.4078	3145217.4929	P101:38.63	1196018.0845	3145218.7303
P46:38.32	1196090.3123	3145240.0020	P102:39.3	1196018.3676	3145203.4379
P47:HP 38.35	1196097.8994	3145249.1809	P103:38.84	1196010.3261	3145211.4320
P48:TC 38.23	1196100.8295	3145270.4856	P104:38.13	1196002.8319	3145219.3246
P49:38.41	1196089.5375	3145254.6393	P105:38.00	1195998.8099	3145222.9578
P50:TC 38.30	1196095.8836	3145272.8578	P105:38:00	1195992.1403	3145230.1070
P51:FL 37.72	1196100.5503	3145271.2968	P107:37.84	1195987.7216	3145234.2556
1 J I.I L JI.IZ	1196095.9753	3145273.4250	P107.37.84 P108:37.56	1195996.3453	3145245.5794
P52.F1 27 QA 1		3145275.7128	P108.37.56 P109:37.28	1195996.3453	3145238.2753
P52:FL 37.80	1196085 3015	1 1 1 1 1 1 1 1 1 1	1 103.07.20	1100002.7002	0170200.2700
P53:FL 37.78	1196085.3015		P110.27 80	1106006 2885	3145230 4727
	1196085.3015 1196091.4658 1196080.1587	3145273.6445 3145274.9751	P110:37.80 P111:39.34	1196006.2885 1196084.6141	3145230.4727 3145136.2819

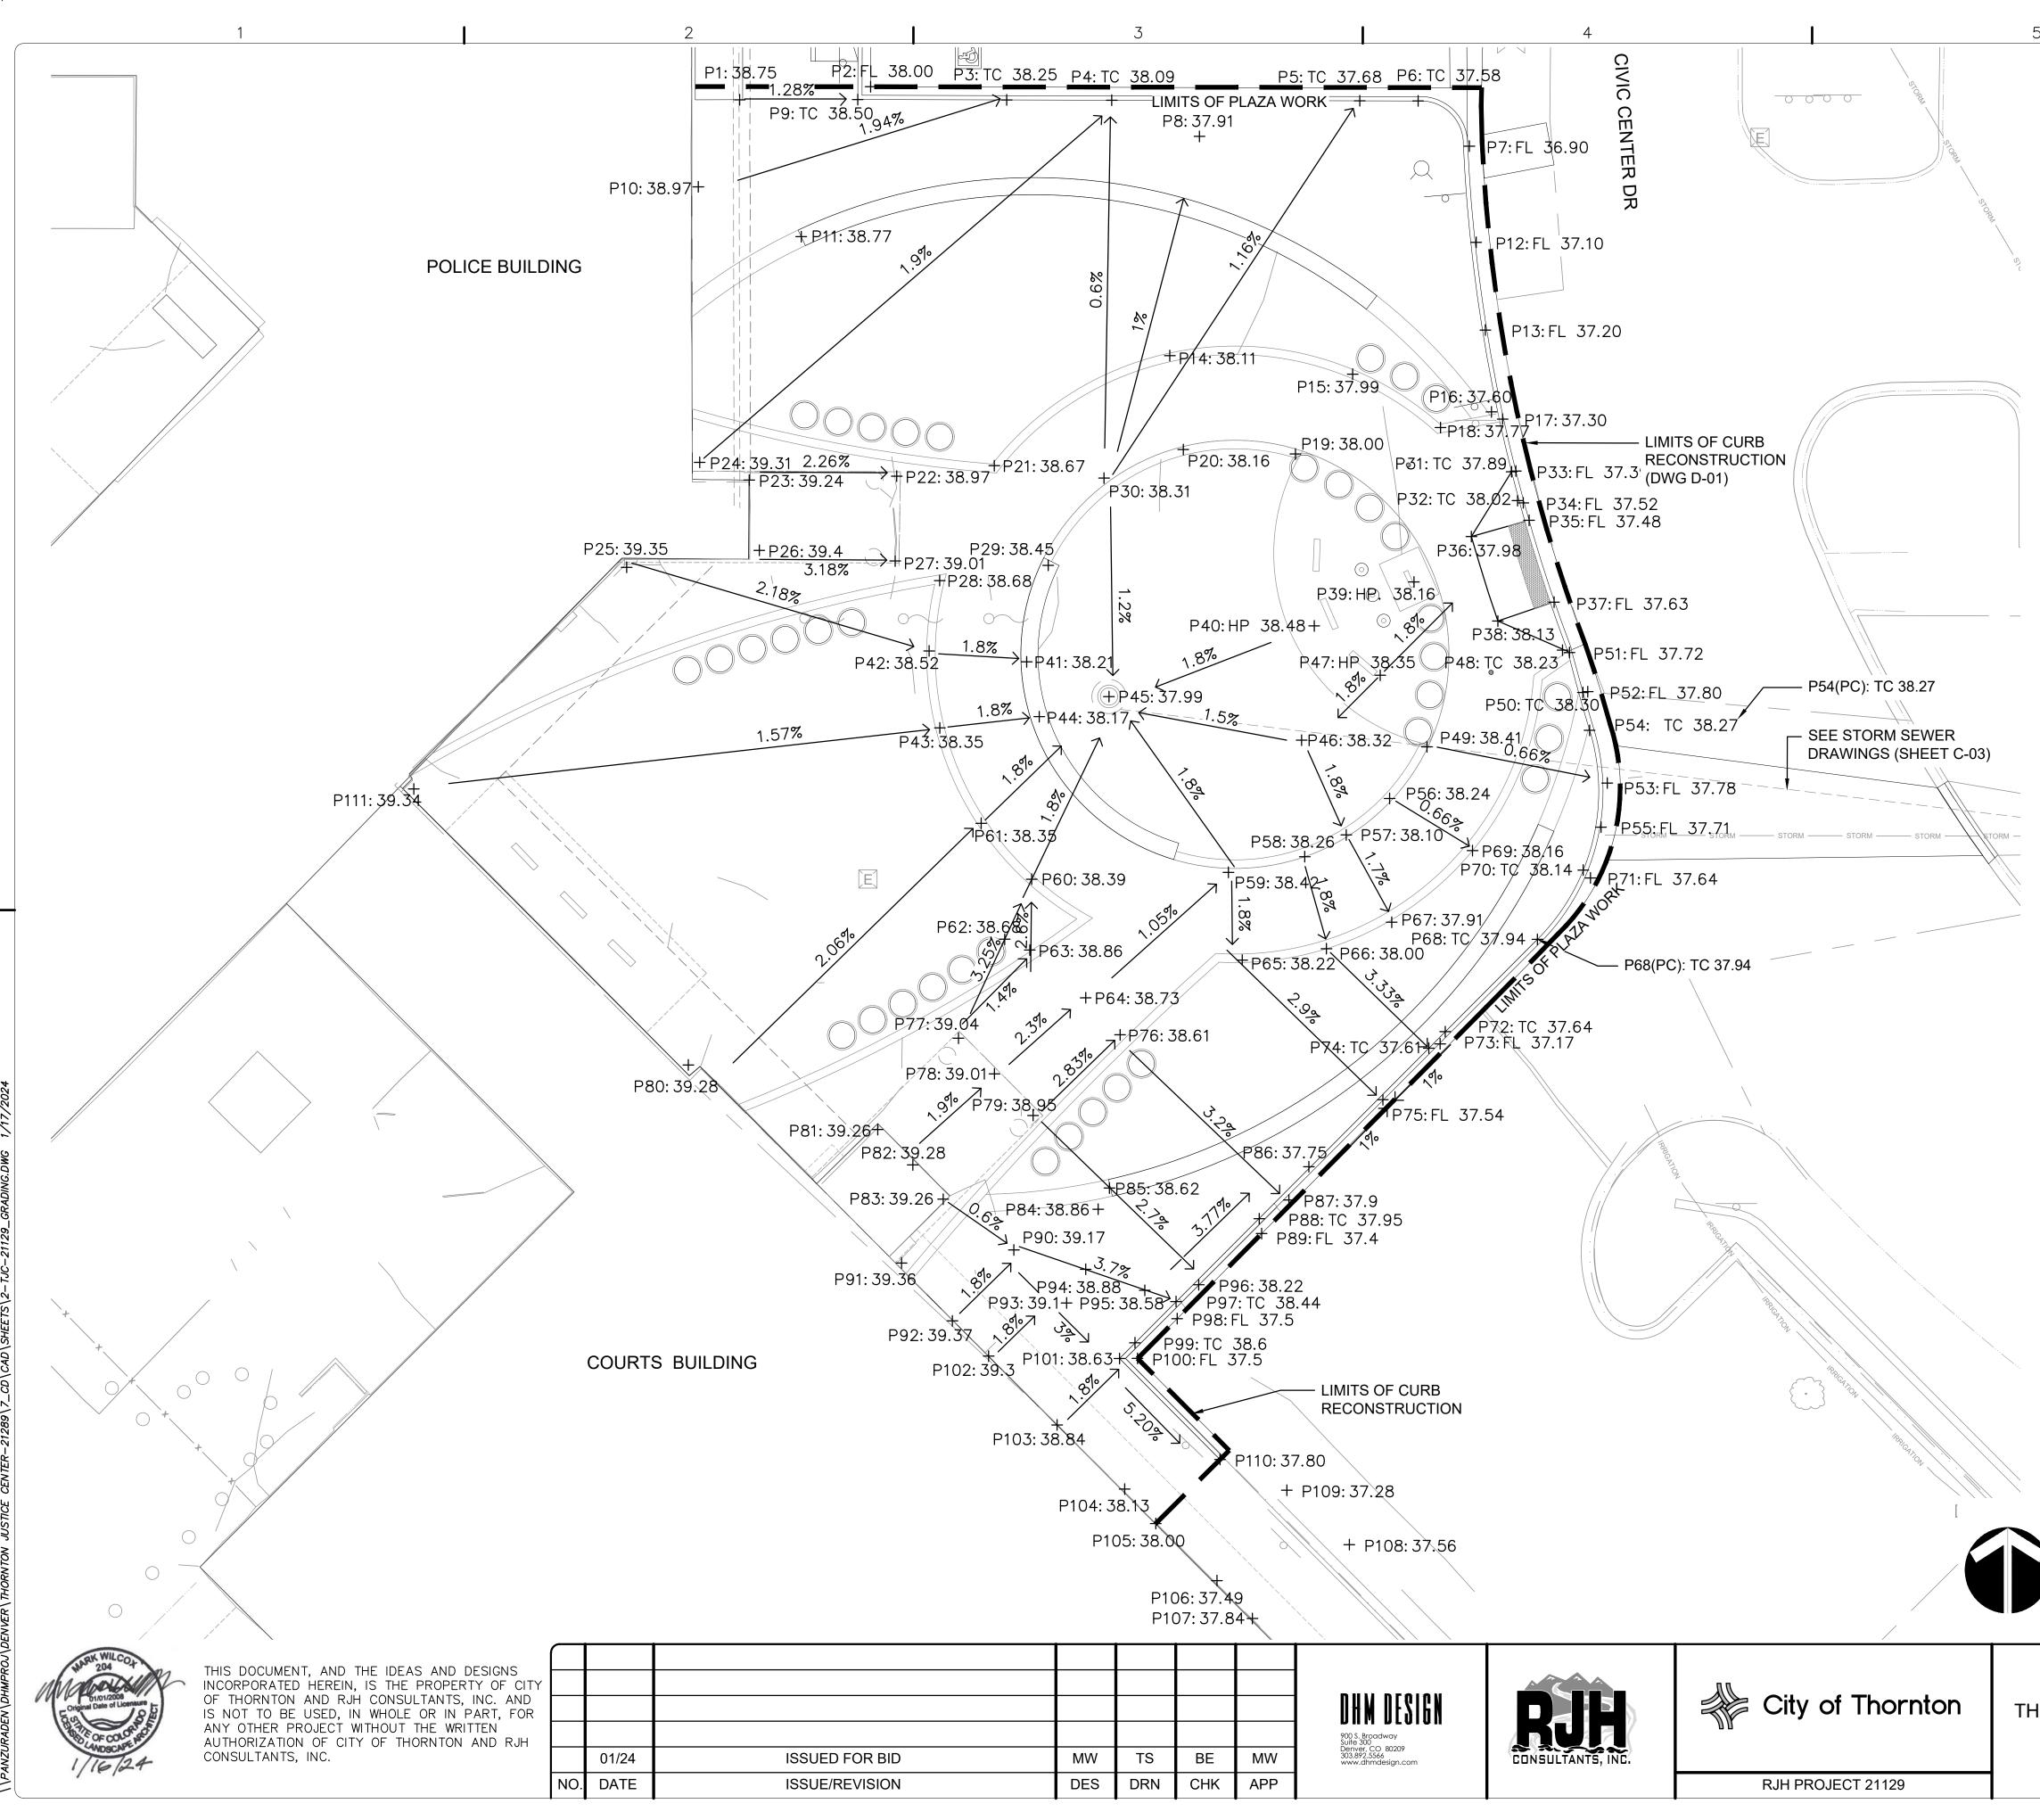


THORNTON JUSTICE CENTER PHASE III

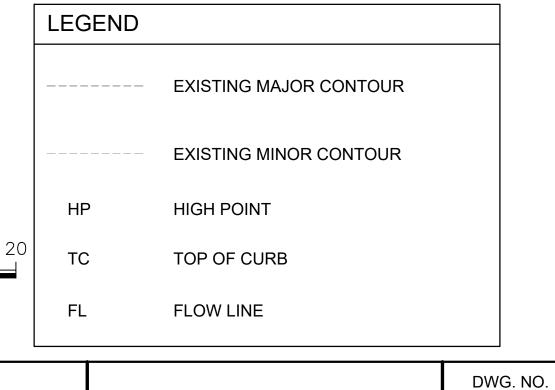1 10 SCALE: 1"=10'-0"


MEMORIAL PLAZA **GRADING PLAN**

SHEET NO. 41 of 46

L-02

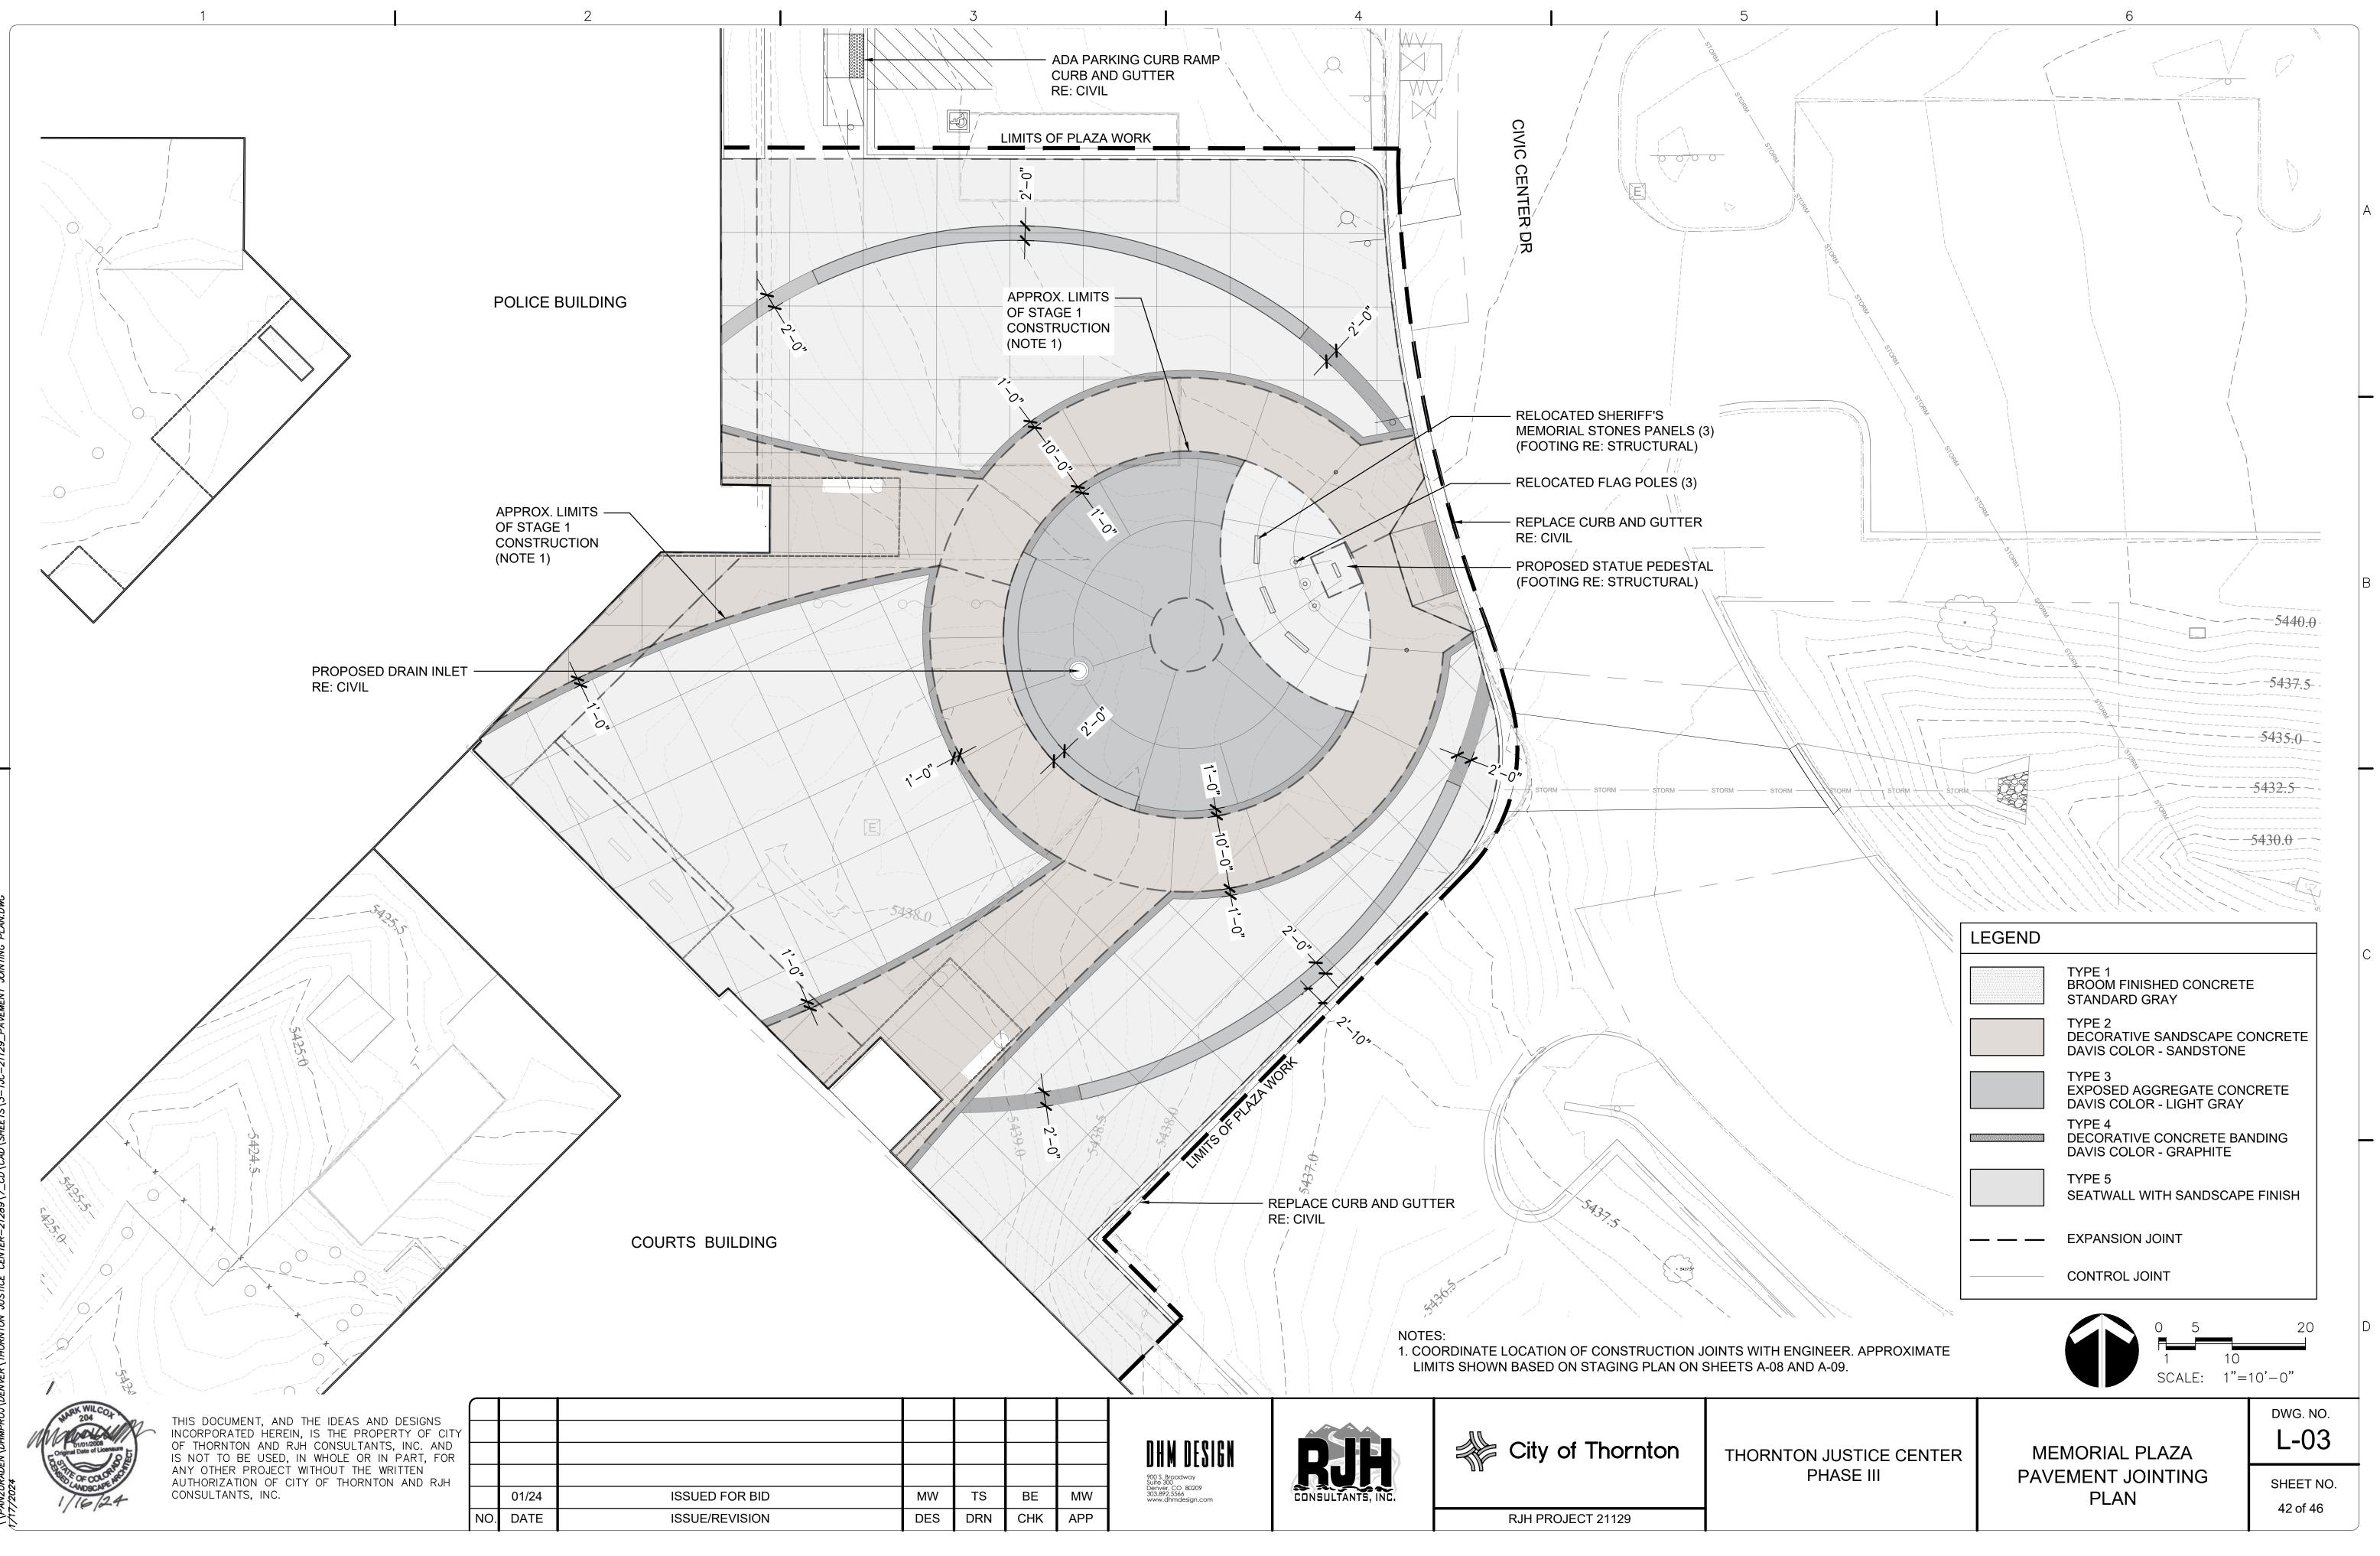

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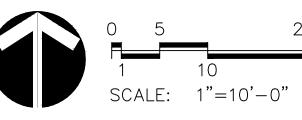

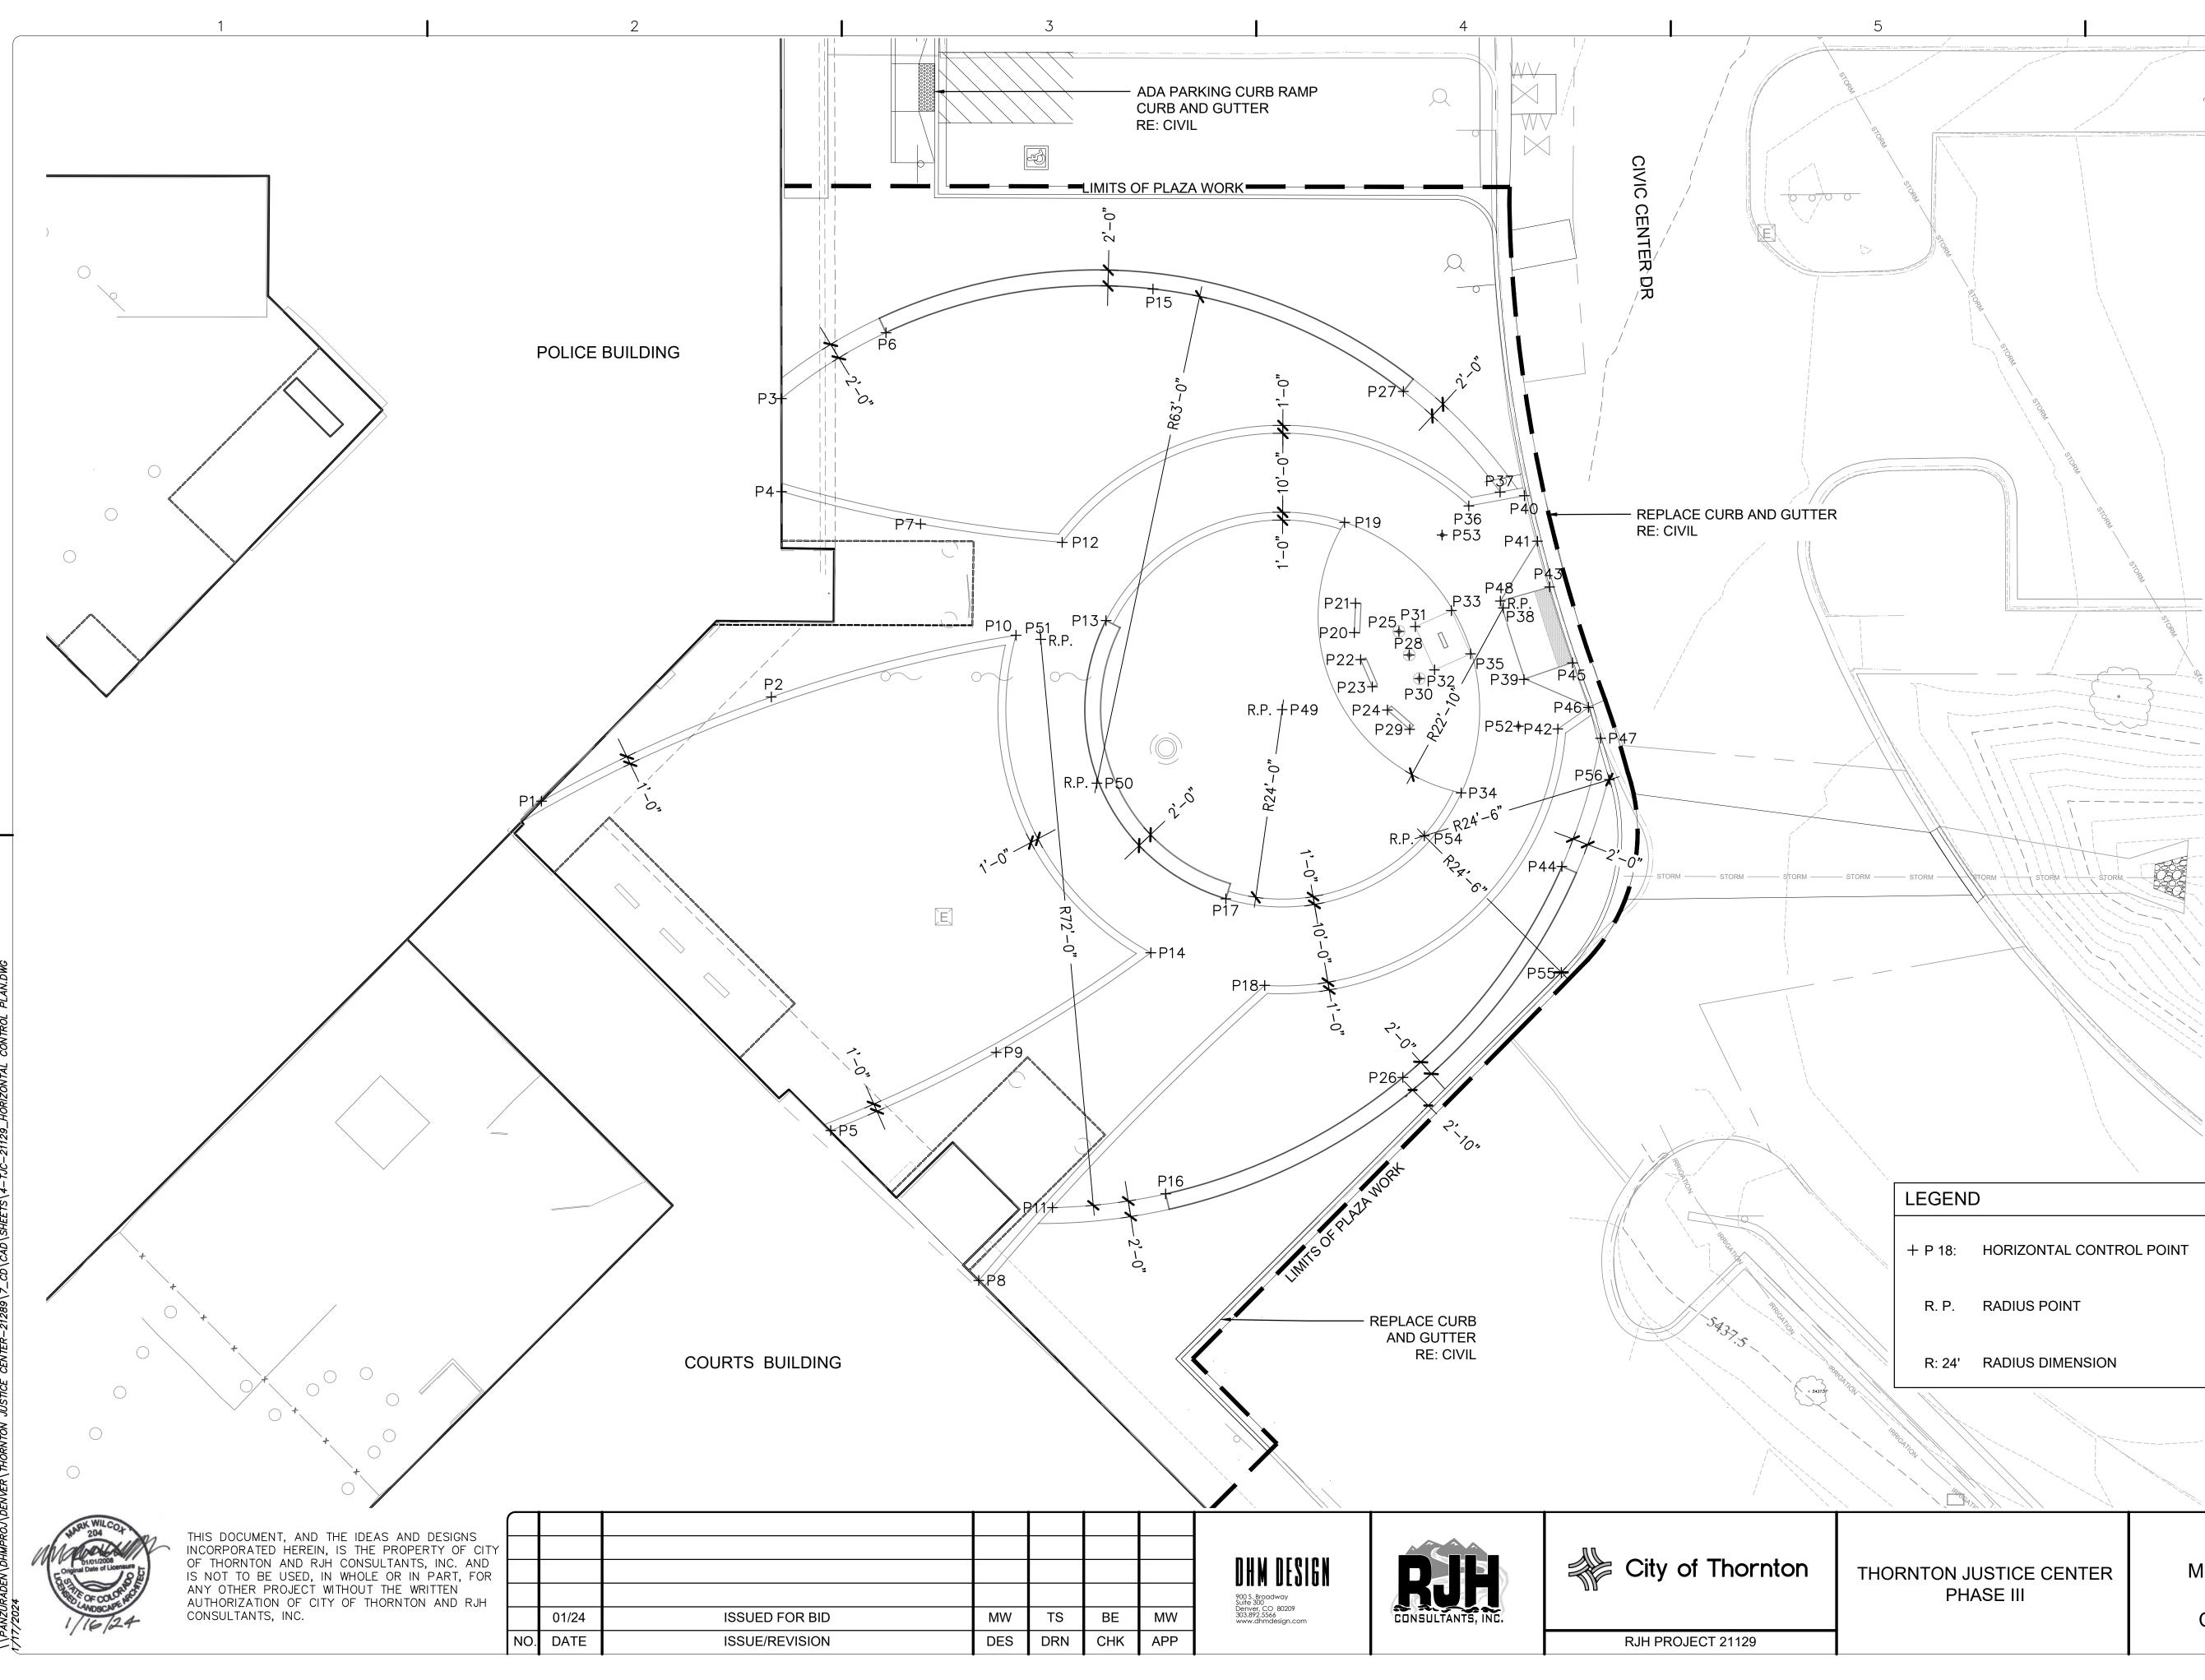
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HORIZONTAL CONTROL POINTS

POINT P1	NORTHING 1196088.7389	EASTING 3145138.3931
P2	1196101.9399	3145167.5013
P3	1196139.7286	3145168.7803
P4	1196127.9560	3145168.7995
P5	1196047.0115	3145175.0292
P6	1196148.0765	3145182.0288
P7	1196123.8555	3145186.4135
P8	1196028.0206	3145193.7781
P9	1196056.9267	3145195.9802
P10	1196109.7537	3145198.4931
P11	1196037.2529	3145203.1138
P12	1196121.5221	3145204.3462
P13	1196111.6156	3145209.8931
P14	1196069.5343	3145215.5668
P15	1196153.6119	3145215.8395
P16	1196038.9968	3145217.4426
P17	1196076.3673	3145225.0709
P18	1196065.3993	3145229.9856
P19	1196124.0454	3145240.1086
P20	1196110.0809	3145241.3315
P21	1196113.8210	3145241.4858
P22	1196106.6686	3145242.1423
P23	1196103.2305	3145243.6227
P24	1196100.2866	3145245.5309
P25	1196110.2389	3145246.9969
P26	1196053.7397	3145247.4928
P27	1196140.6331	3145247.5498
P28	1196107.2552	3145248.2855
P29	1196097.8285	3145248.3540
-		
P30	1196104.2716 1196110.8539	3145249.5742
P31		3145249.0659
P32	1196105.3705	3145251.5014
P33	1196112.8835	3145253.6354
P34	1196089.7769	3145254.8643
P35	1196107.4001	3145256.0710
P36	1196126.1385	3145255.8411
P37	1196127.8892	3145259.8106
P38	1196113.2258	3145260.2062
P39	1196104.1485	3145262.8229
P40	1196127.4404	3145262.8840
P41	1196121.6684	3145264.5320
P42	1196097.8858	3145267.1150
P43	1196115.8733	3145266.0866
P44	1196080.4767	3145267.6296
P45	1196106.2572	3145268.9714
P46	1196100.6091	3145270.9958
P47	1196096.6977	3145272.5230
P48	1196114.0919	3145259.8355
P49	1196100.3292	3145232.2004
P50	1196091.0146	3145208.7296
P51	1196109.2375	3145201.6234
P52	1196098.2349	3145262.1271
P53	1196122.4514	3145252.4636
P54	1196084.3493	3145250.2009
-		
P55	1196067.0510	3145267.5508
P56	1196091.4658	3145273.6445

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 + P 18:	HORIZONTAL CONTROL POINT
R. P.	RADIUS POINT
R: 24'	RADIUS DIMENSION
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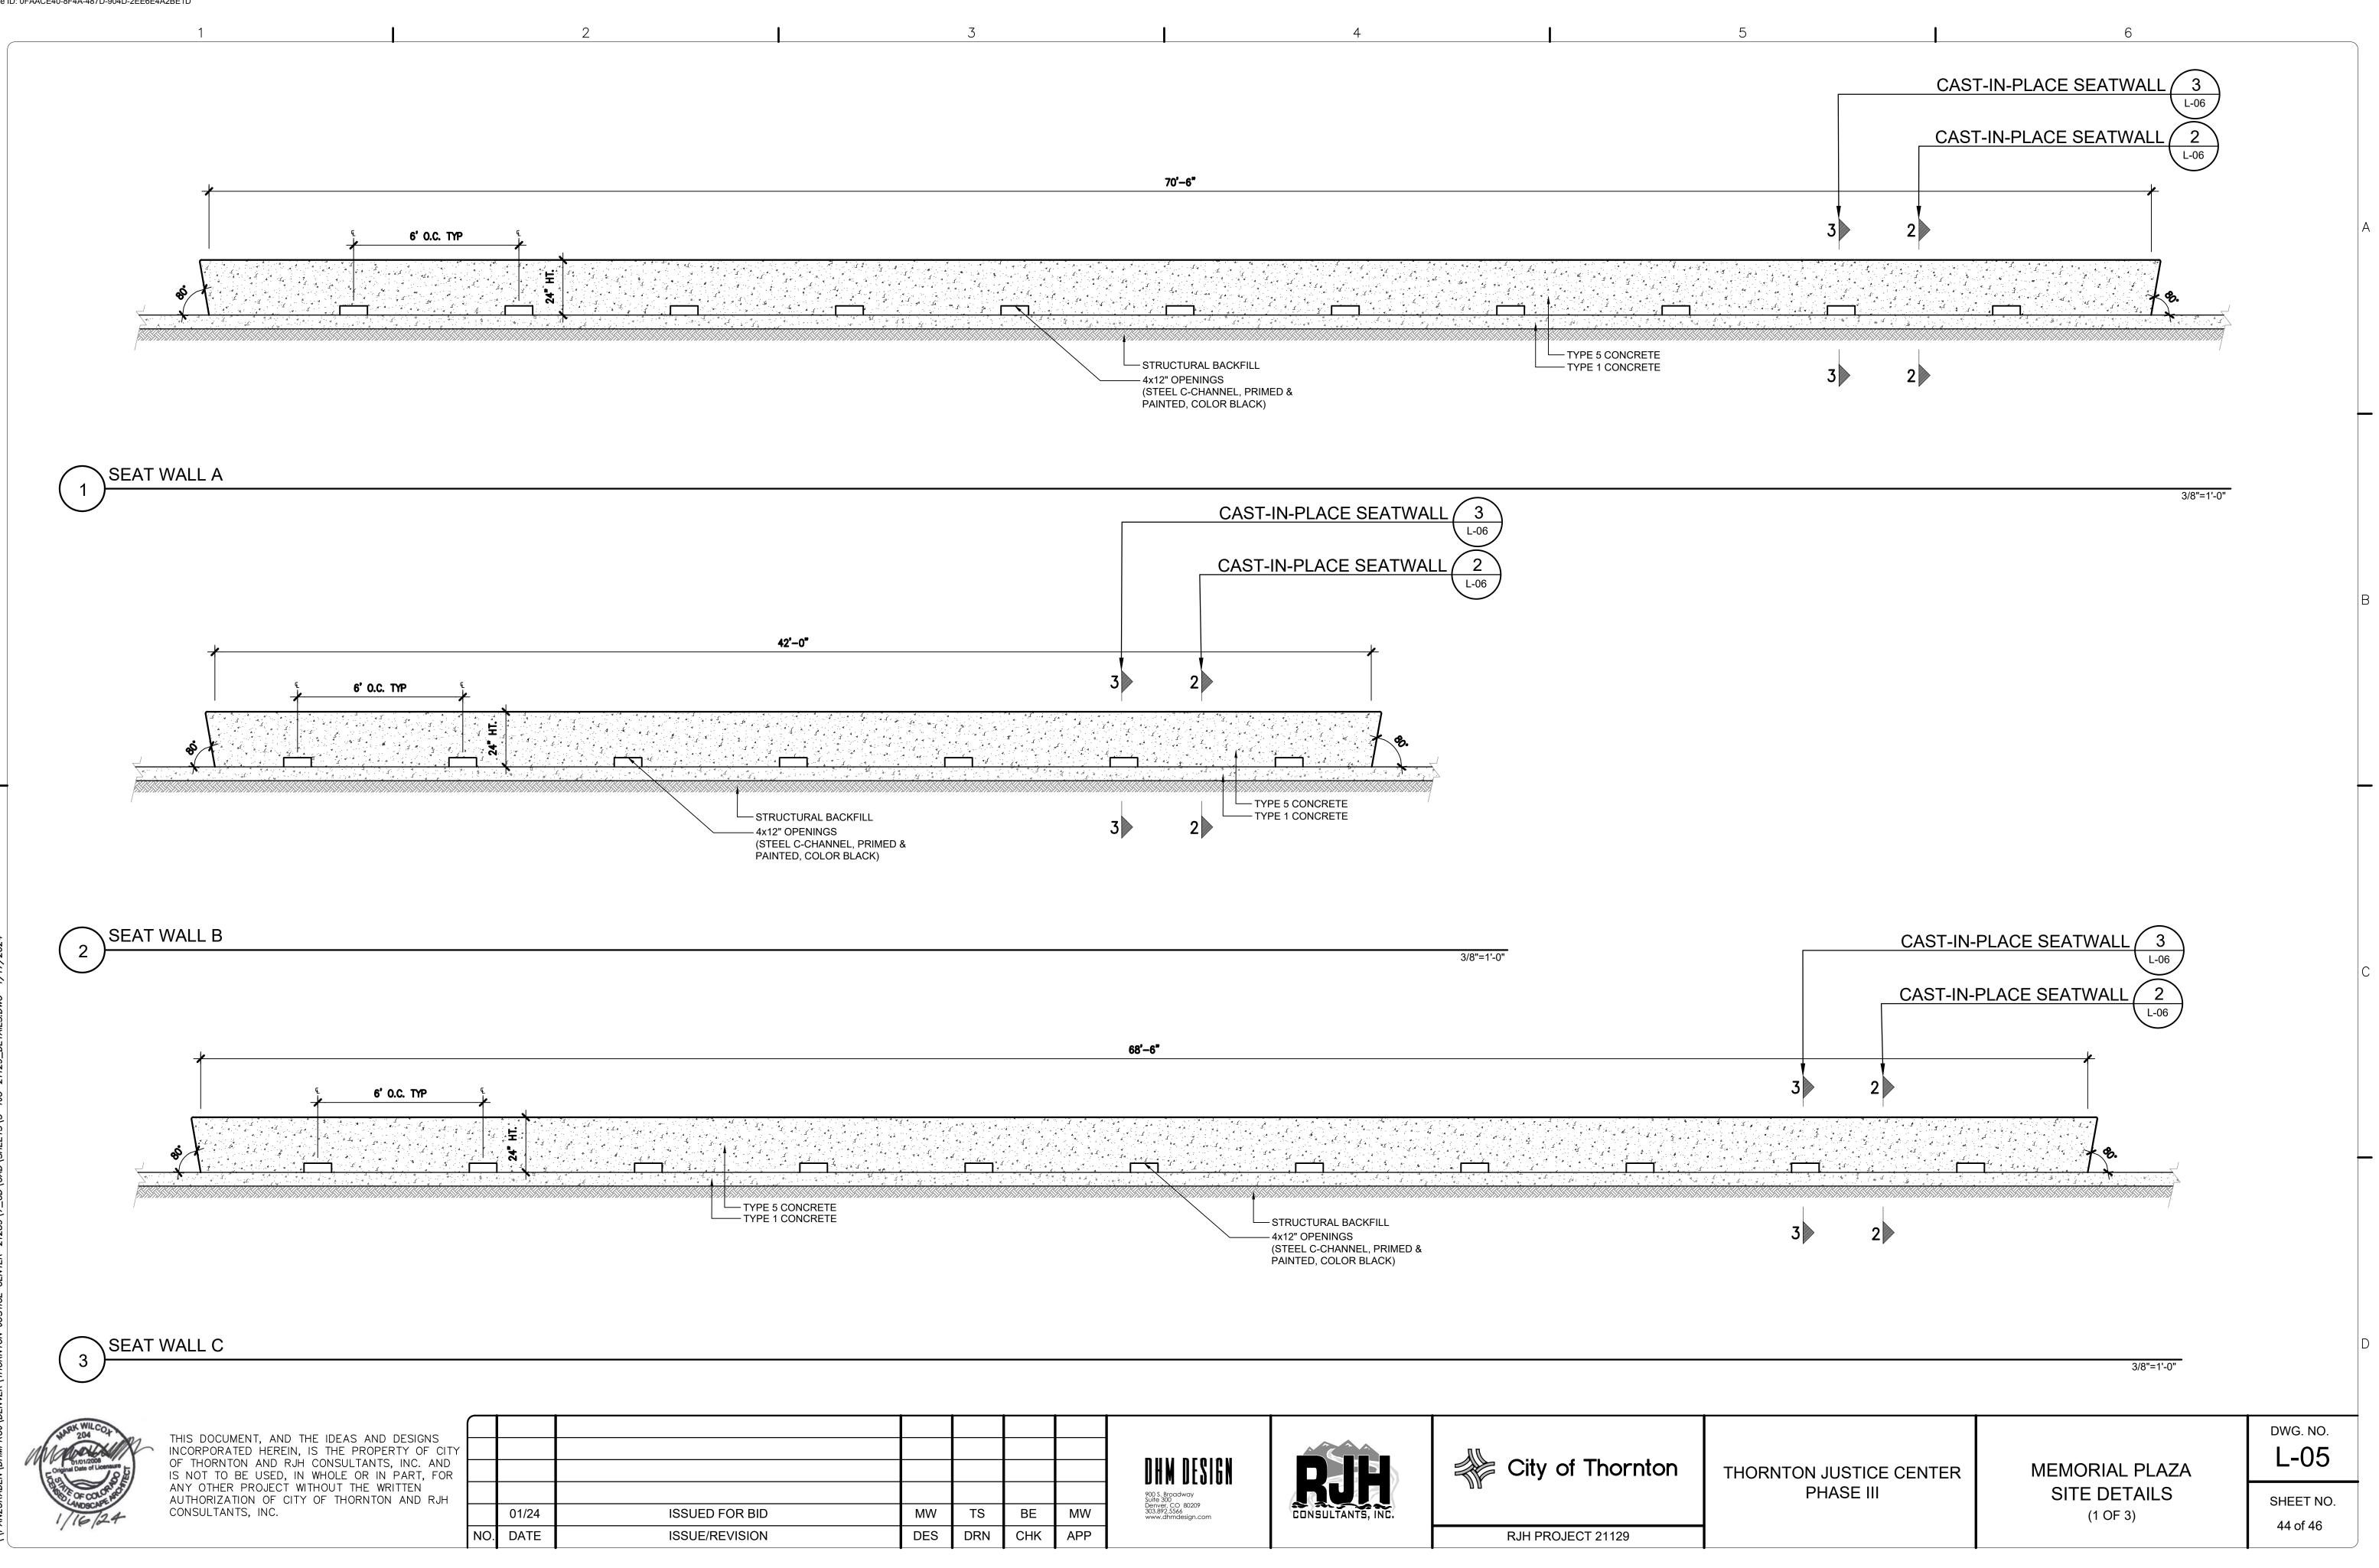


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	DWG. NO.
	L-04


MEMORIAL PLAZA HORIZONTAL CONTROL PLAN


SHEET NO. 43 of 46

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DES	DRN	СНК	APP



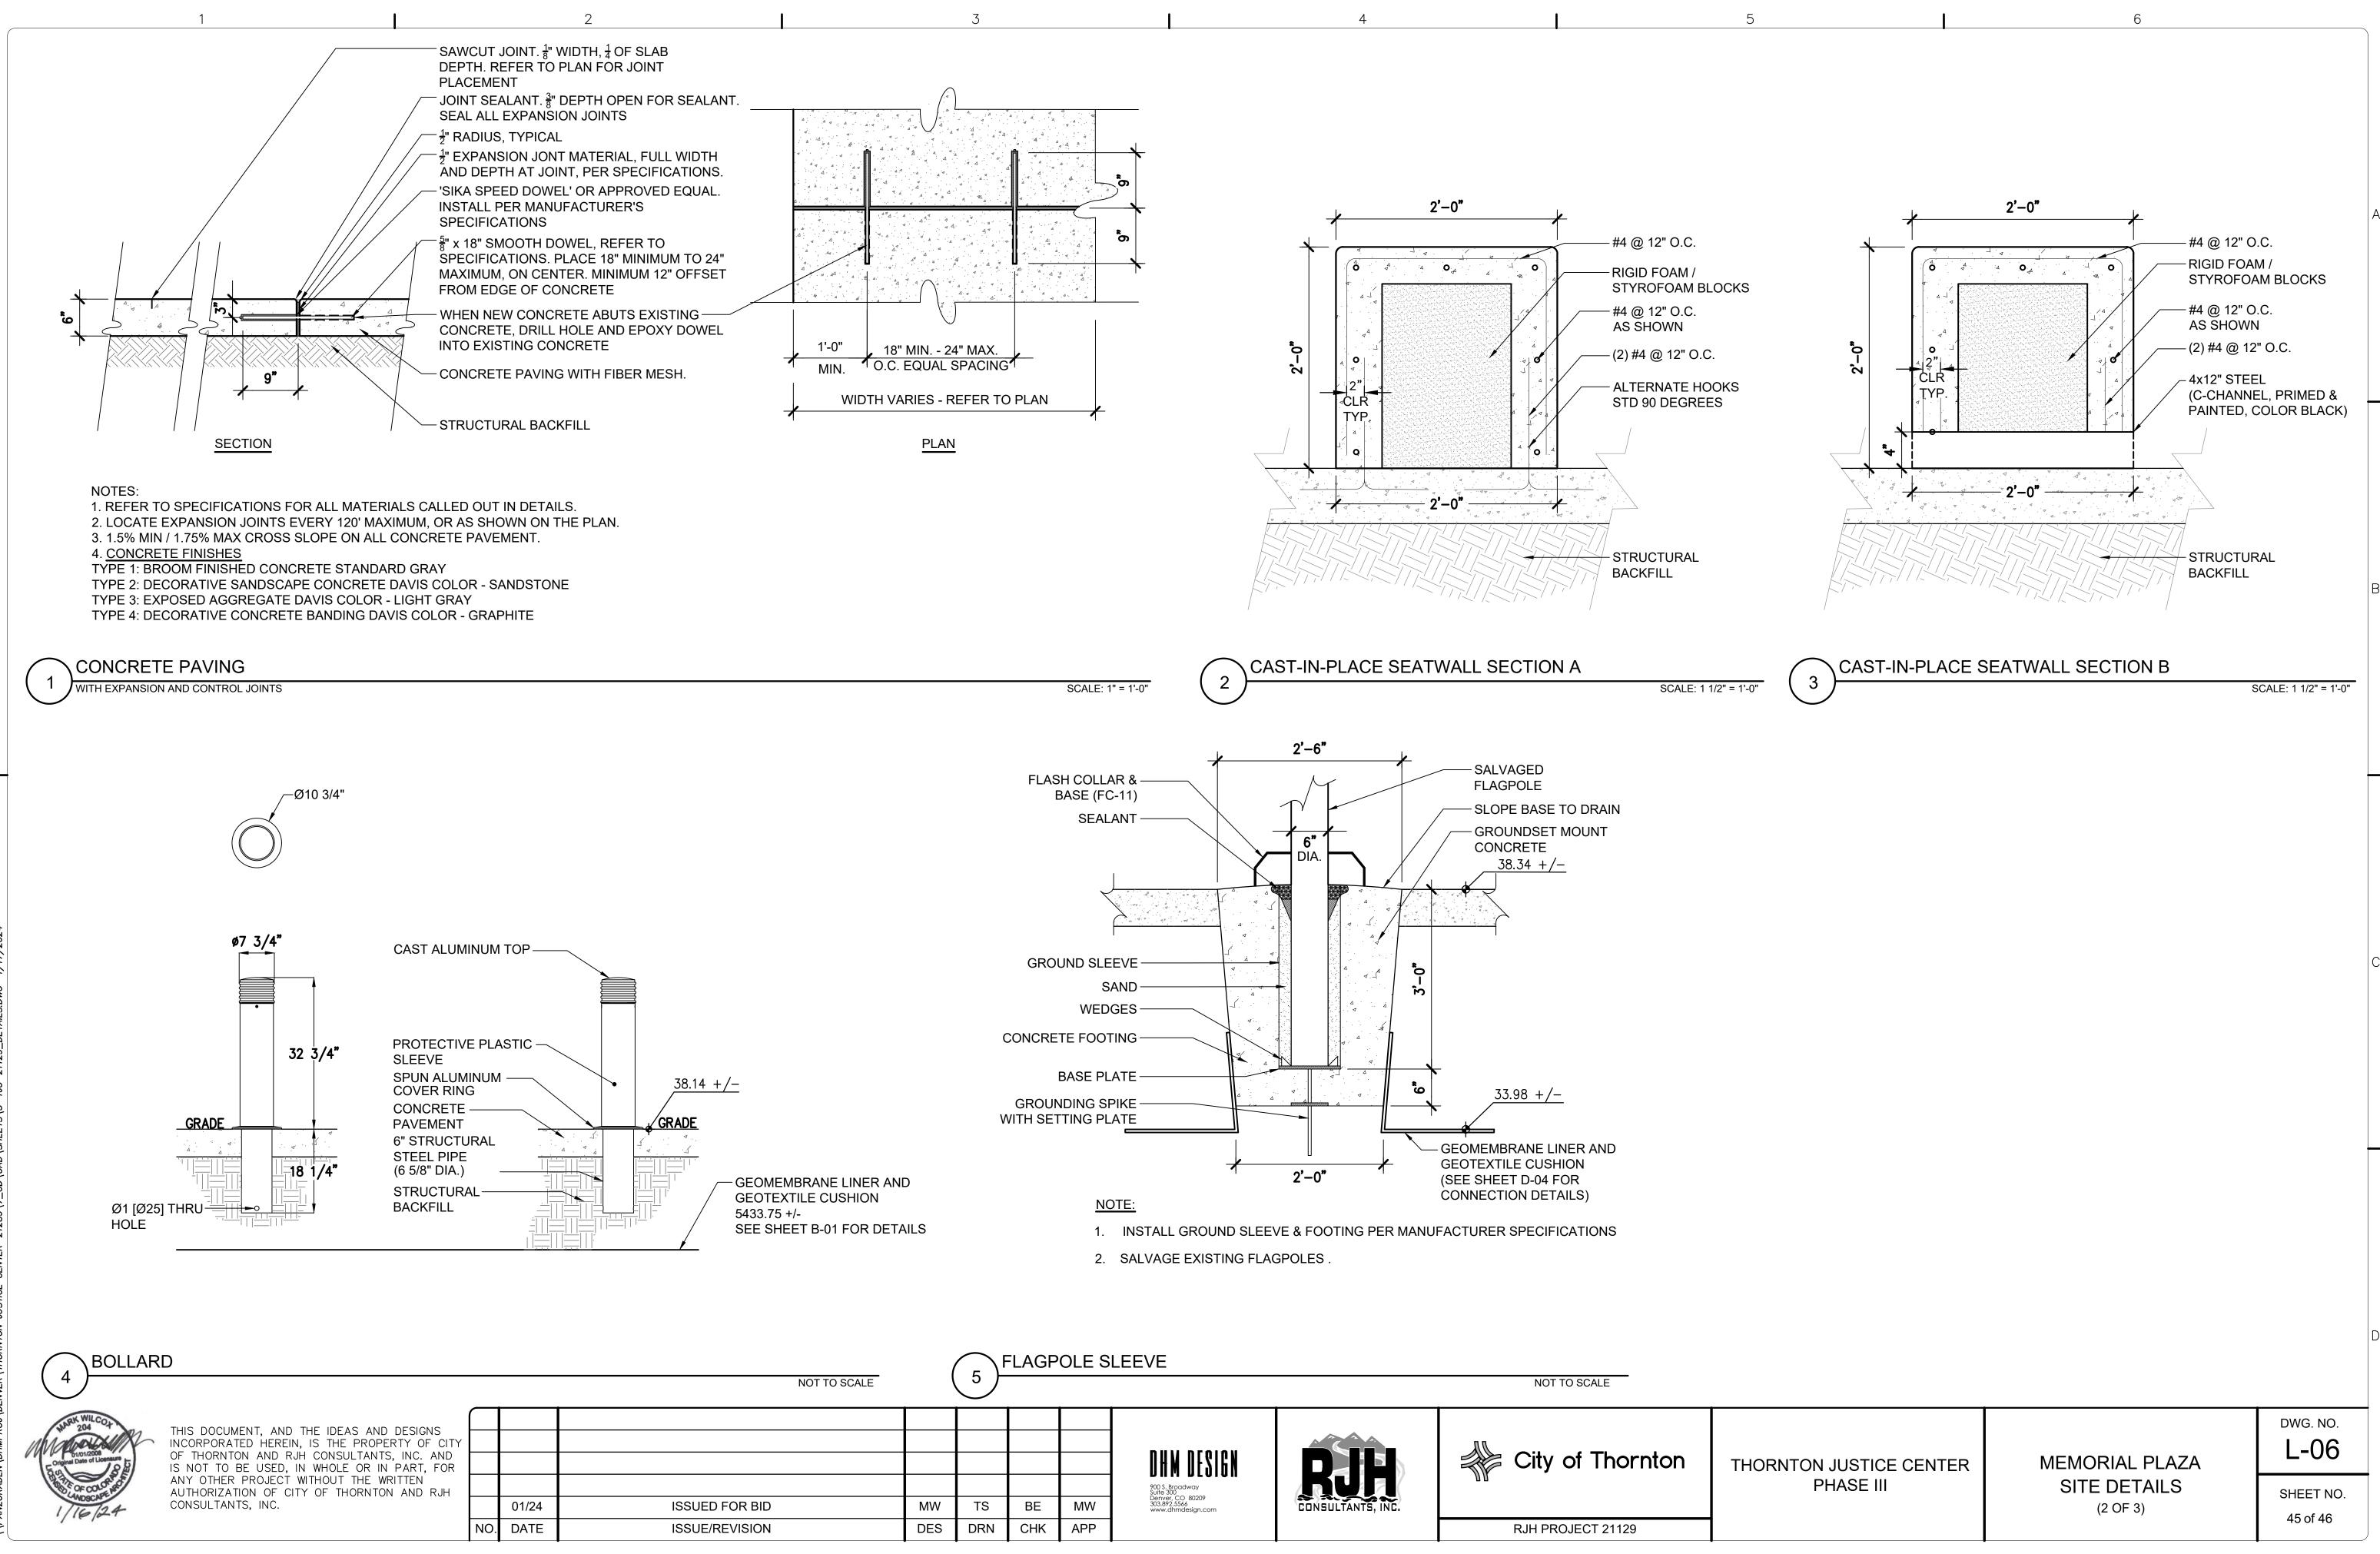

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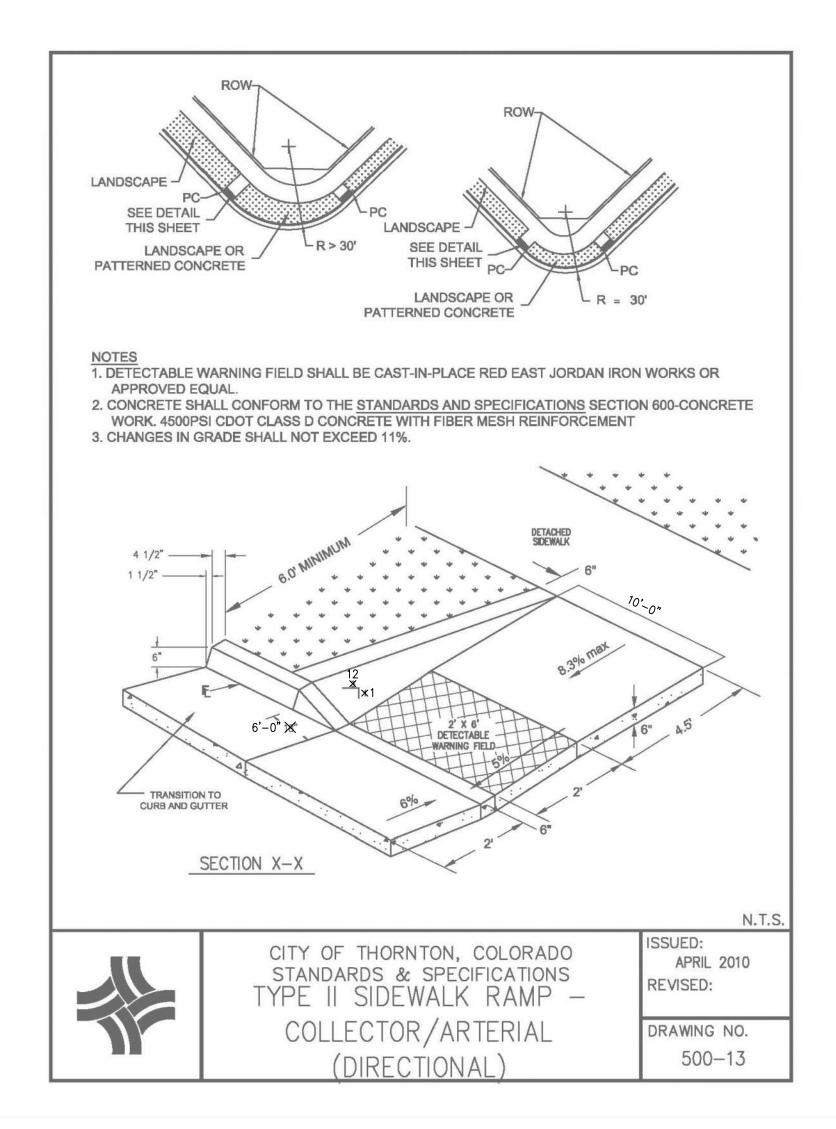
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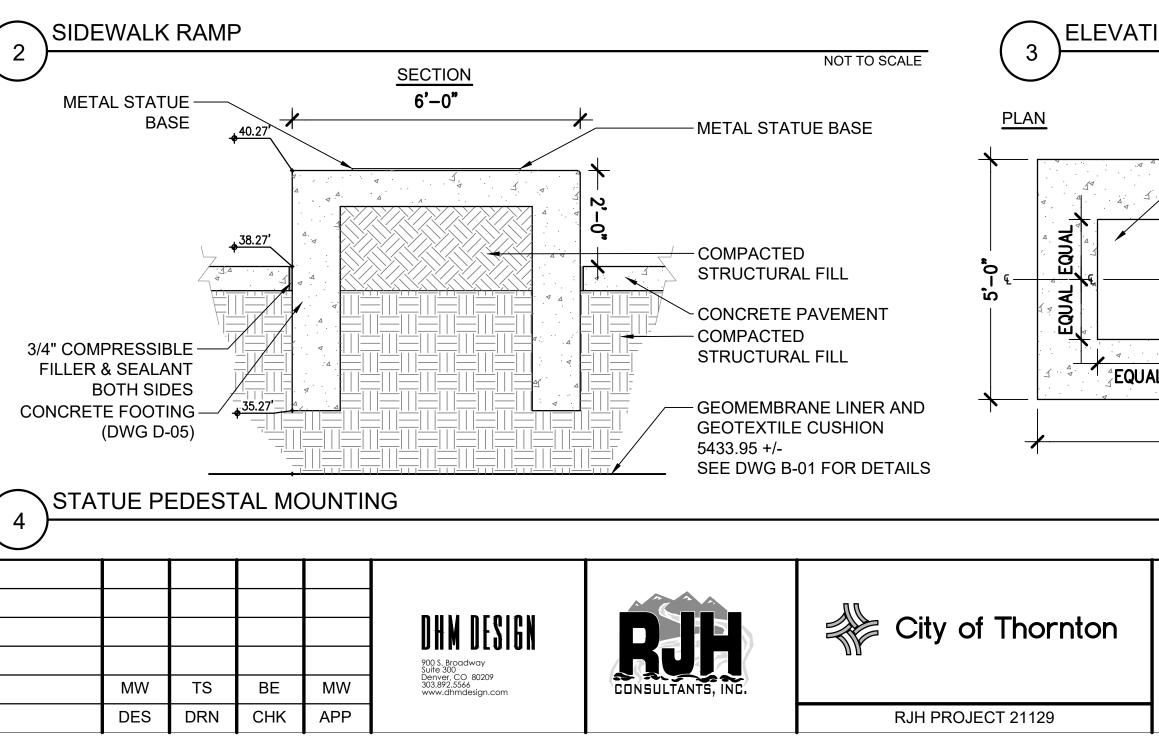
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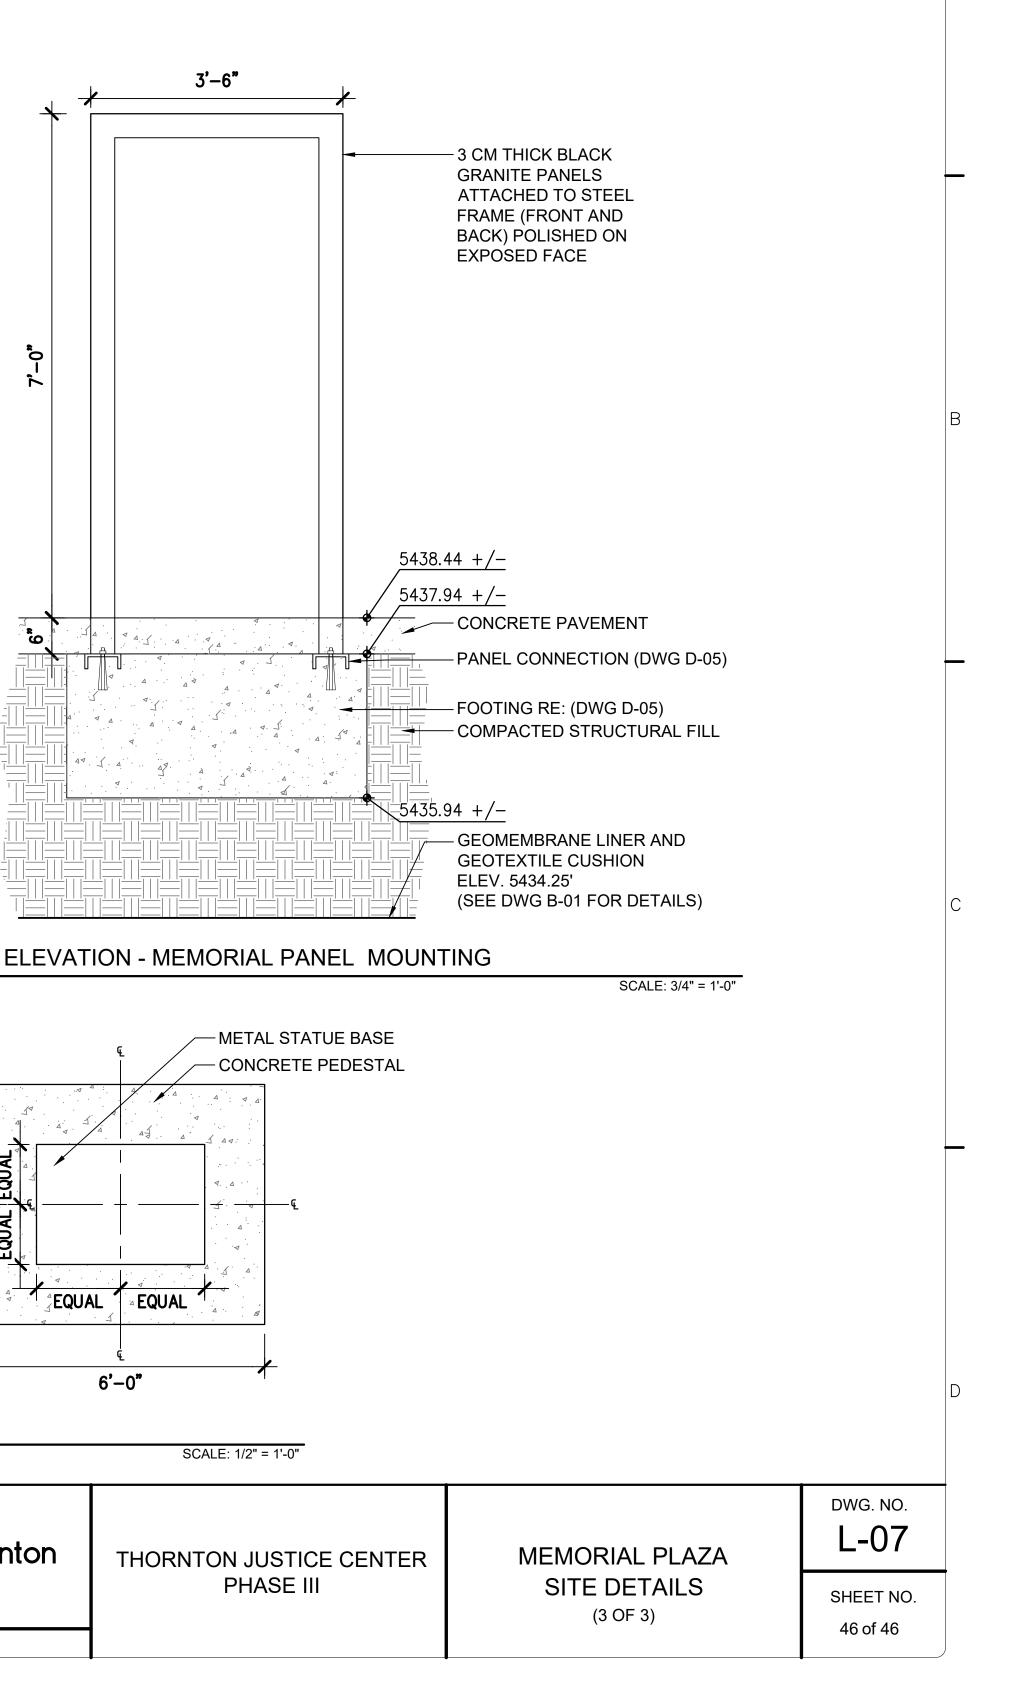
DATE
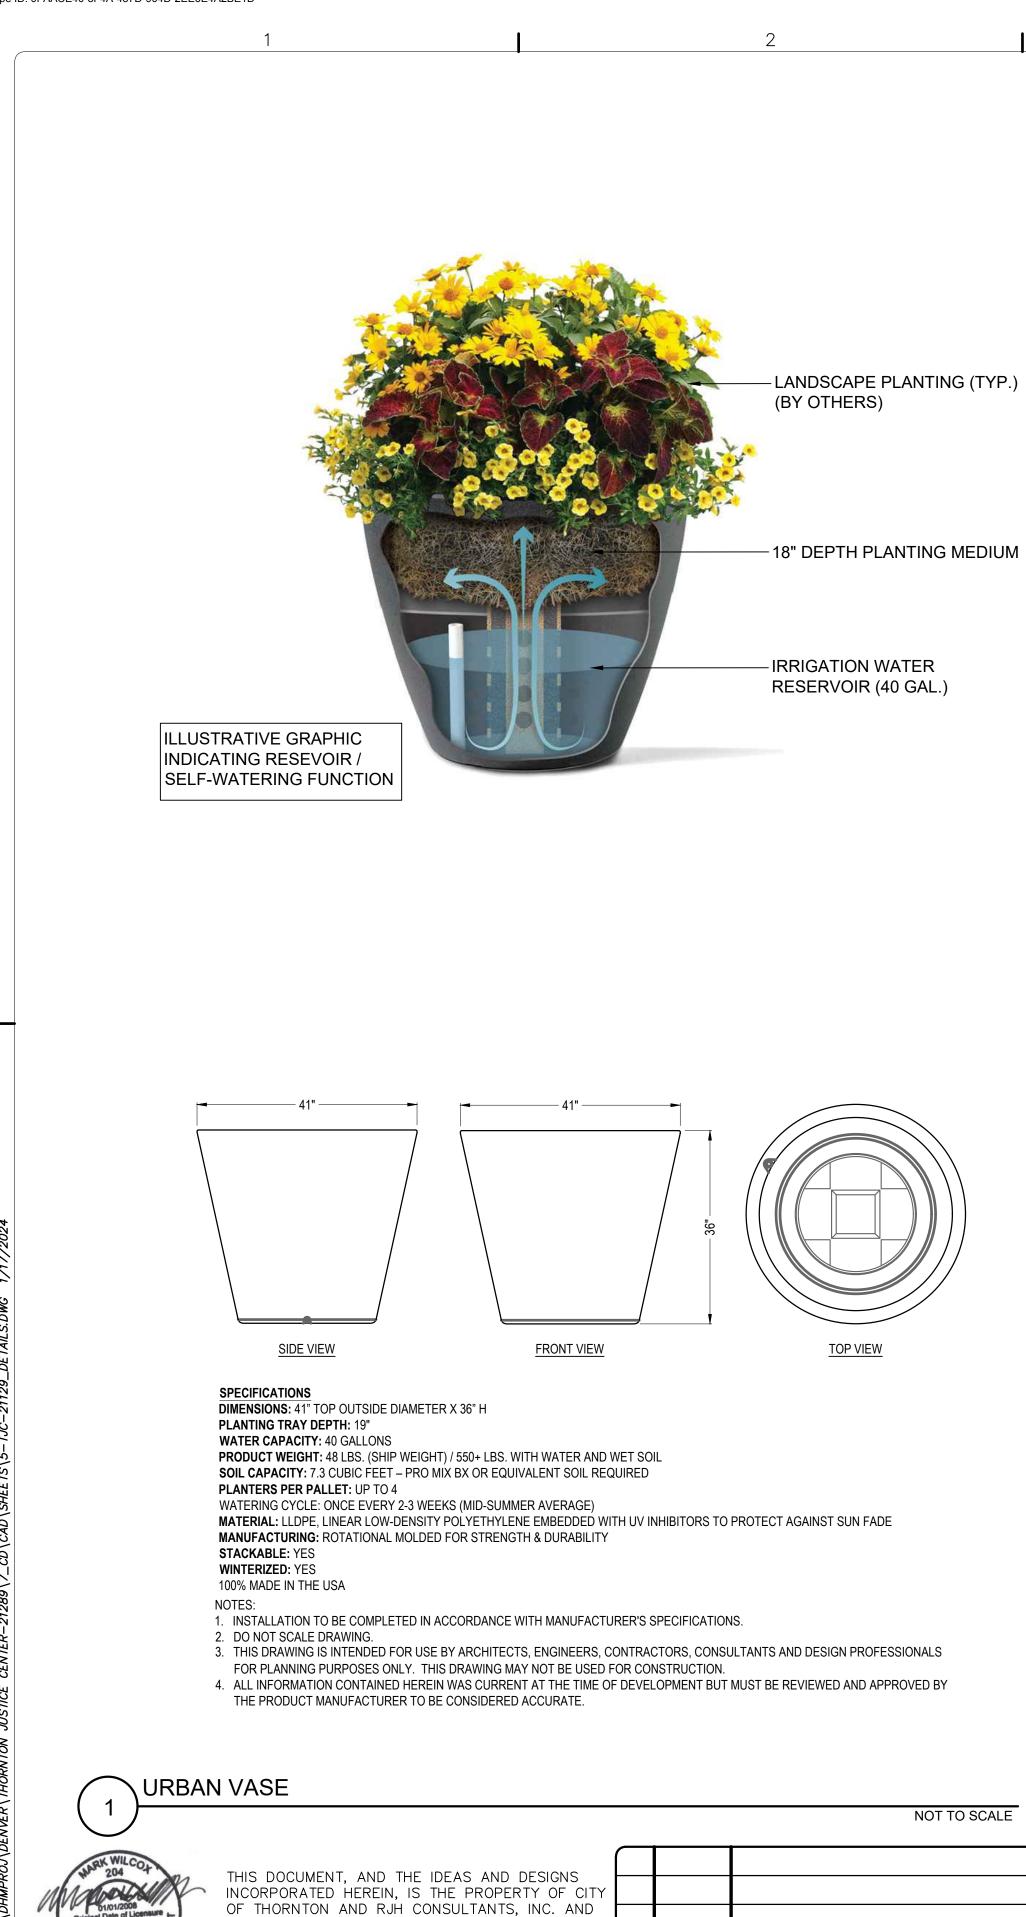
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Signer Events

Daniel Schiltz Daniel.Schiltz@thorntonco.gov Security Level: Email, Account Authentication (None)

Electronic Record and Signature Disclosure:

Accepted: 1/18/2024 8:00:46 AM ID: 350683f6-d9dc-401b-80b8-bda3cf286f41

Pete Brezall

pete.brezall@thorntonco.gov Project Manager

Security Level: Email, Account Authentication (None)

Electronic Record and Signature Disclosure: Accepted: 1/18/2024 8:08:33 AM

ID: 154c0161-45c7-4031-92ee-3aa3619366b9

Holder: Katie Kantor	
Katie.Kantor@thorntonco.gov	

Signature Adoption: Pre-selected Style Using IP Address: 199.117.212.4

Signature Adoption: Pre-selected Style

Using IP Address: 199.117.212.4

Status: Completed

Envelope Originator: Katie Kantor 9500 Civic Center Drive Thornton, CO 80229 Katie.Kantor@thorntonco.gov IP Address: 199.117.212.4

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Agent Delivery Events	Status	Timestamp
Intermediary Delivery Events	Status	Timestamp
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DocuSigned by:

Pete Brezall

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Payment Events	Status	Timestamps

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To advise SHI OBO City of Thornton of your new email address

To let us know of a change in your email address where we should send notices and disclosures electronically to you, you must send an email message to us at clerk@ThorntonCO.gov and in the body of such request you must state: your previous email address, your new email address. We do not require any other information from you to change your email address.

If you created a DocuSign account, you may update it with your new email address through your account preferences.

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To request delivery from us of paper copies of the notices and disclosures previously provided by us to you electronically, you must send us an email to clerk@ThorntonCO.gov and in the body of such request you must state your email address, full name, mailing address, and telephone number. We will bill you for any fees at that time, if any.

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Required hardware and software

The minimum system requirements for using the DocuSign system may change over time. The current system requirements are found here: <u>https://support.docusign.com/guides/signer-guide-signing-system-requirements</u>.

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- Until or unless you notify SHI OBO City of Thornton as described above, you consent to receive exclusively through electronic means all notices, disclosures, authorizations, acknowledgements, and other documents that are required to be provided or made available to you by SHI OBO City of Thornton during the course of your relationship with SHI OBO City of Thornton.